


BROOD STOCK BUILDING


ARCHITECTURAL & STRUCTURAL

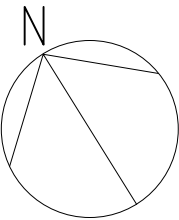

SITE PLAN

SCALE 1:100

+ + + +	PROJECT: BROOD STOCK	ARCHITECTURAL DESIGN	STRUCTURAL DESIGN	DWG NO: A - 01/ 05	<div>■■■■ CHARRETTE ■■■■ STUDIO</div>
	CLIENT: MINISTRY OF FISHERIES & AGRI	DESIGNED BY: - HUSSAIN ZIYATH	DESIGNED BY: - ADAM SAANEEZ		
	DATE: APRIL 2018				
	DO NOT SCALE THE DRAWING				

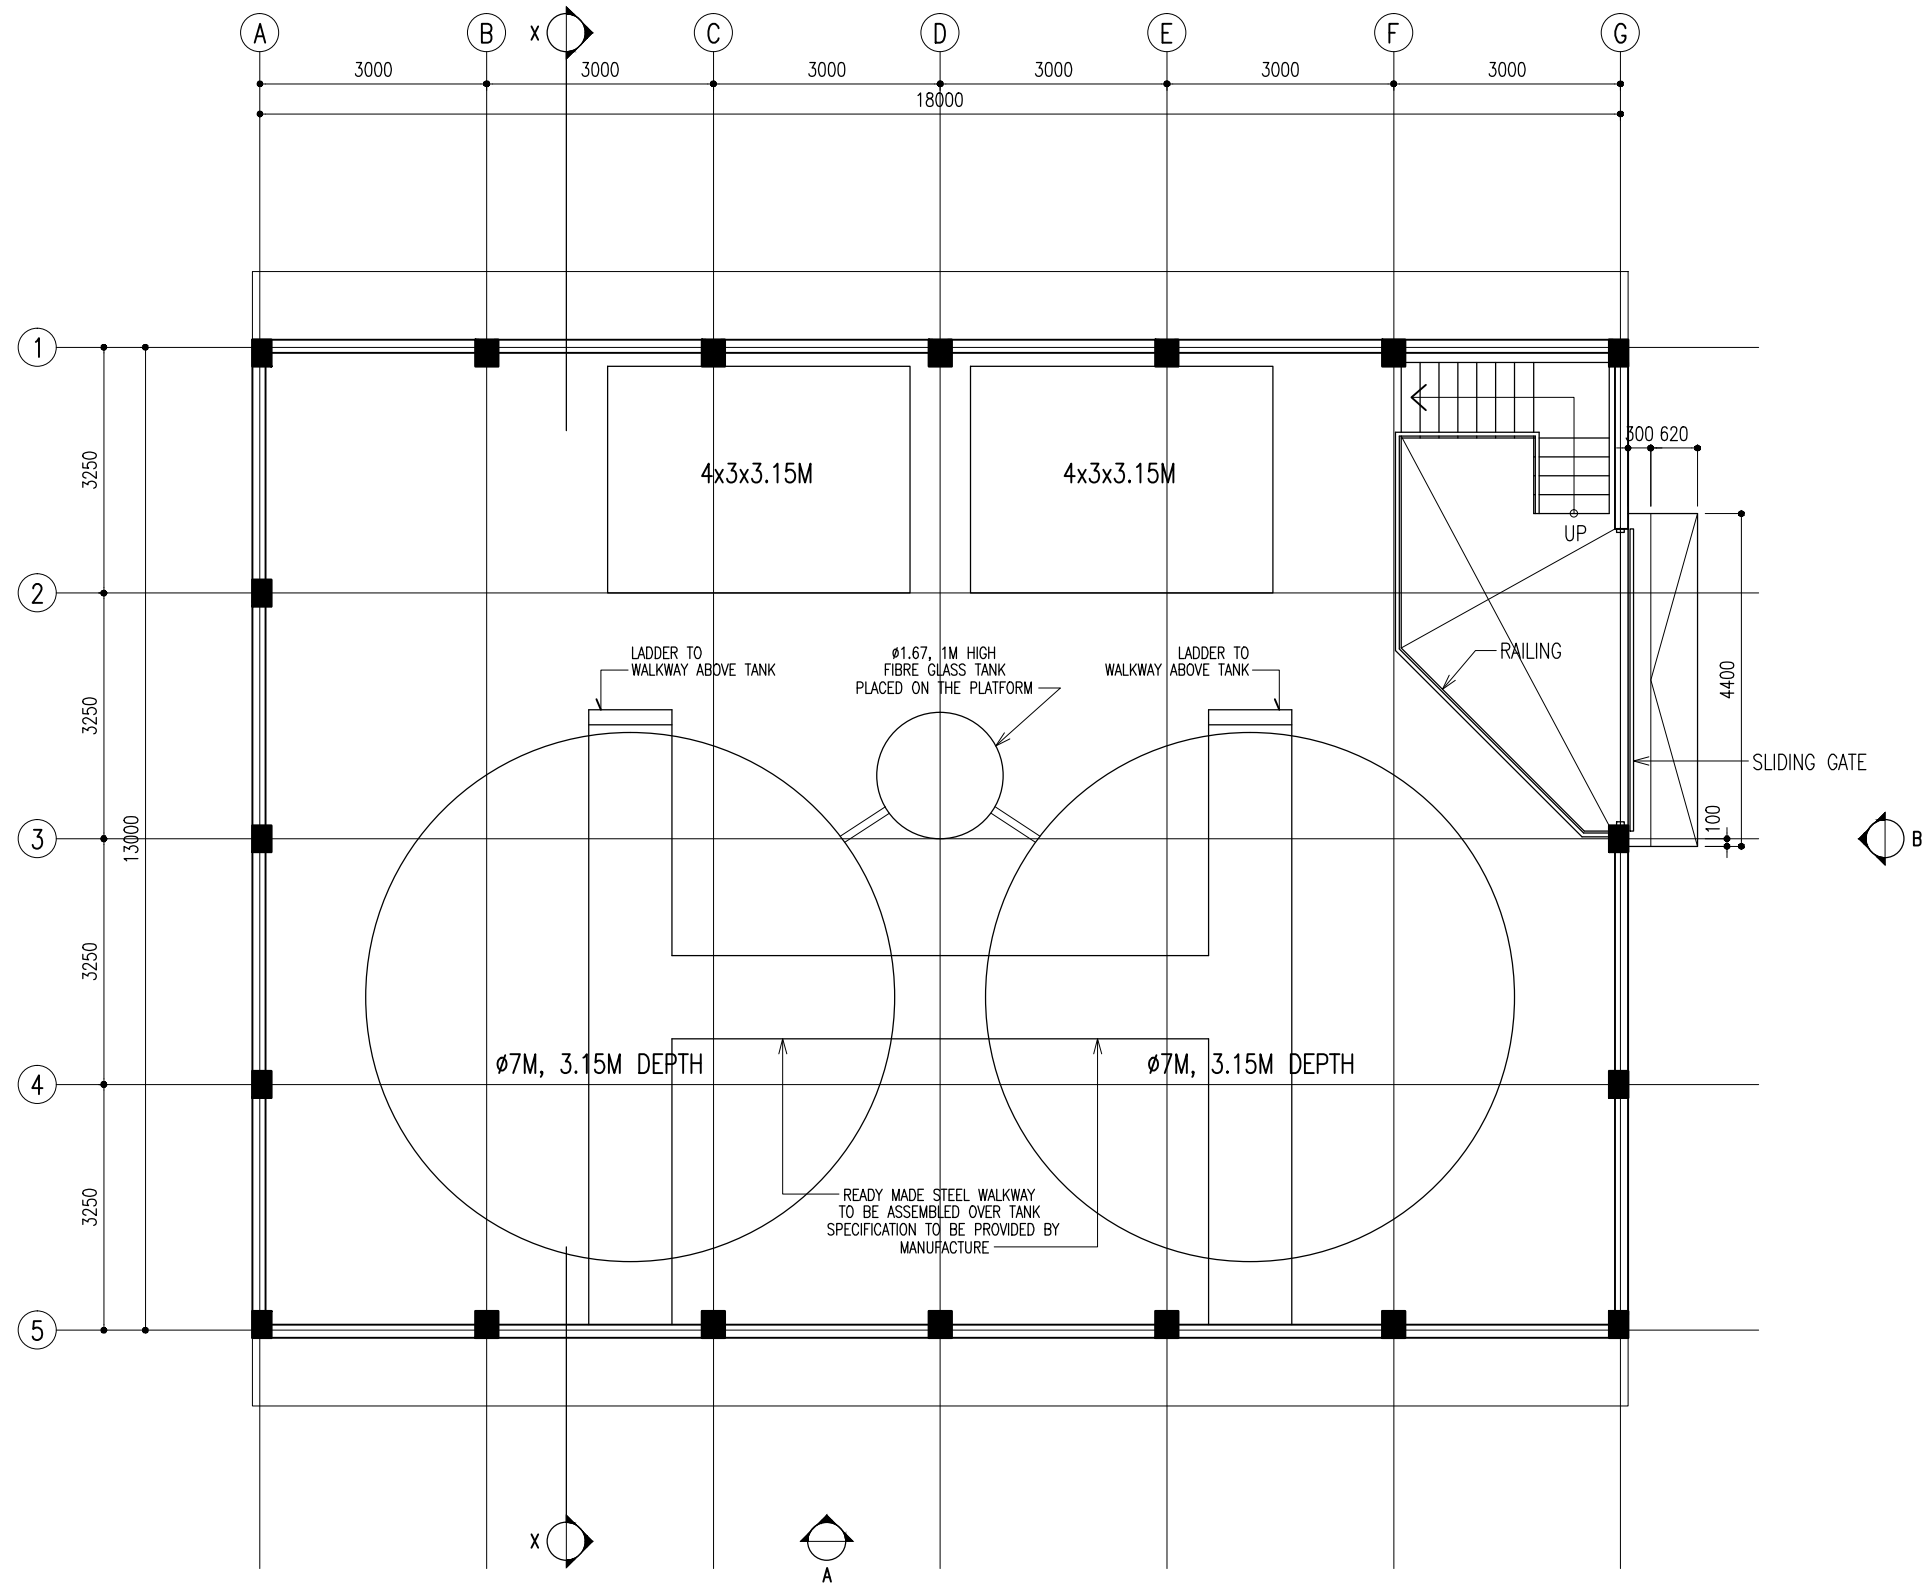

FLOOR LAYOUT PLAN

SCALE 1:100

PROJECT: BROOD STOCK
CLIENT: MINISTRY OF FISHERIES & AGRI
DATE: APRIL 2018
DO NOT SCALE THE DRAWING


ARCHITECTURAL DESIGN
DESIGNED BY: - HUSSAIN ZIYATH

STRUCTURAL DESIGN
DESIGNED BY: - ADAM SAANEEZ

DWG NO:

A - 02/ 05

CHARRETTE
STUDIO

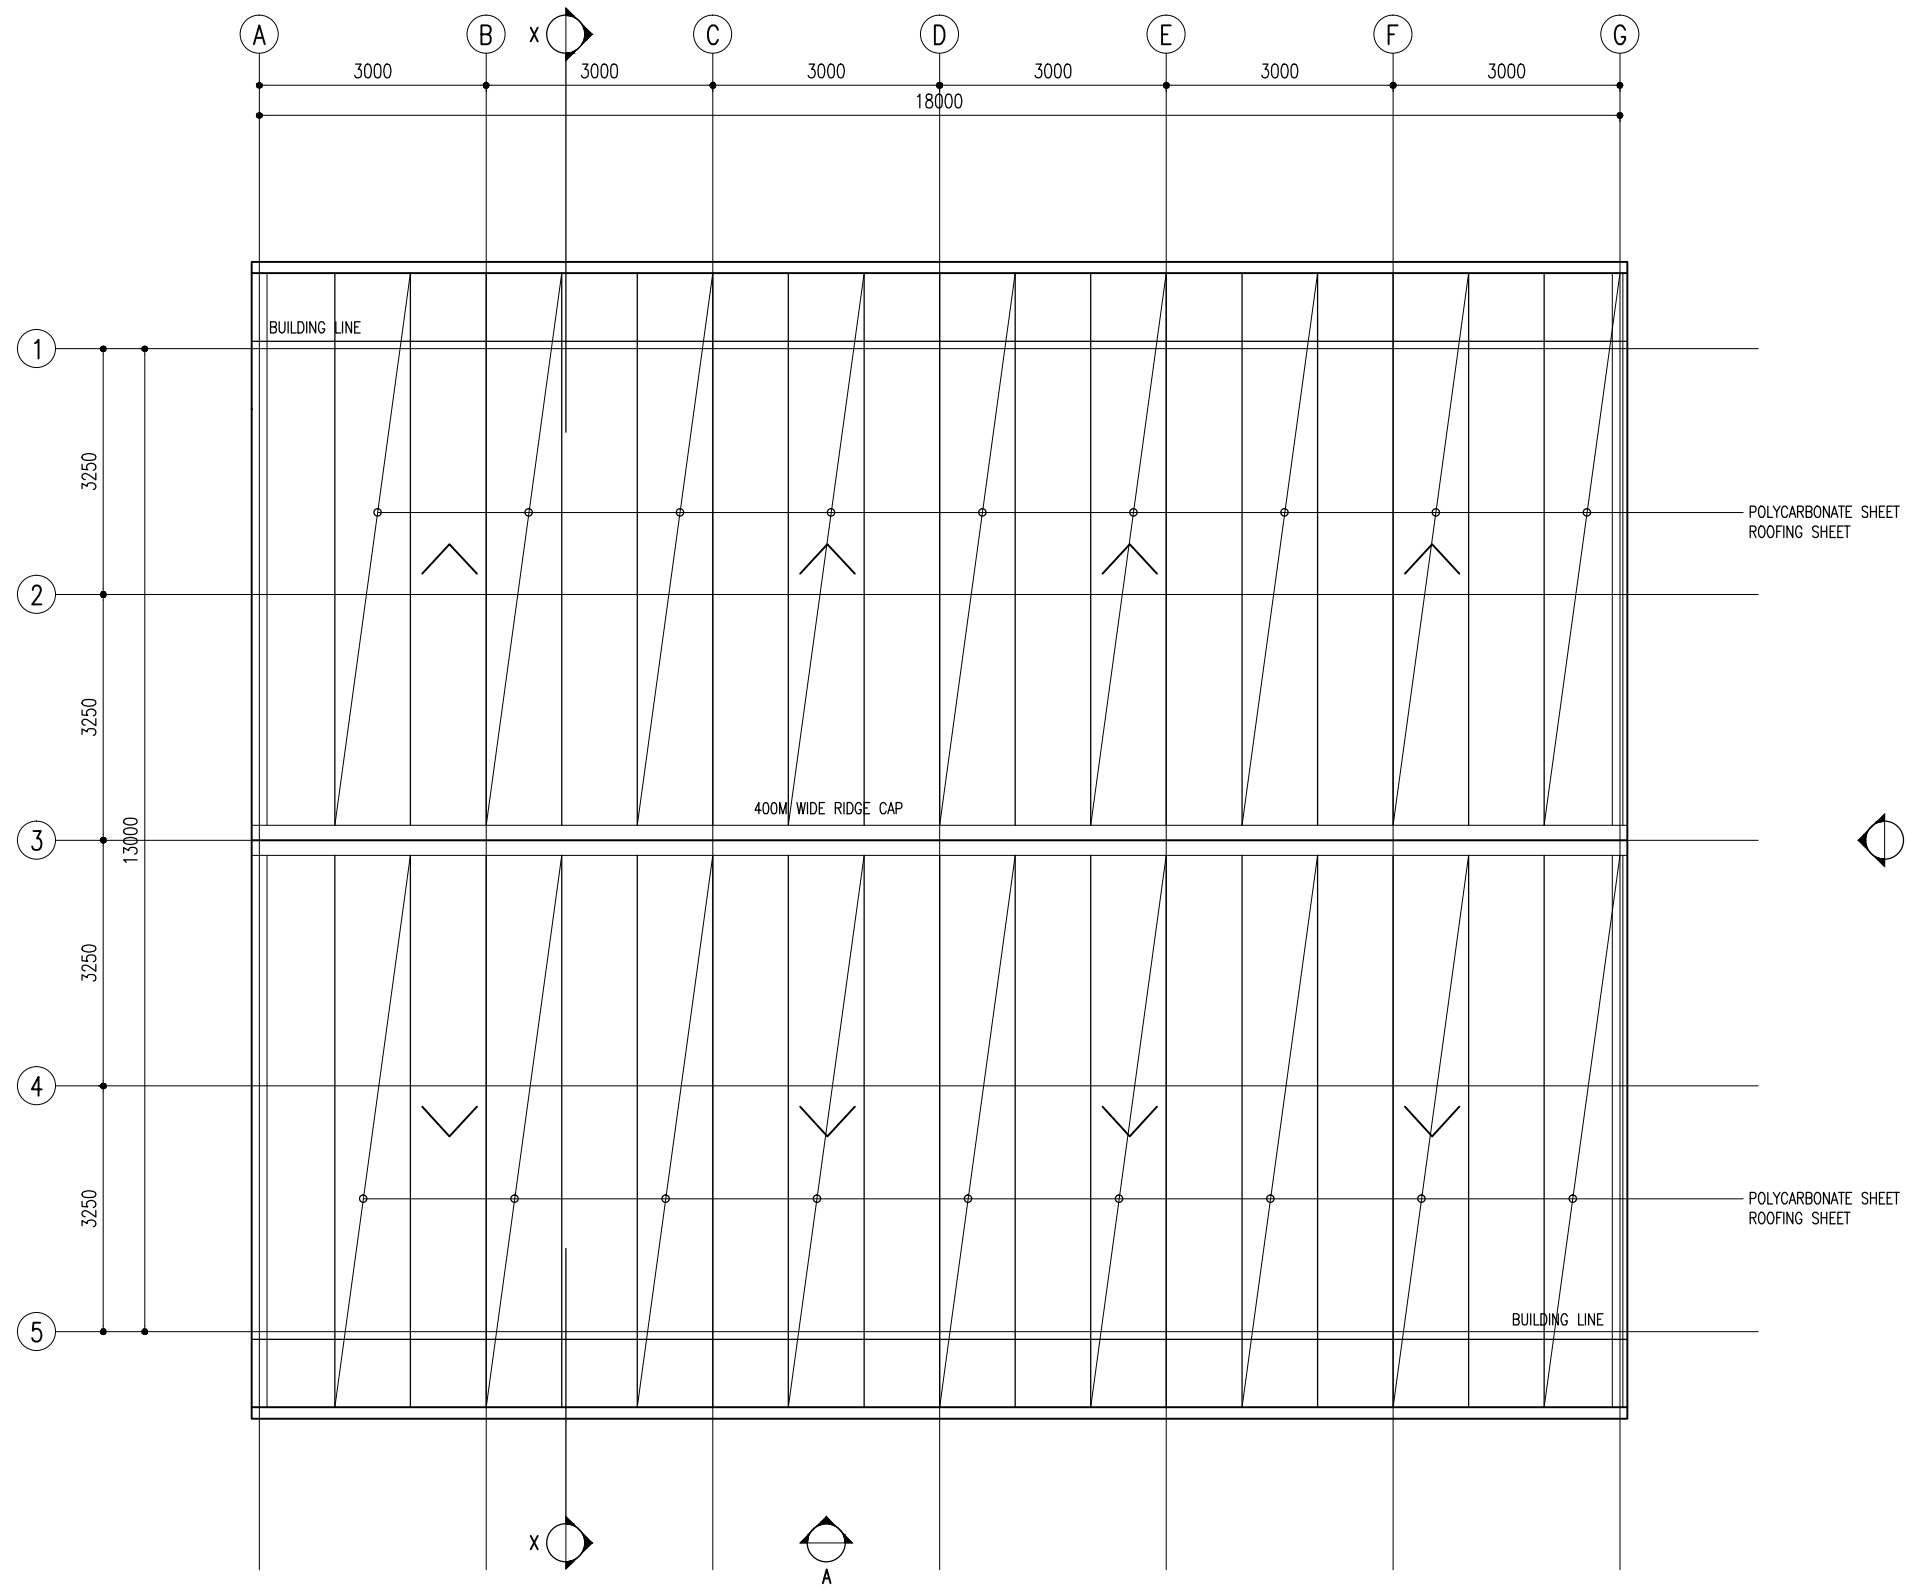

ROOF LAYOUT PLAN

SCALE 1:100

PROJECT: BROOD STOCK

CLIENT: MINISTRY OF FISHERIES & AGRI

DATE: APRIL 2018

DO NOT SCALE THE DRAWING

ARCHITECTURAL DESIGN

DESIGNED BY: - HUSSAIN ZIYATH


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DESIGNED BY: - ADAM SAANEEZ

DWG NO:


A - 03/ 05

CHARRETTE
STUDIO

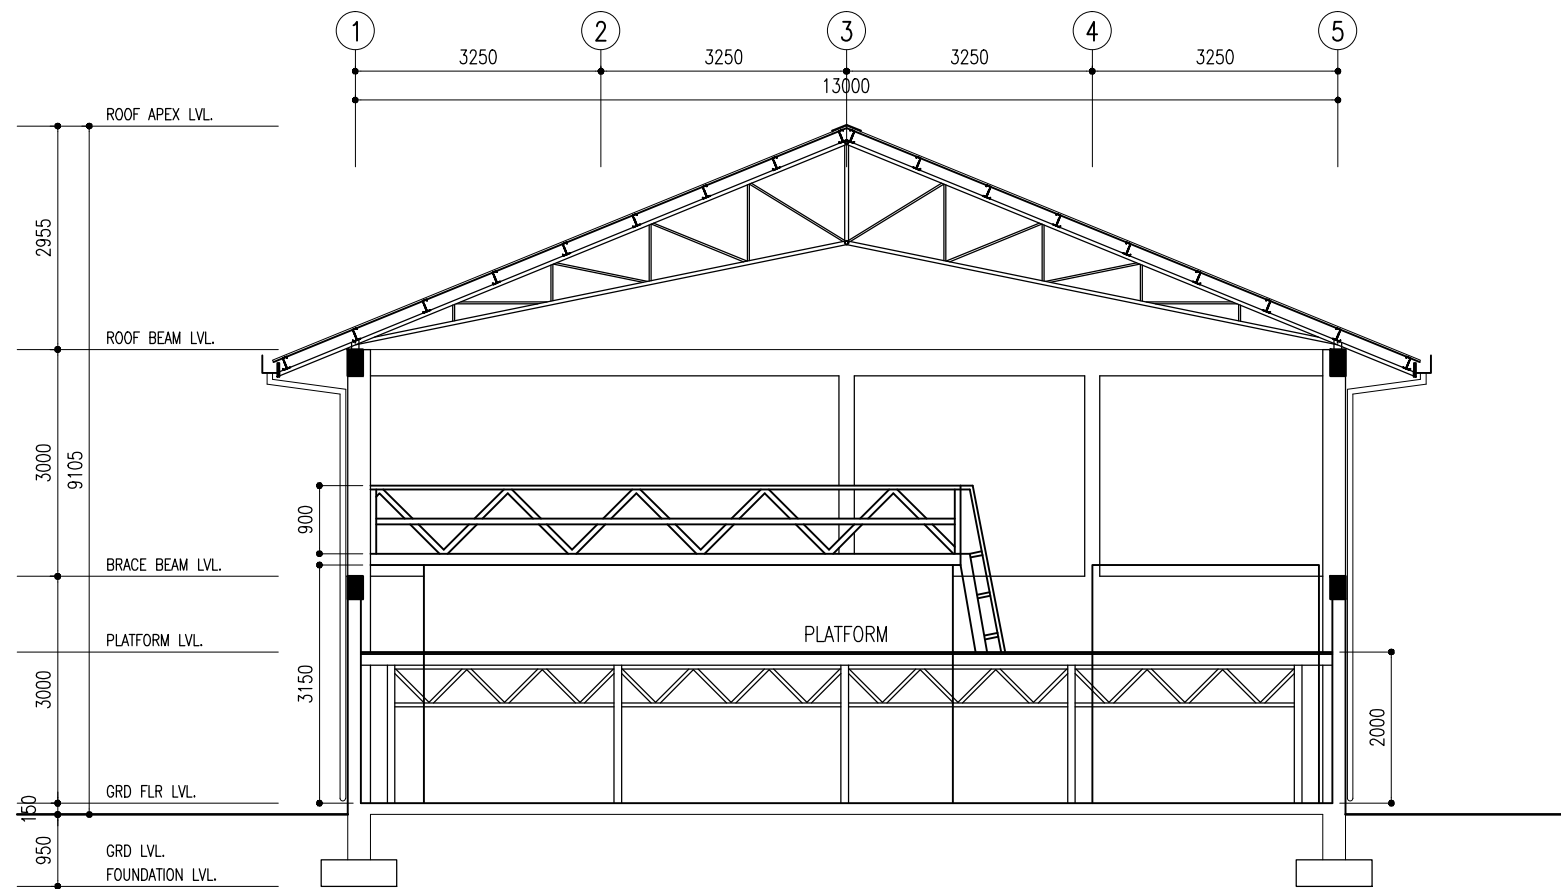

SECTION X-X

SCALE 1:100

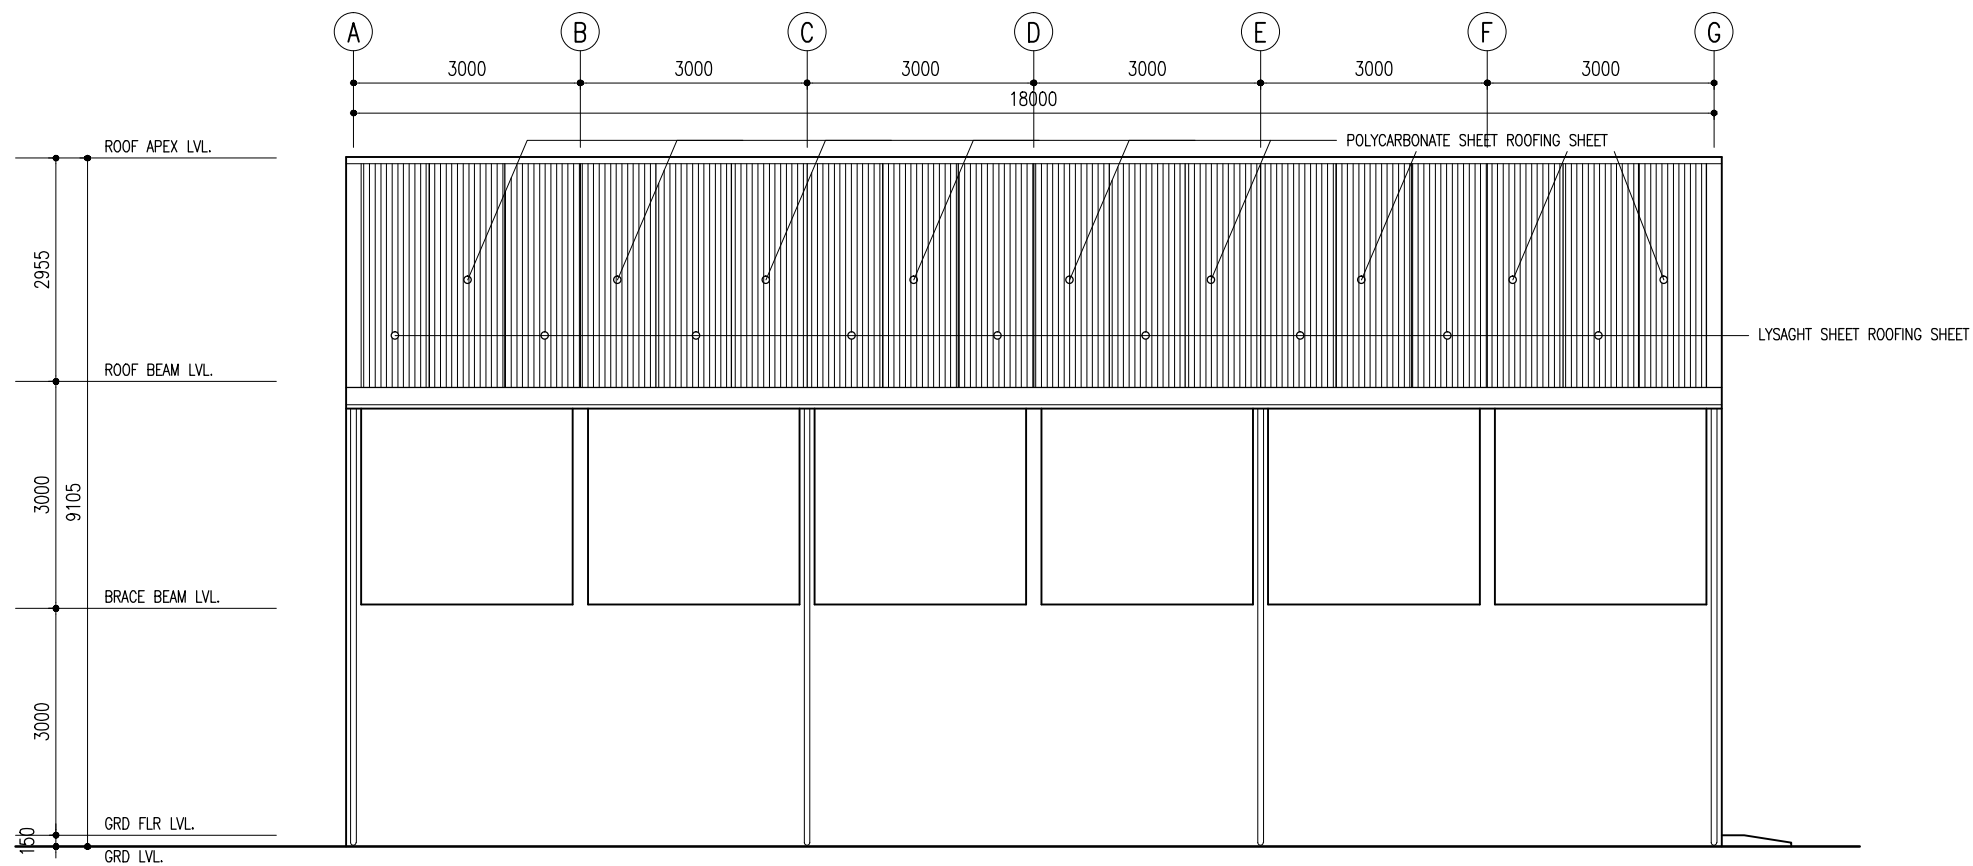

ELEVATION - A


SCALE 1:100

PROJECT: BROOD STOCK	ARCHITECTURAL DESIGN	STRUCTURAL DESIGN
CLIENT: MINISTRY OF FISHERIES & AGRI	DESIGNED BY: - HUSSAIN ZIYATH	DESIGNED BY: - ADAM SAANEEZ
DATE: APRIL 2018		
DO NOT SCALE THE DRAWING		

DWG NO:

A - 04/ 05

CHARRETTE
STUDIO


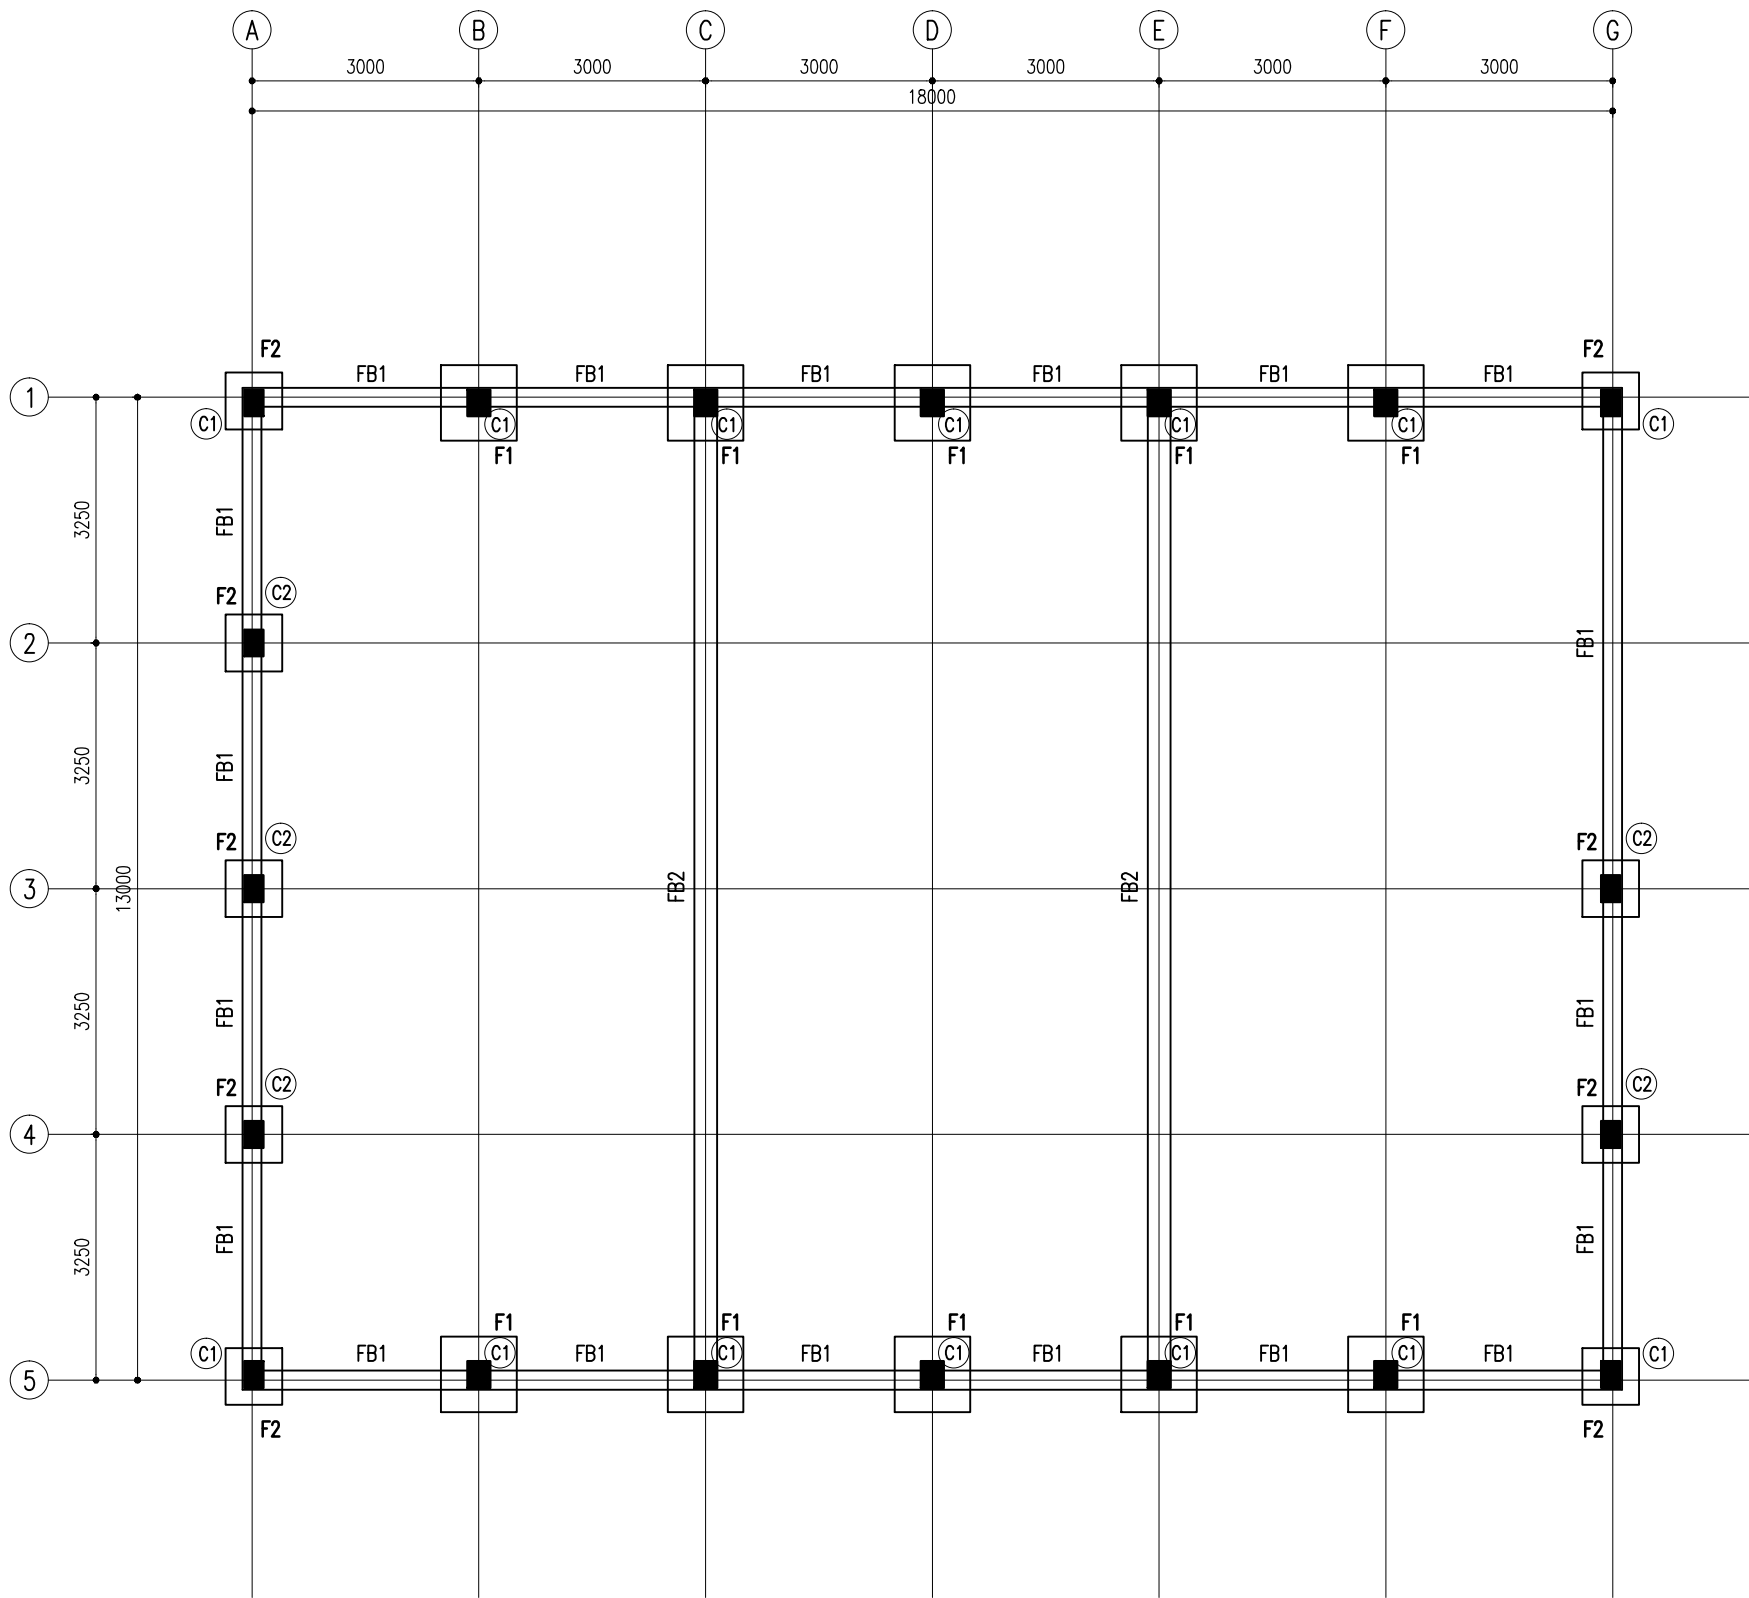


FOUNDATION LAYOUT PLAN

SCALE 1:100


PAD	SIZE	REINFORCEMENT
F1	1000X1000X250	T12@150 BW/BOTTOM
F2	750X750X250	T12@150 BW/BOTTOM

FOUNDATION PAD DETAILS

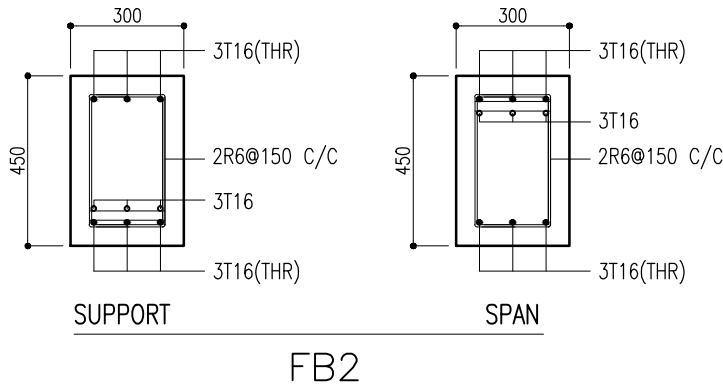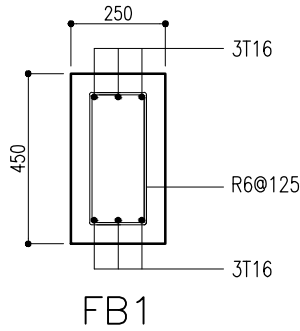

FOUNDATION BEAM DETAILS

SCALE 1:20

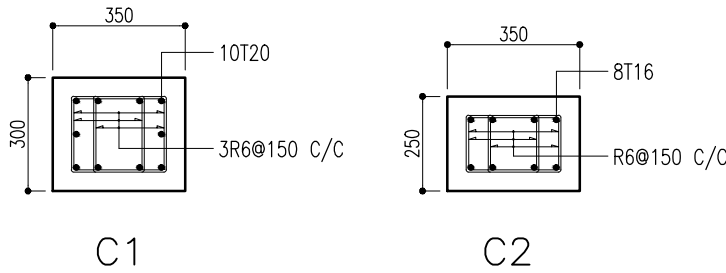

COLUMN DETAILS

SCALE 1:20

PROJECT: BROOD STOCK
CLIENT: MINISTRY OF FISHERIES & AGRI
DATE: APRIL 2018
DO NOT SCALE THE DRAWING


ARCHITECTURAL DESIGN
DESIGNED BY: - HUSSAIN ZIYATH

STRUCTURAL DESIGN
DESIGNED BY: - ADAM SAANEEZ

DWG NO:


S - 01/ 07



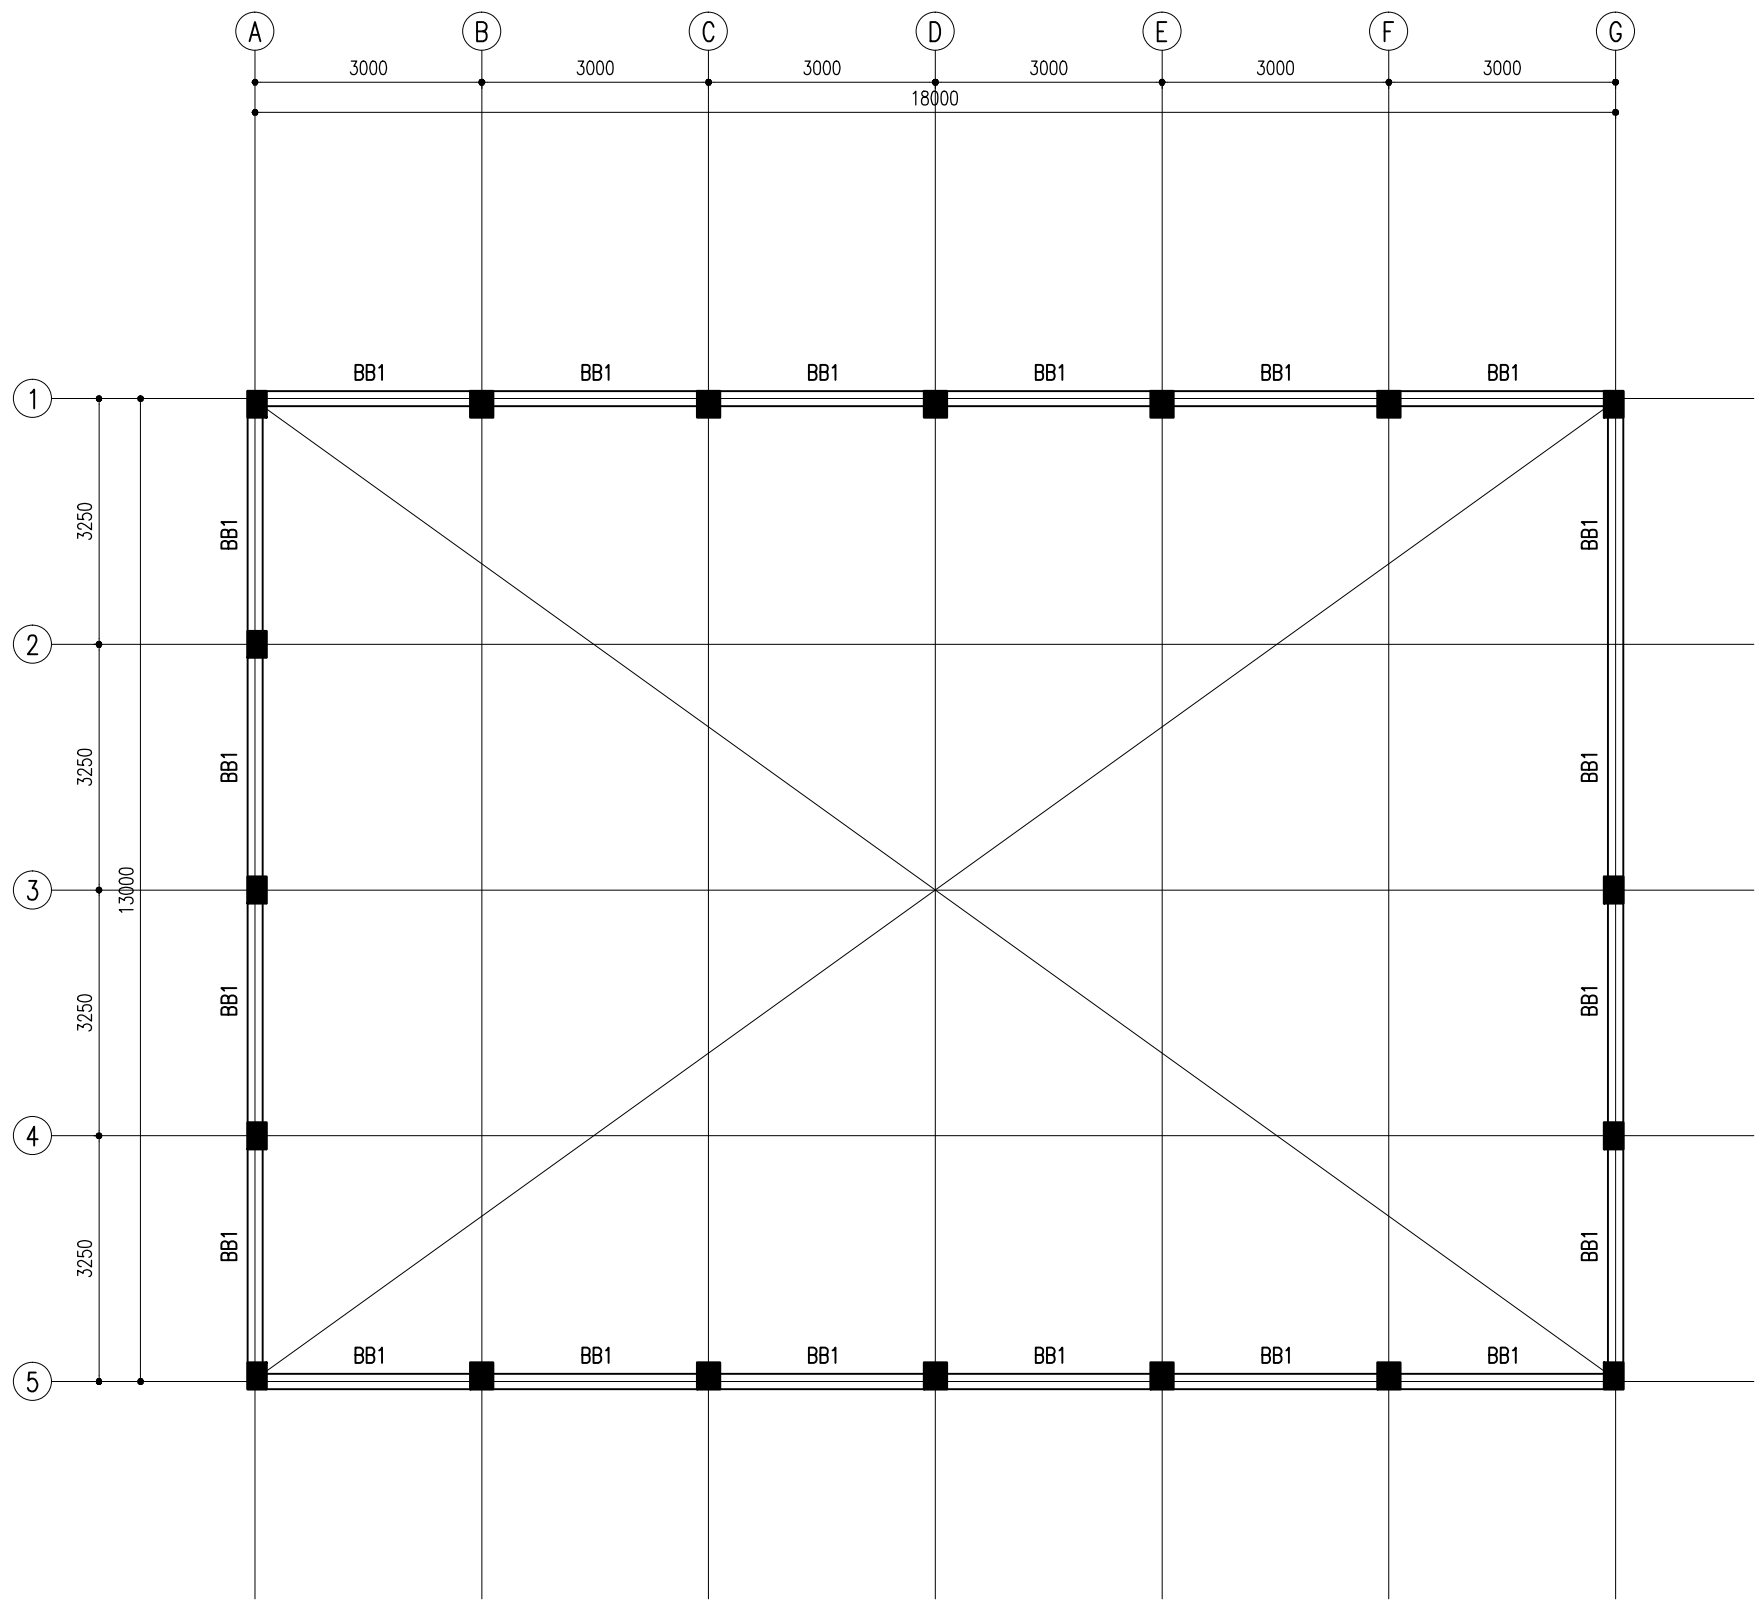

BRACE BEAM LAYOUT PLAN @ 3000 FFL

SCALE 1:100

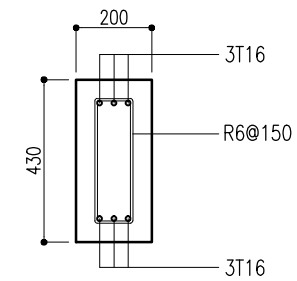


BB1


BRACE BEAM DETAILS

SCALE 1:20

PROJECT: BROOD STOCK	ARCHITECTURAL DESIGN	STRUCTURAL DESIGN	DWG NO:	<div><div></div><div>CHARRETTE</div><div>STUDIO</div></div>
CLIENT: MINISTRY OF FISHERIES & AGRI	DESIGNED BY: - HUSSAIN ZIYATH	DESIGNED BY: - ADAM SAANEEZ	S - 02/ 07	
DATE: APRIL 2018				
DO NOT SCALE THE DRAWING				

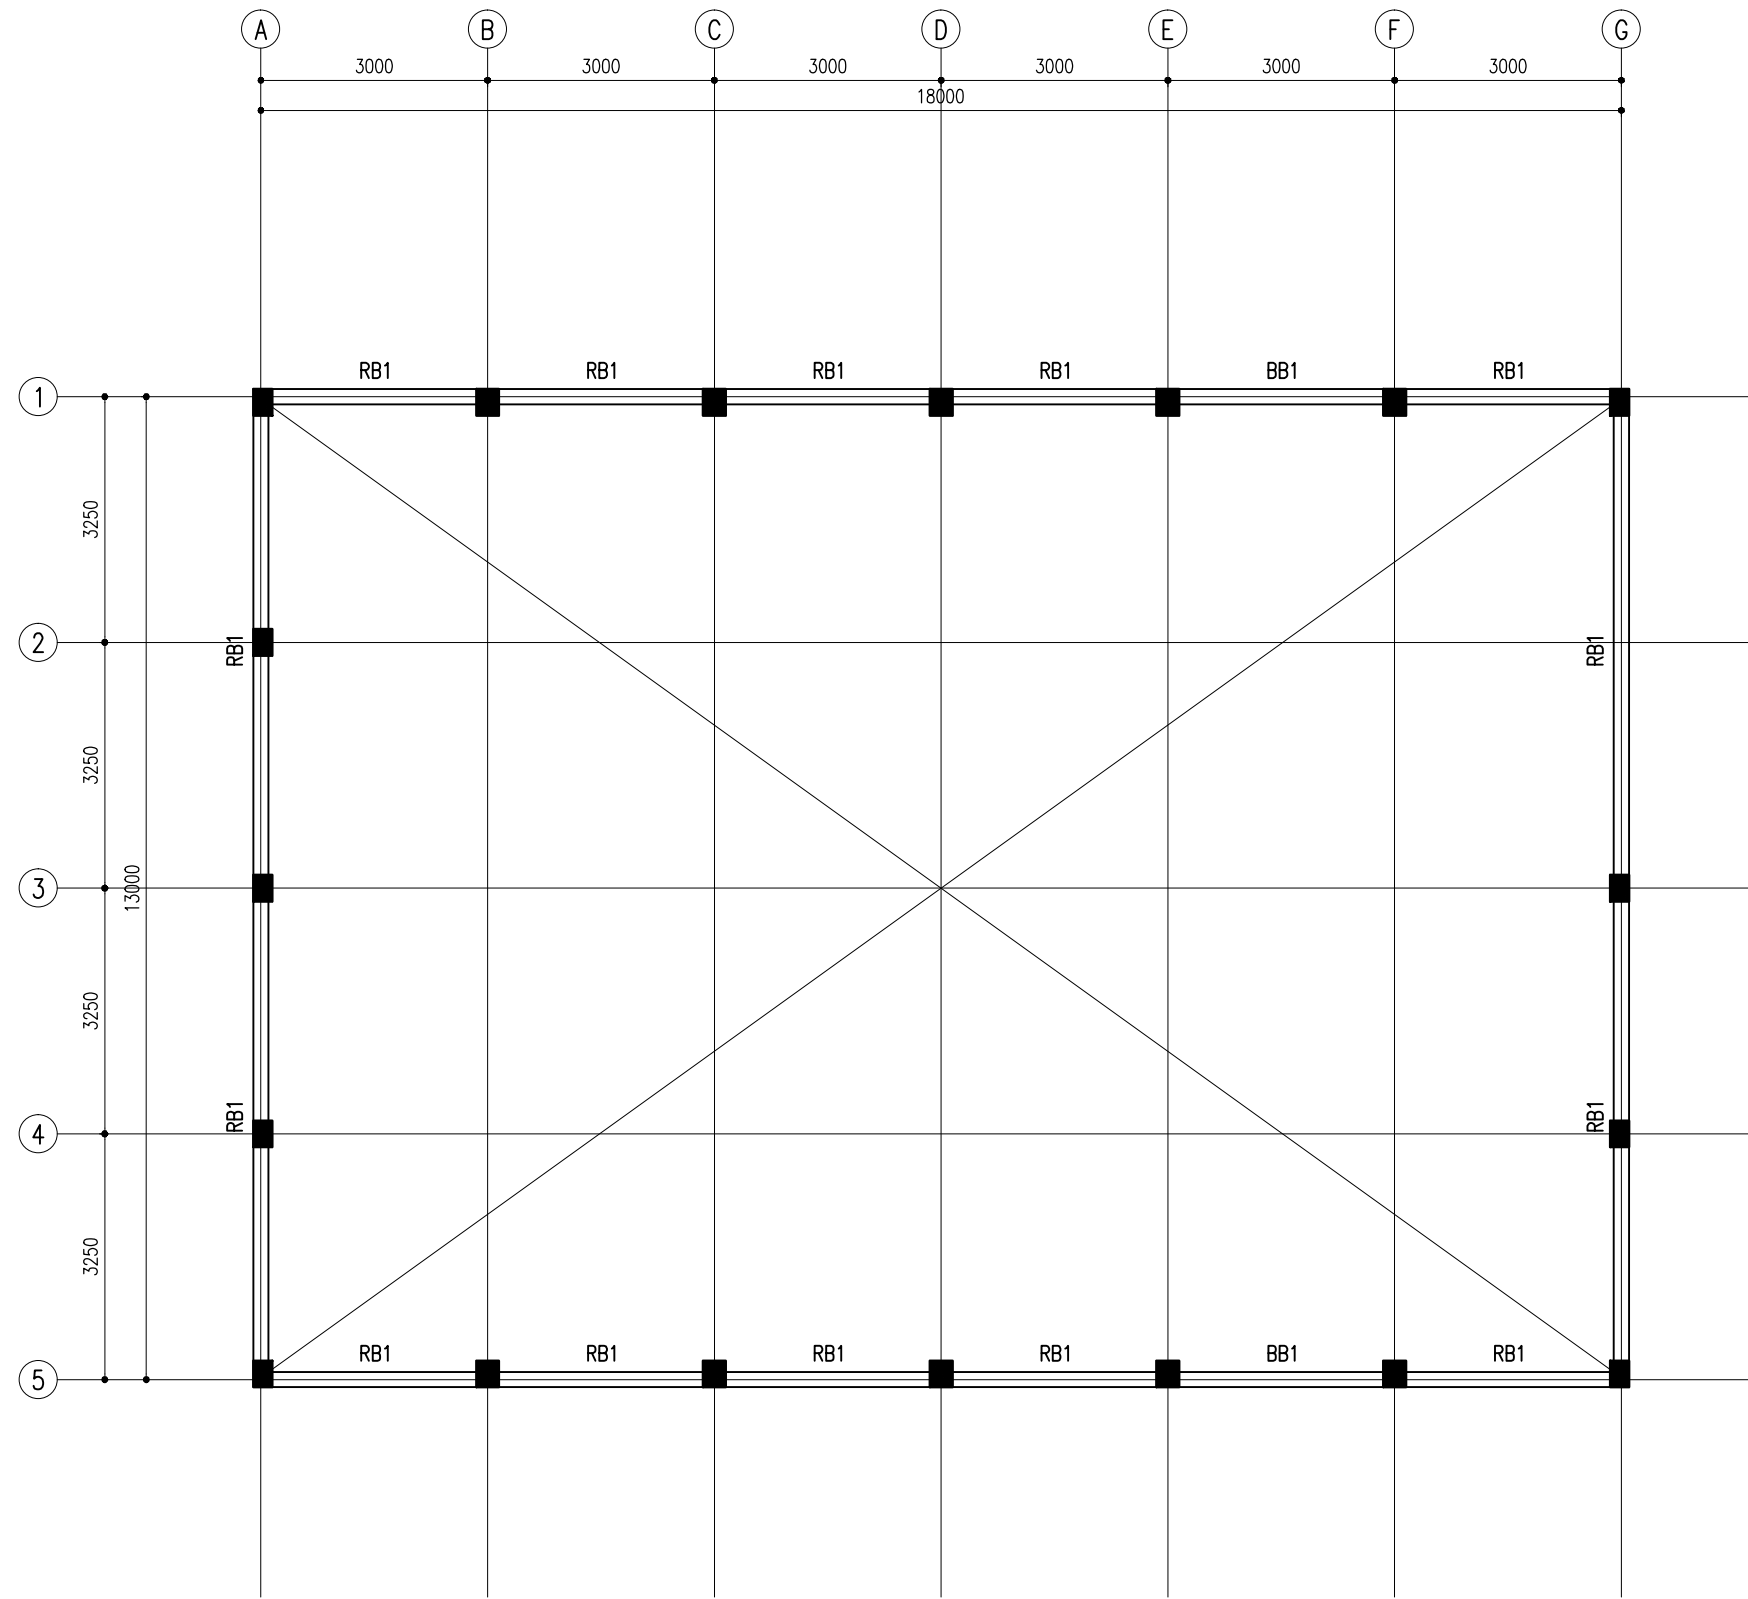


ROOF BEAM LAYOUT PLAN
SCALE 1:100

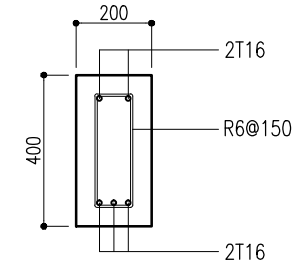

RB1

ROOF BEAM DETAILS
SCALE 1:20

+ - + - +	PROJECT: BROOD STOCK	ARCHITECTURAL DESIGN	STRUCTURAL DESIGN	DWG NO: S - 03/ 07	<div><div></div><div>CHARRETTE</div><div>STUDIO</div></div>
	CLIENT: MINISTRY OF FISHERIES & AGRI	DESIGNED BY: - HUSSAIN ZIYATH	DESIGNED BY: - ADAM SAANEEZ		
	DATE: APRIL 2018				
	DO NOT SCALE THE DRAWING				

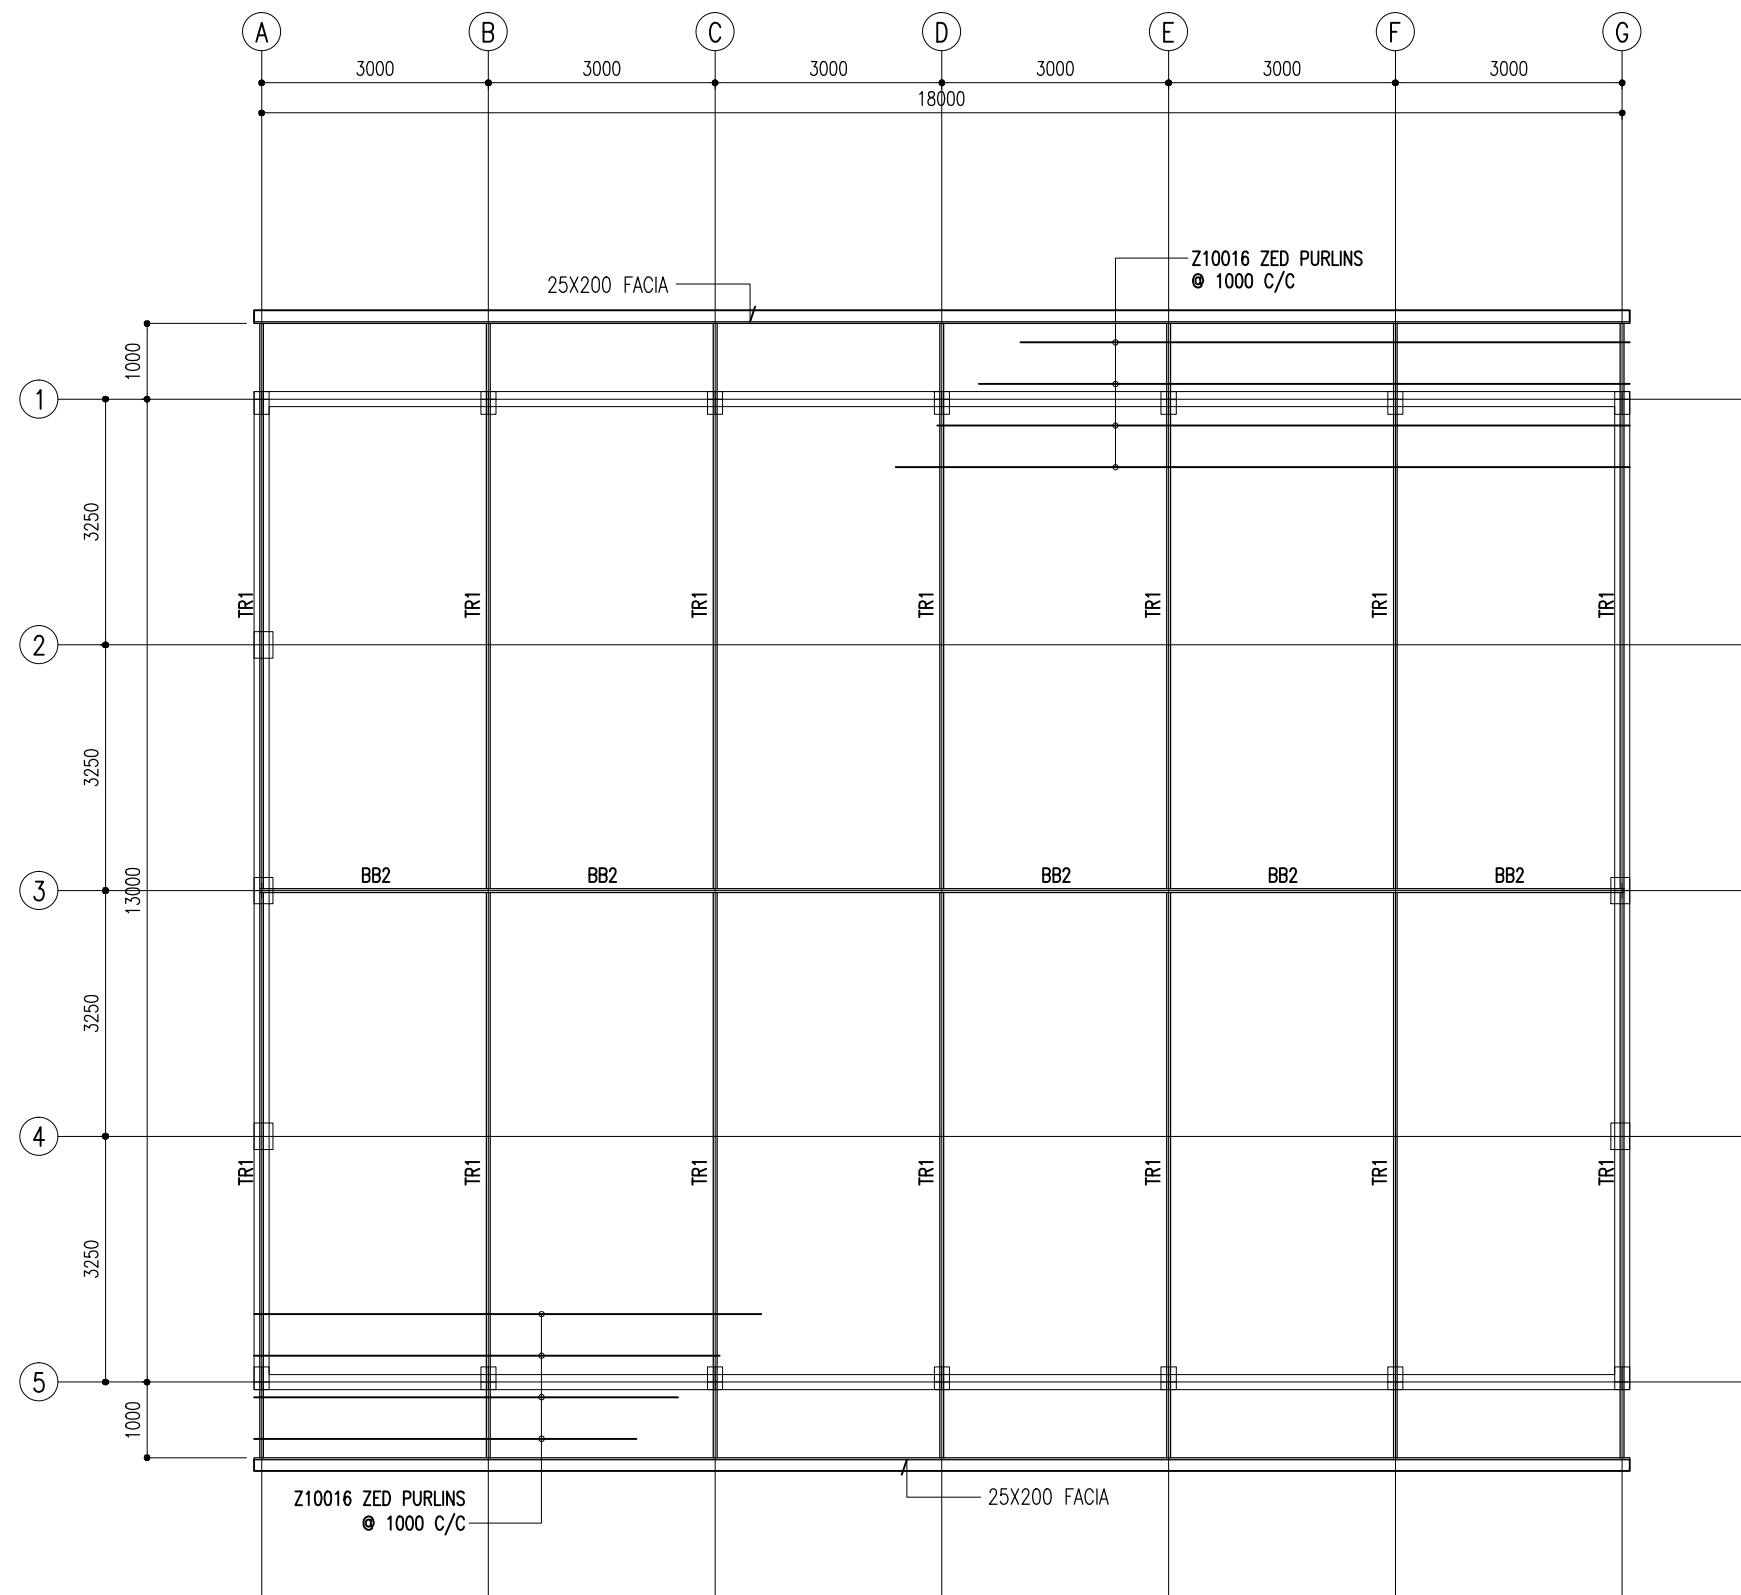

NOTE:

ALL OPEN ENDS OF GI PIPES OF TRUSS AND BRACE BEAM SHOULD BE CAPPED BY 3MM THK MS PLATE COVER

ALL STEEL COMPONENTS SHOULD BE TREATED WITH THREE COATS OF ANTI-RUST PAINT

ROOF SLOPE IS 15 DEGREES TO THE HORIZONTAL

ALL STEEL TRUSSES SHOULD HAVE 50 WIDE 50X50 MS ANGLE SECTIONS WELDED ON TOP @ 1000 CC TO ATTACH RAFTERS

ALL WELDED JOINTS SHOULD BE BRUSHED CLEAN AND APPLIED WITH TWO COATS OF RUST PROOF PAINT

ALL CONNECTION BOLTS, FASTENINGS AND BRACKETS SHOULD BE IN GI STEEL

ALL SCREWS MUST BE IN BRASS AND ALL NAILS SHOULD BE IN DIP GALVANISED STEEL

ALL CONNECTION AND FIXING DETAIL SHOP DRAWINGS MUST BE PRODUCED BY THE CONTRACTOR AND APPROVED BY THE CONSULTANT BEFORE FABRICATION

ROOF STRUCTURE LAYOUT PLAN

SCALE 1:100

PROJECT: BROOD STOCK
CLIENT: MINISTRY OF FISHERIES & AGRI
DATE: APRIL 2018
DO NOT SCALE THE DRAWING


ARCHITECTURAL DESIGN
DESIGNED BY: - HUSSAIN ZIYATH

STRUCTURAL DESIGN
DESIGNED BY: - ADAM SAANEEZ


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S - 04/ 07


CHARRETTE
STUDIO

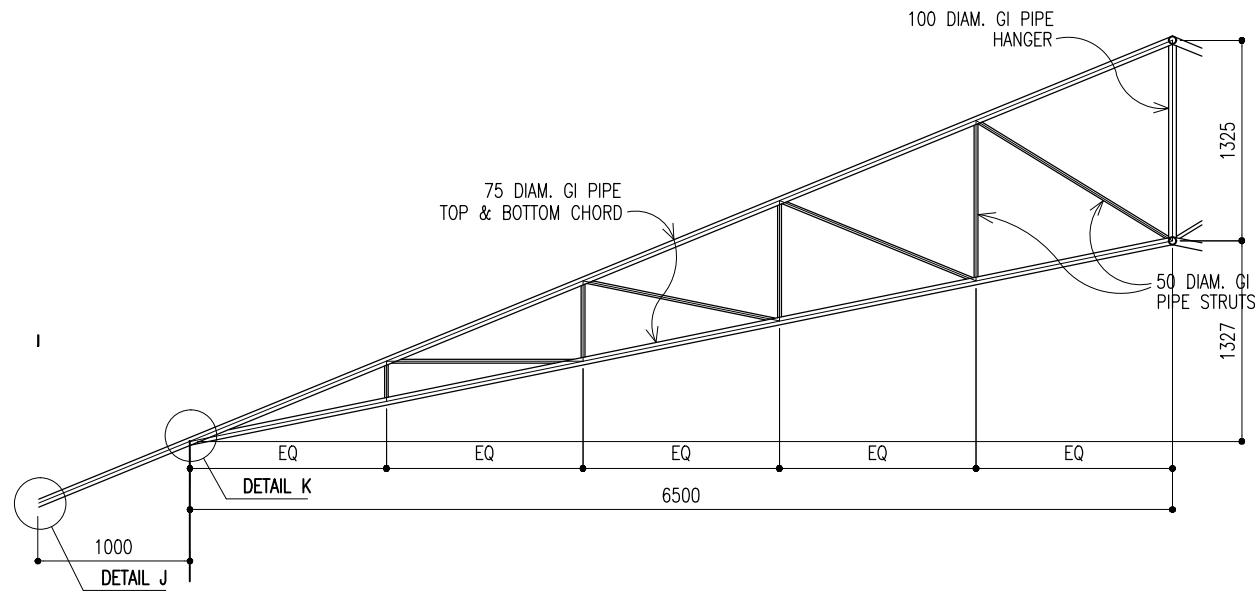


TRUSS TR1
SCALE 1:50

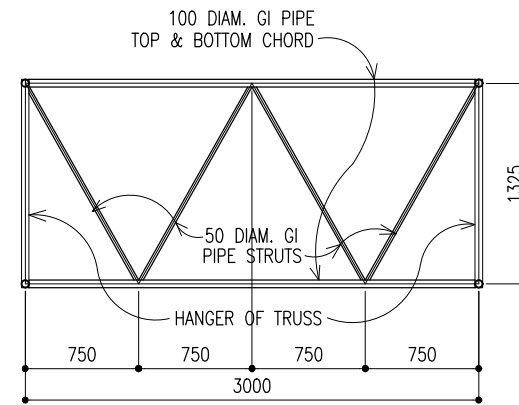

BRACE BEAM BB2
SCALE 1:20

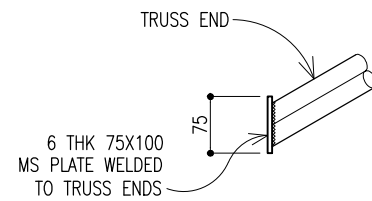

DETAIL J
SCALE 1:10

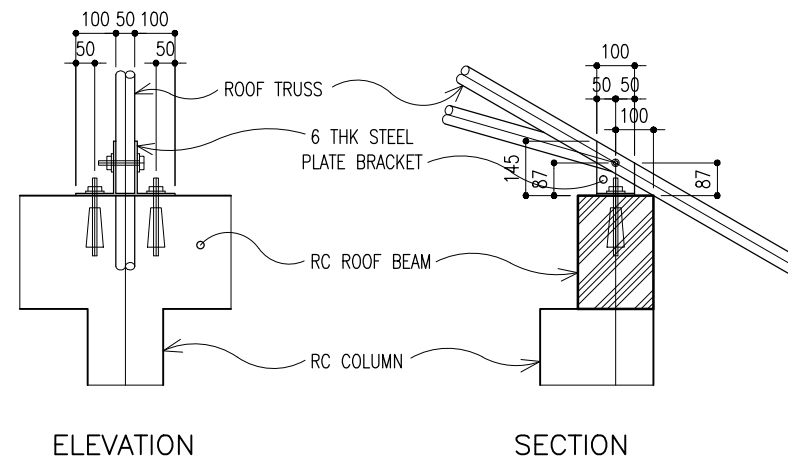

DETAIL K
SCALE 1:20


PROJECT: BROOD STOCK
CLIENT: MINISTRY OF FISHERIES & AGRI
DATE: APRIL 2018
DO NOT SCALE THE DRAWING

ARCHITECTURAL DESIGN
DESIGNED BY: - HUSSAIN ZIYATH

STRUCTURAL DESIGN
DESIGNED BY: - ADAM SAANEEZ

DWG NO:
S - 05/ 07

CHARRETTE
STUDIO

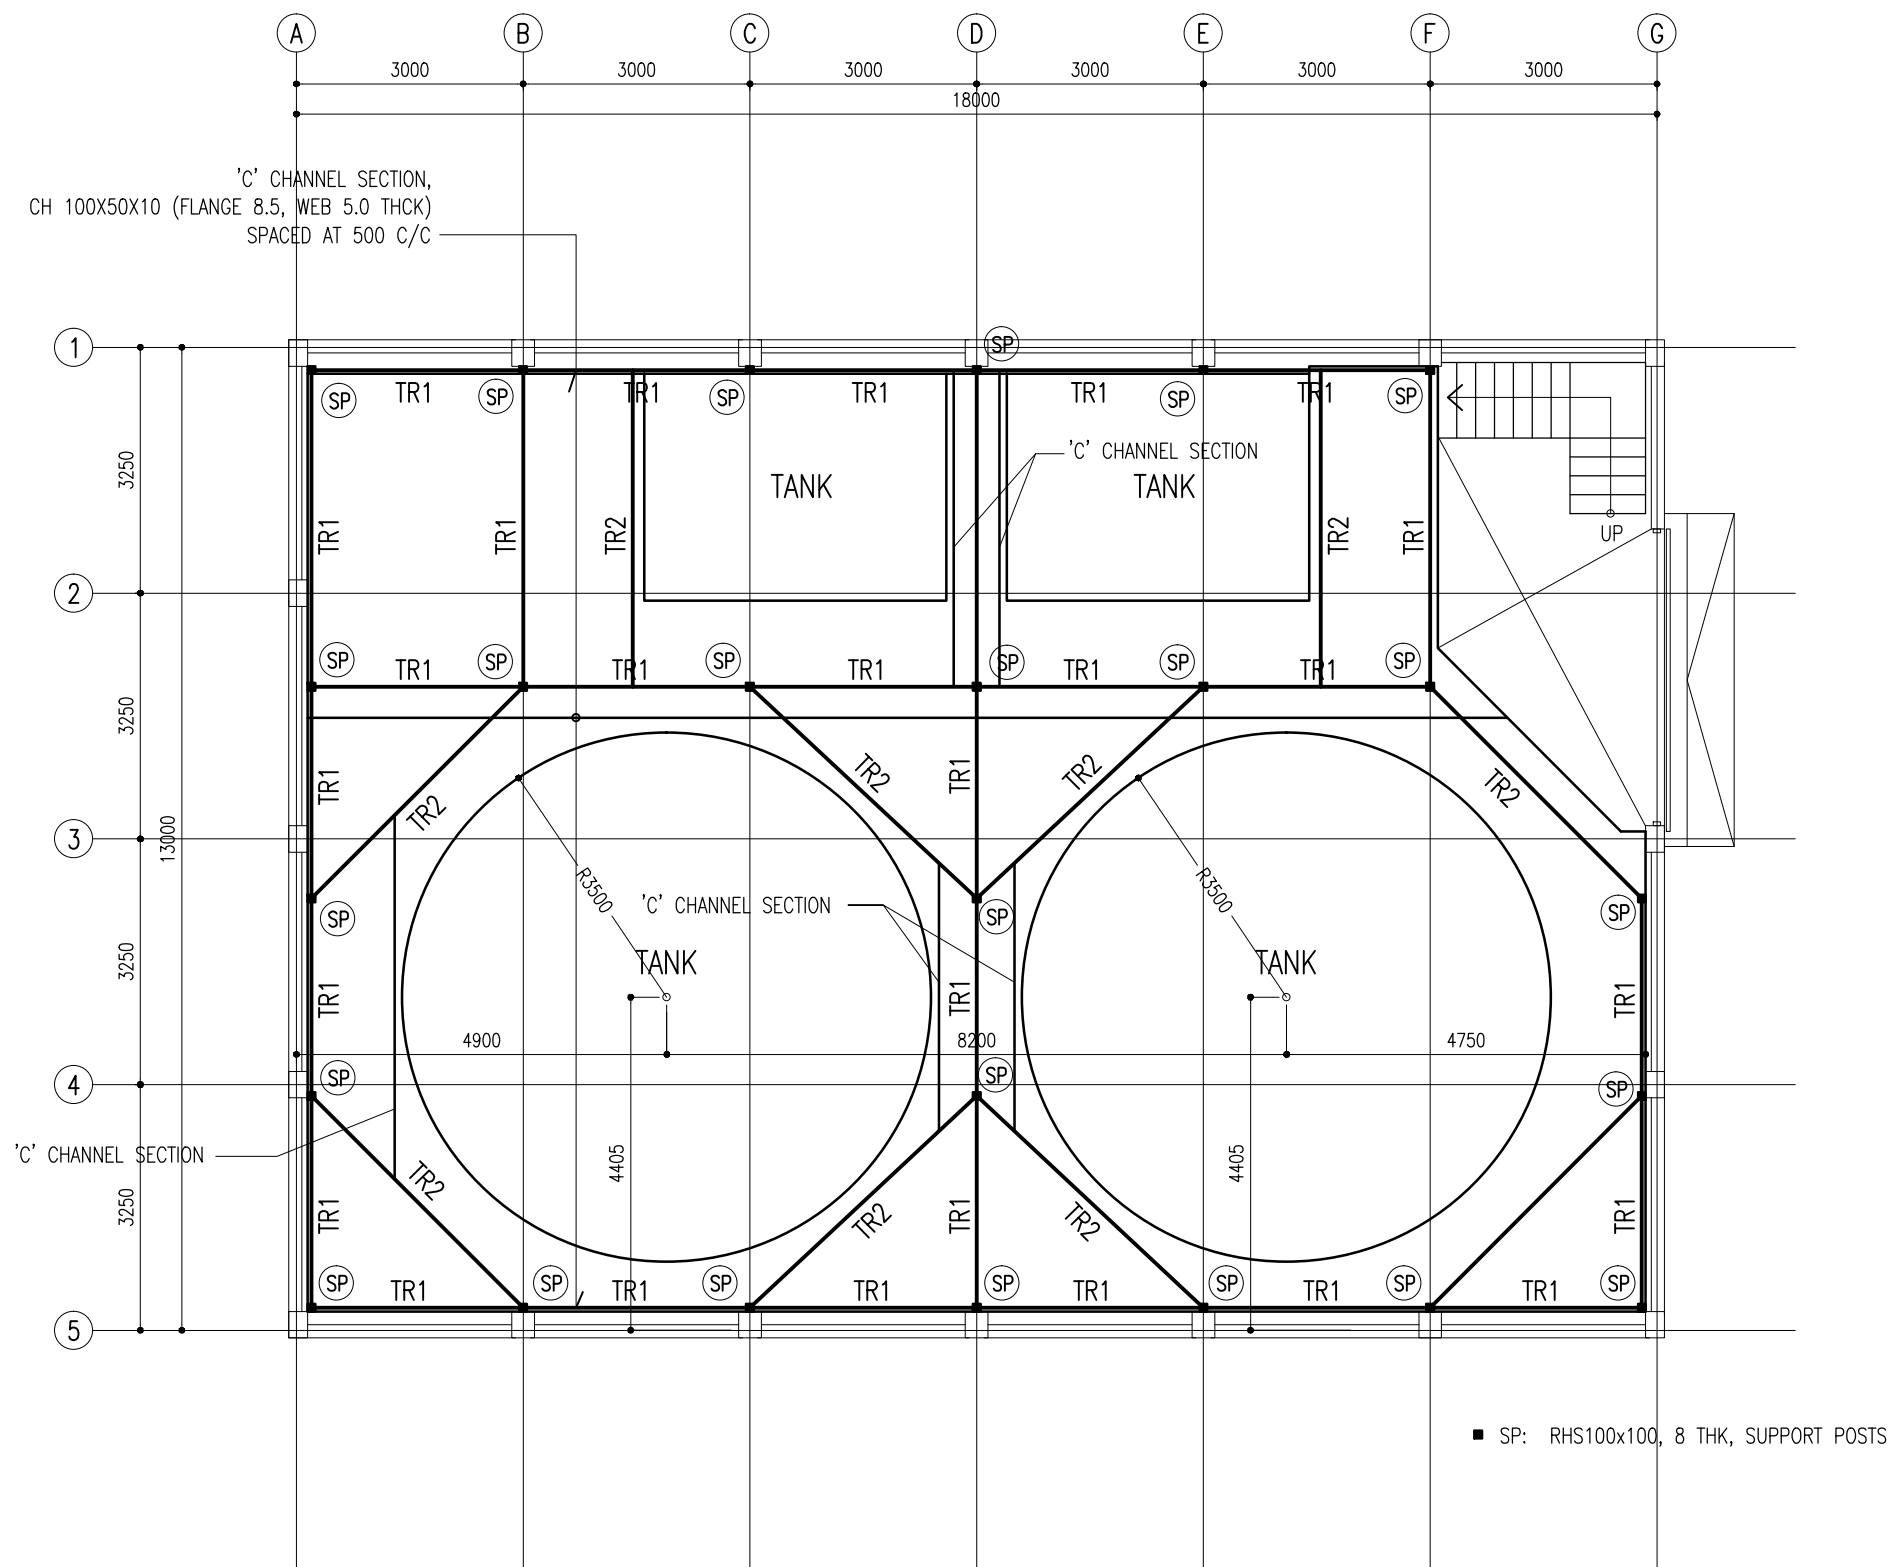

PLATFORM TRUSS PLAN

SCALE 1:100

PROJECT: BROOD STOCK

CLIENT: MINISTRY OF FISHERIES & AGRI

DATE: APRIL 2018

DO NOT SCALE THE DRAWING

ARCHITECTURAL DESIGN

DESIGNED BY: - HUSSAIN ZIYATH


STRUCTURAL DESIGN

DESIGNED BY: - ADAM SAANEZ

DWG NO:


S - 06/ 07

CHARRETTE
STUDIO

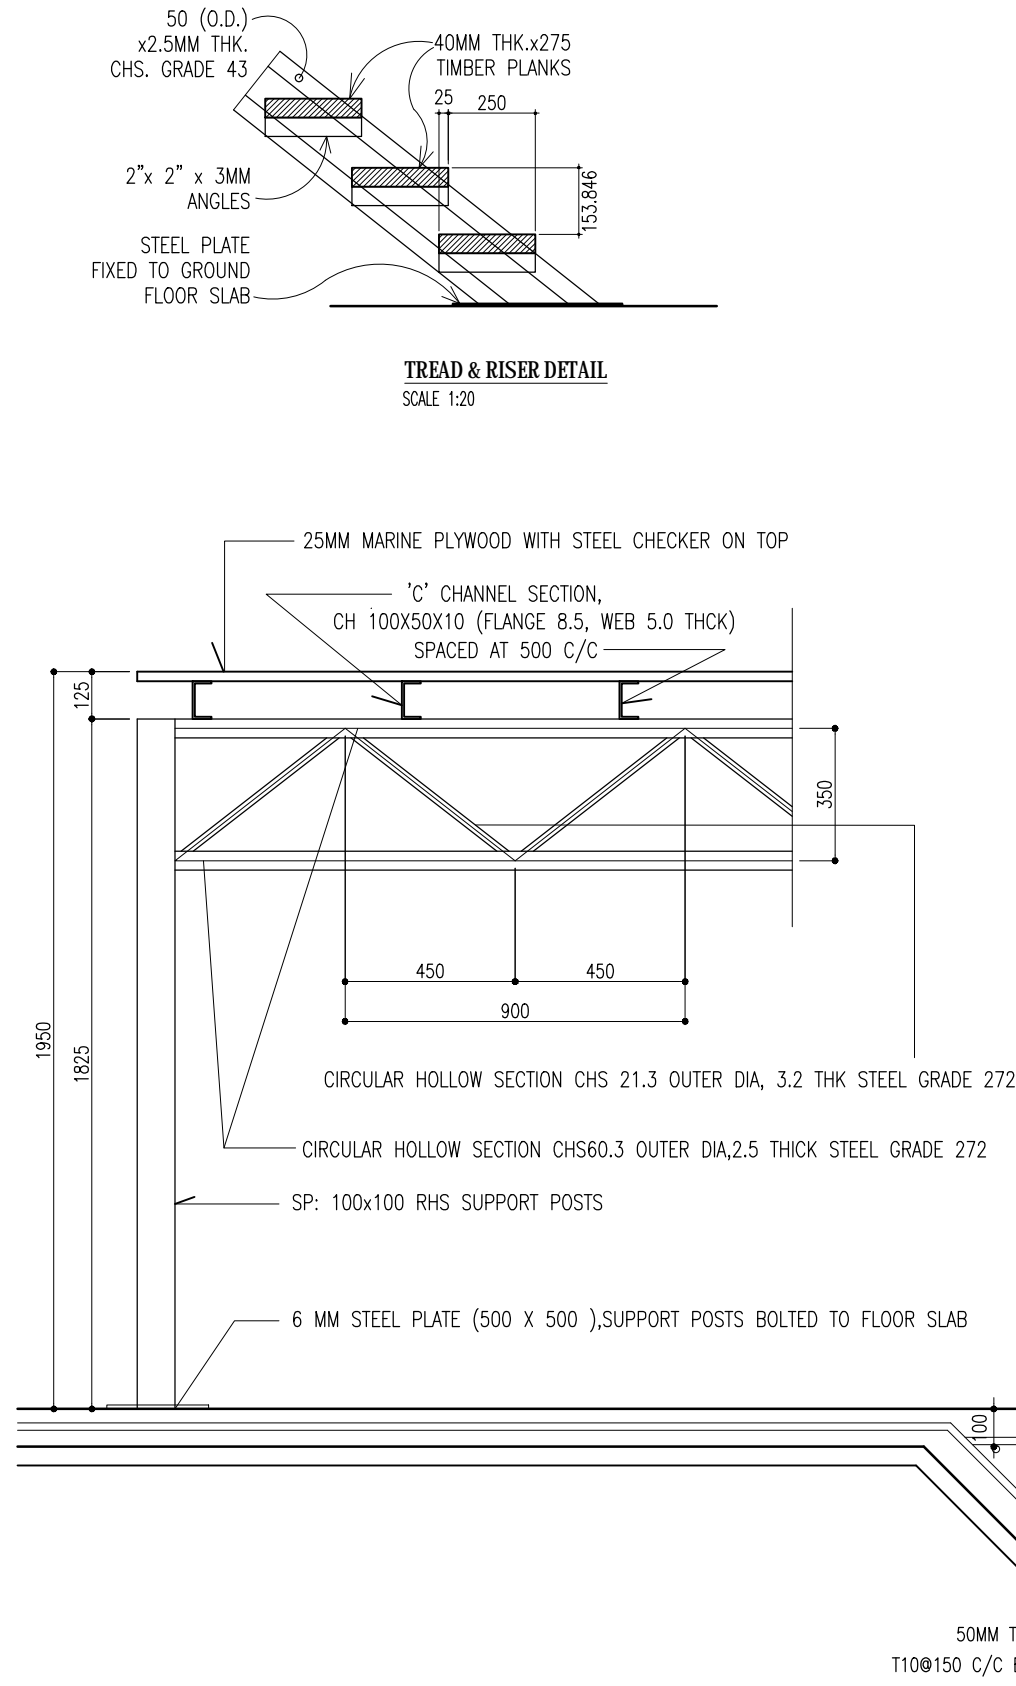


TYPICAL SECTION PLATFORM DETAILS

SCALE 1:20

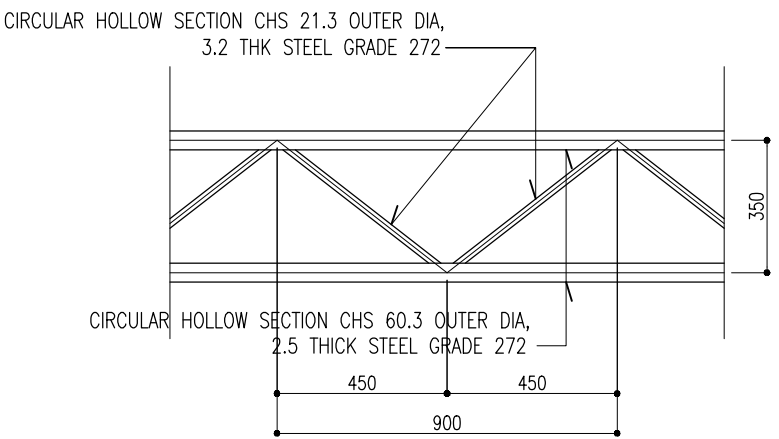

TRUSS DETAIL - TR1

SCALE 1:20

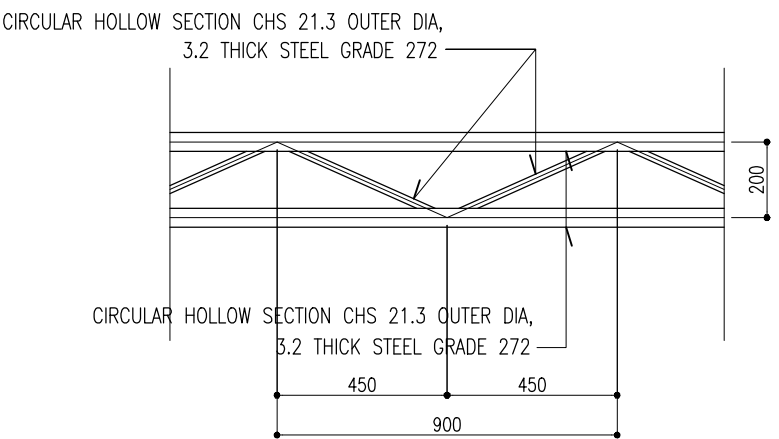

TRUSS DETAIL - TR2

SCALE 1:20

PROJECT: BROOD STOCK	ARCHITECTURAL DESIGN	STRUCTURAL DESIGN	DWG NO:
CLIENT: MINISTRY OF FISHERIES & AGRI	DESIGNED BY: - HUSSAIN ZIYATH	DESIGNED BY: - ADAM SAANEEZ	S - 07/ 07
DATE: APRIL 2018			
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