PROPOSED SINGLE STOREY FERRY TERMINAL H.DH KULHUDHUFUSHI


ARCHITECTURAL AND STRUCTURAL DRAWINGS


JANUARY 2018

CLIENT: MINISTRY OF HOUSING AND INFRASTRUCTURE

DESIGN BY



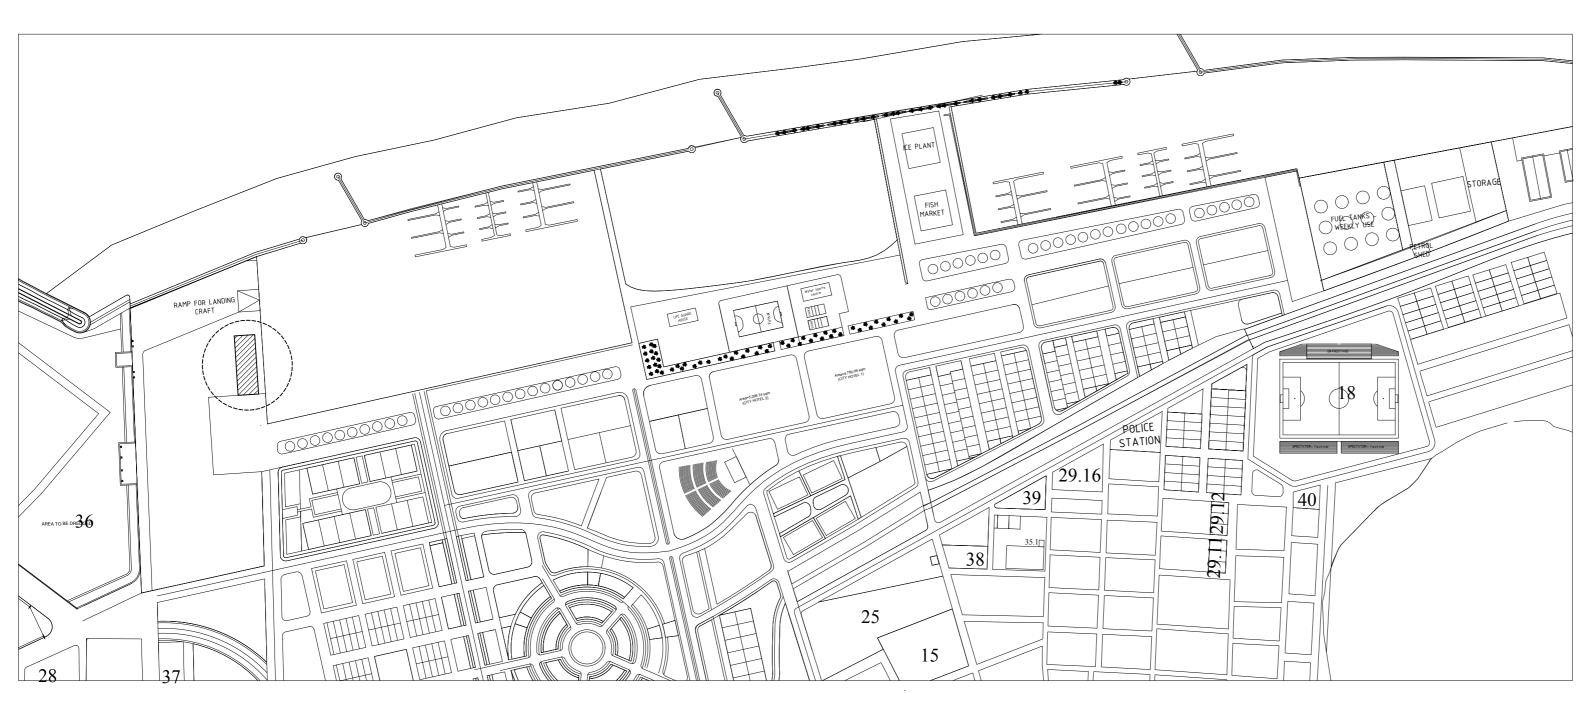

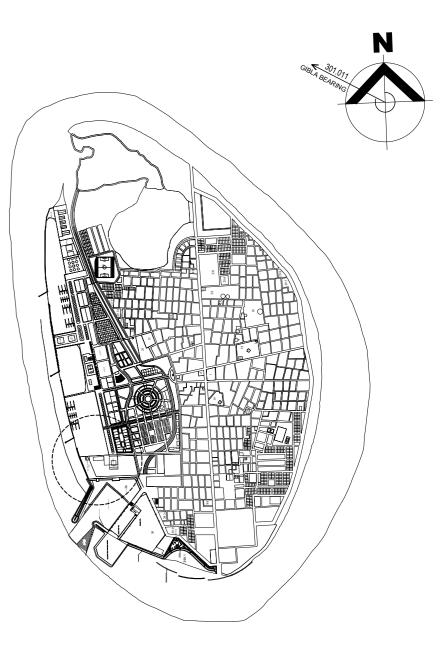

 $\frac{\text{LOCATION PLAN}}{\text{\tiny NTS}}$

MACRO SITE PLAN


SITE LOCATION

OWER	
	वाप्कोस लिमिटेड
	WAPCOS LIMITED
- HAVE	(भारत सरकार का उपक्रम)
ज	ल संसाधन, नदी विकास व गंगा संरक्षण मंत्रालय
	(A Government of India Undertaking)
Ministry of W	ater Resources, River Development & Ganga Rejuvenation

ON:	PRINCIPAL ARCHITECT: MOHAMED HAI
	ARCHITECT: AHMED AMEEL SHAKEEL
	PRINCIPAL ENGINEER: MOHAMED AHS.
	ENGINEER: SHAUFA AHMED

PROJECT: S	SINGLE STOREY FERRY T	ERMINAL	
 LOCATION:	HDH. KULHUDUFUSHI		A 04
 DRAWING TITLE: A	AS GIVEN		A-U1
CLIENT: MINISTRY O	OF HOUSING AND INFRAS	TRUCTURE	DWG NO
SCALE: AS GIVEN	DIMENSION: MM	DATE: JAN 2018	PROJECT NO:



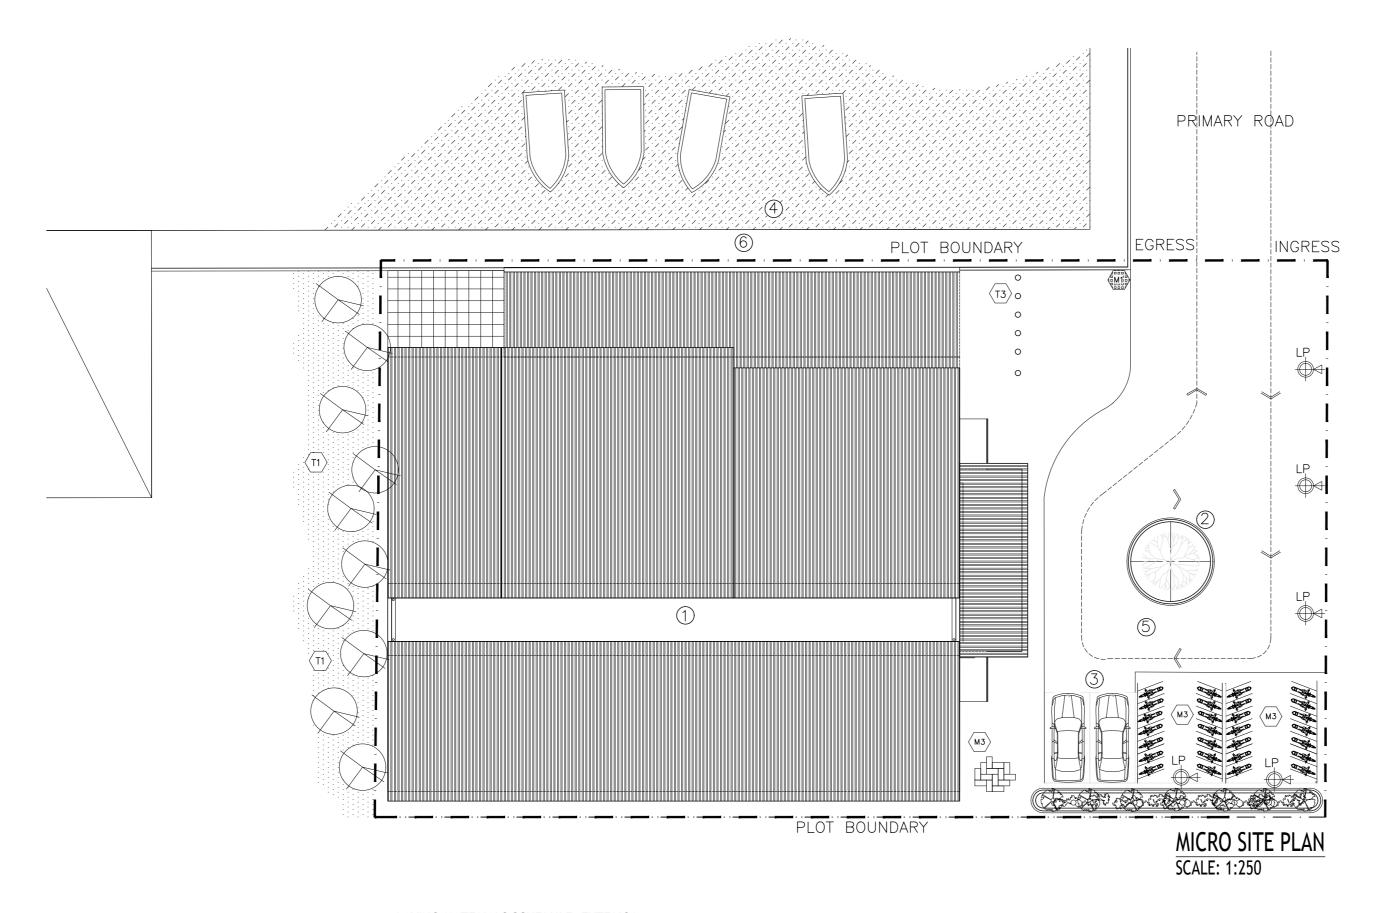

GENERAL MATERIALS

SYMBOL	DESCRIPTION	
	MOTAR SURFACE	
	NATURAL GRASS LAWN	

KEY / LEGEND NOTES

- TERMINAL
- PLANTER
- ② ③ ④ ⑤ ⑥ CAR PARKING
- HARBOR CAL-DE-SAC
- QUAY WALL



PLANTS

— PLOT BOUNDARY

PAVING MATERIALS SCHEDULE (EXTERIOR)

SYMBOL	CODE	DESCRIPTION
	₹ 11	TREES IN BETWEEN 6-4M IN HEIGHT
CANCEL	▼T2	EXISTING SHRUBS
0	₹13	BOLLARDS
	√T4	BENCHES
	T5	RAMPED/SLOPED AREAS


SYMBOL	CODE	DESCRIPTION
	(M113)	VOID BRICKS IN VEGETATION AREAS WITH SOIL IN THE VOIDED AREA FOR PLANTATION AND DRAINAGE
		DESIGNED BRICKS IN PEDESTRIAN WALKWAYS
	(M3)	DESIGNED BRICKS IN TRAFFICWAYS AND WALKWAYS
	AS SHOWN	CONCRETE WALKWAY CURBS


LAMPOSTS — 🙀 LP



ISION:	PRINCIPAL ARCHITECT: MOHAMED HAMEEN
	ARCHITECT: AHMED AMEEL SHAKEEL
	PRINCIPAL ENGINEER: MOHAMED AHSAN
	ENGINEER: SHAUFA AHMED

PROJECT:	SINGLE STOREY FERRY T	ERMINAL	
 LOCATION:	HDH. KULHUDUFUSHI		A 02
DRAWING TITLE:	AS GIVEN		A-UZ
 CLIENT: MINISTRY	OF HOUSING AND INFRAS	TRUCTURE	DWG NO
SCALE: AS GIVEN	DIMENSION: MM	DATE: JAN 2018	PROJECT NO:

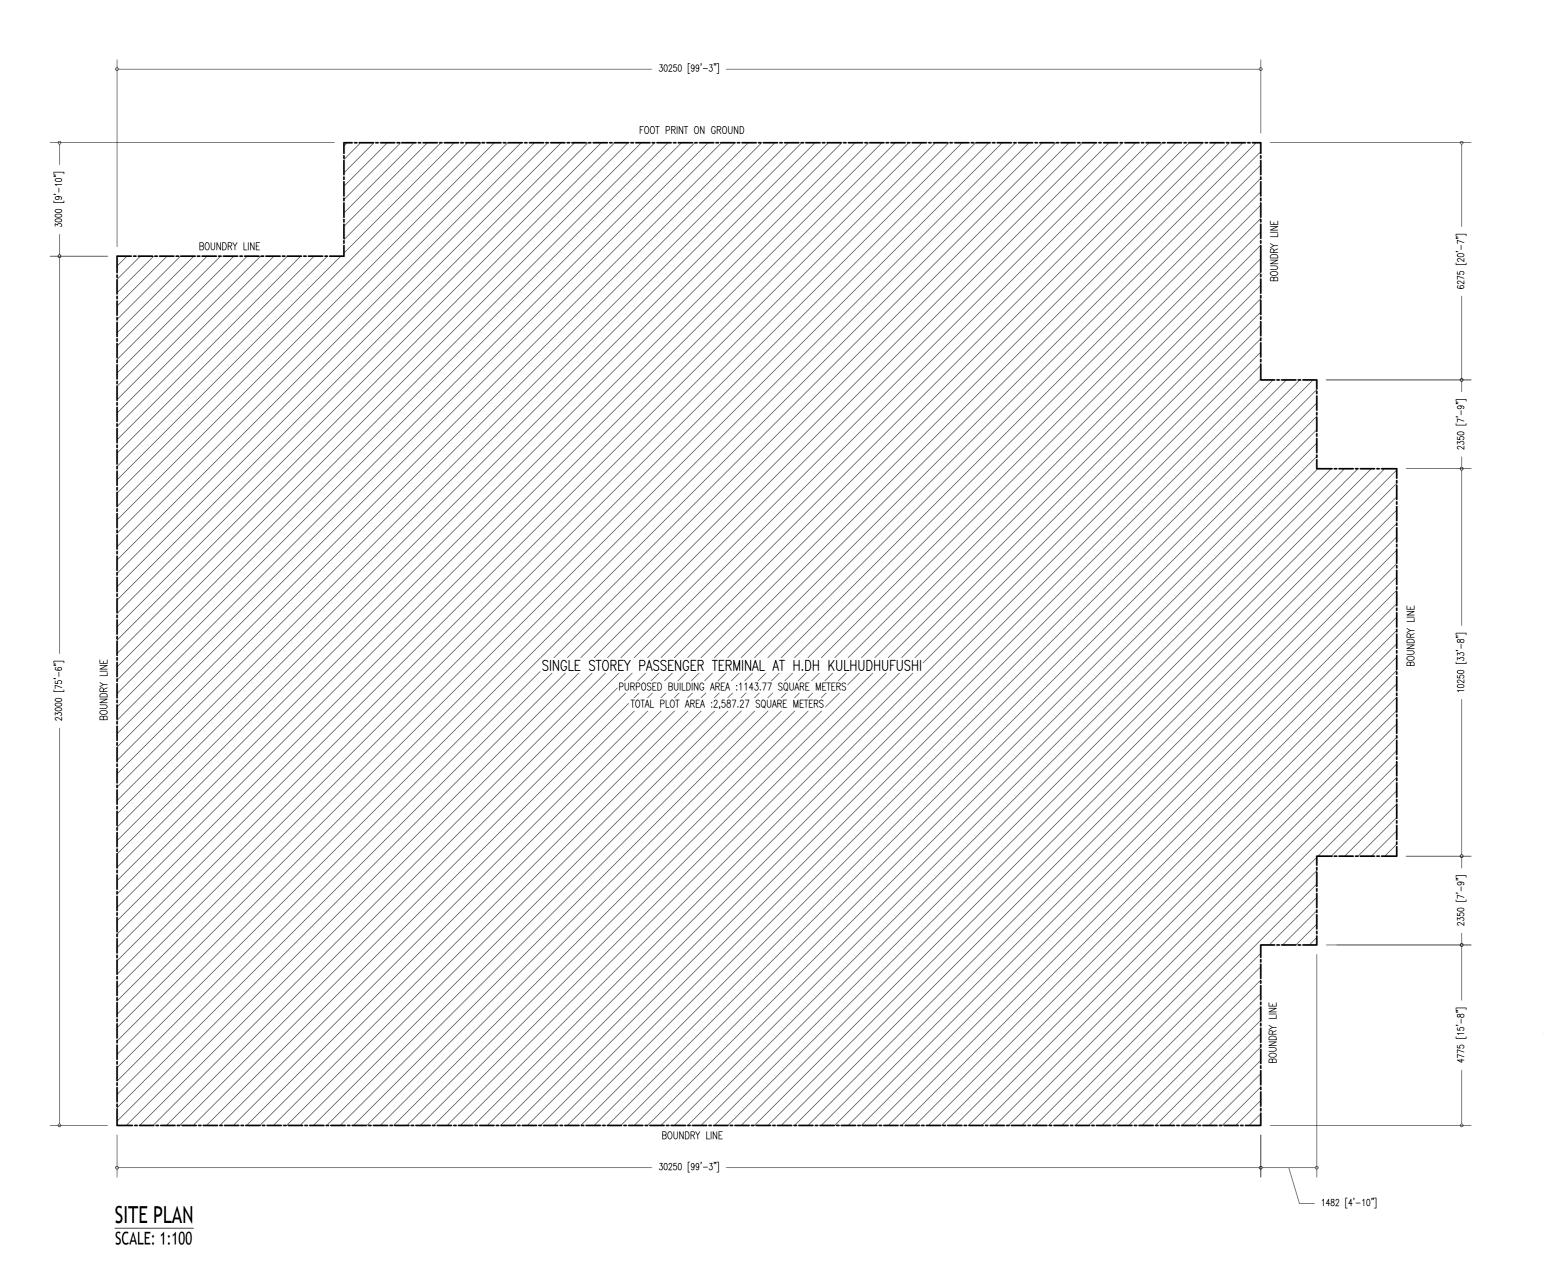

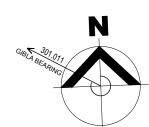

BUILDING STATISTICS

ZONE-CATAGORY COMMERCIAL

TOTAL PLOT AREA	SQM 2,587.27	SQF 27849.14
PROPOSED BUILDING FOOT PRINT	742.5	7992.20
GROSS FLOOR AERA	≈742.5	≈7992.20
OPEN AREA	17.4	187.29

TOTAL CAPACITY OF THE TERMINAL


≈140 PASSENGERS 70 PAX PER BAY (TOTAL TWO BAYS)

NOTE; ALL WALLS ARE OF 200MM, UNLESS STATED OTHERWISE



N:	PRINCIPAL ARCHITECT: MOHAMED HAMEEN	
	ARCHITECT: AHMED AMEEL SHAKEEL	_
	PRINCIPAL ENGINEER: MOHAMED AHSAN	
	ENGINEER: SHAUFA AHMED	
	DDAWN DV: MALEEUA IDDAUIM	


ROJECT: SINGLE STOREY FERRY TERMINAL				
OCATION:	ATION: HDH. KULHUDUFUSHI		$\Lambda \Omega \Omega \Lambda$	
RAWING TITLE:	AS GIVEN		A-02A	
LIENT: MINISTRY	OF HOUSING AND INFRAS	TRUCTURE	DWG NO	
CALE: AS GIVEN	DIMENSION: MM	DATE: JAN 2018	PROJECT NO:	

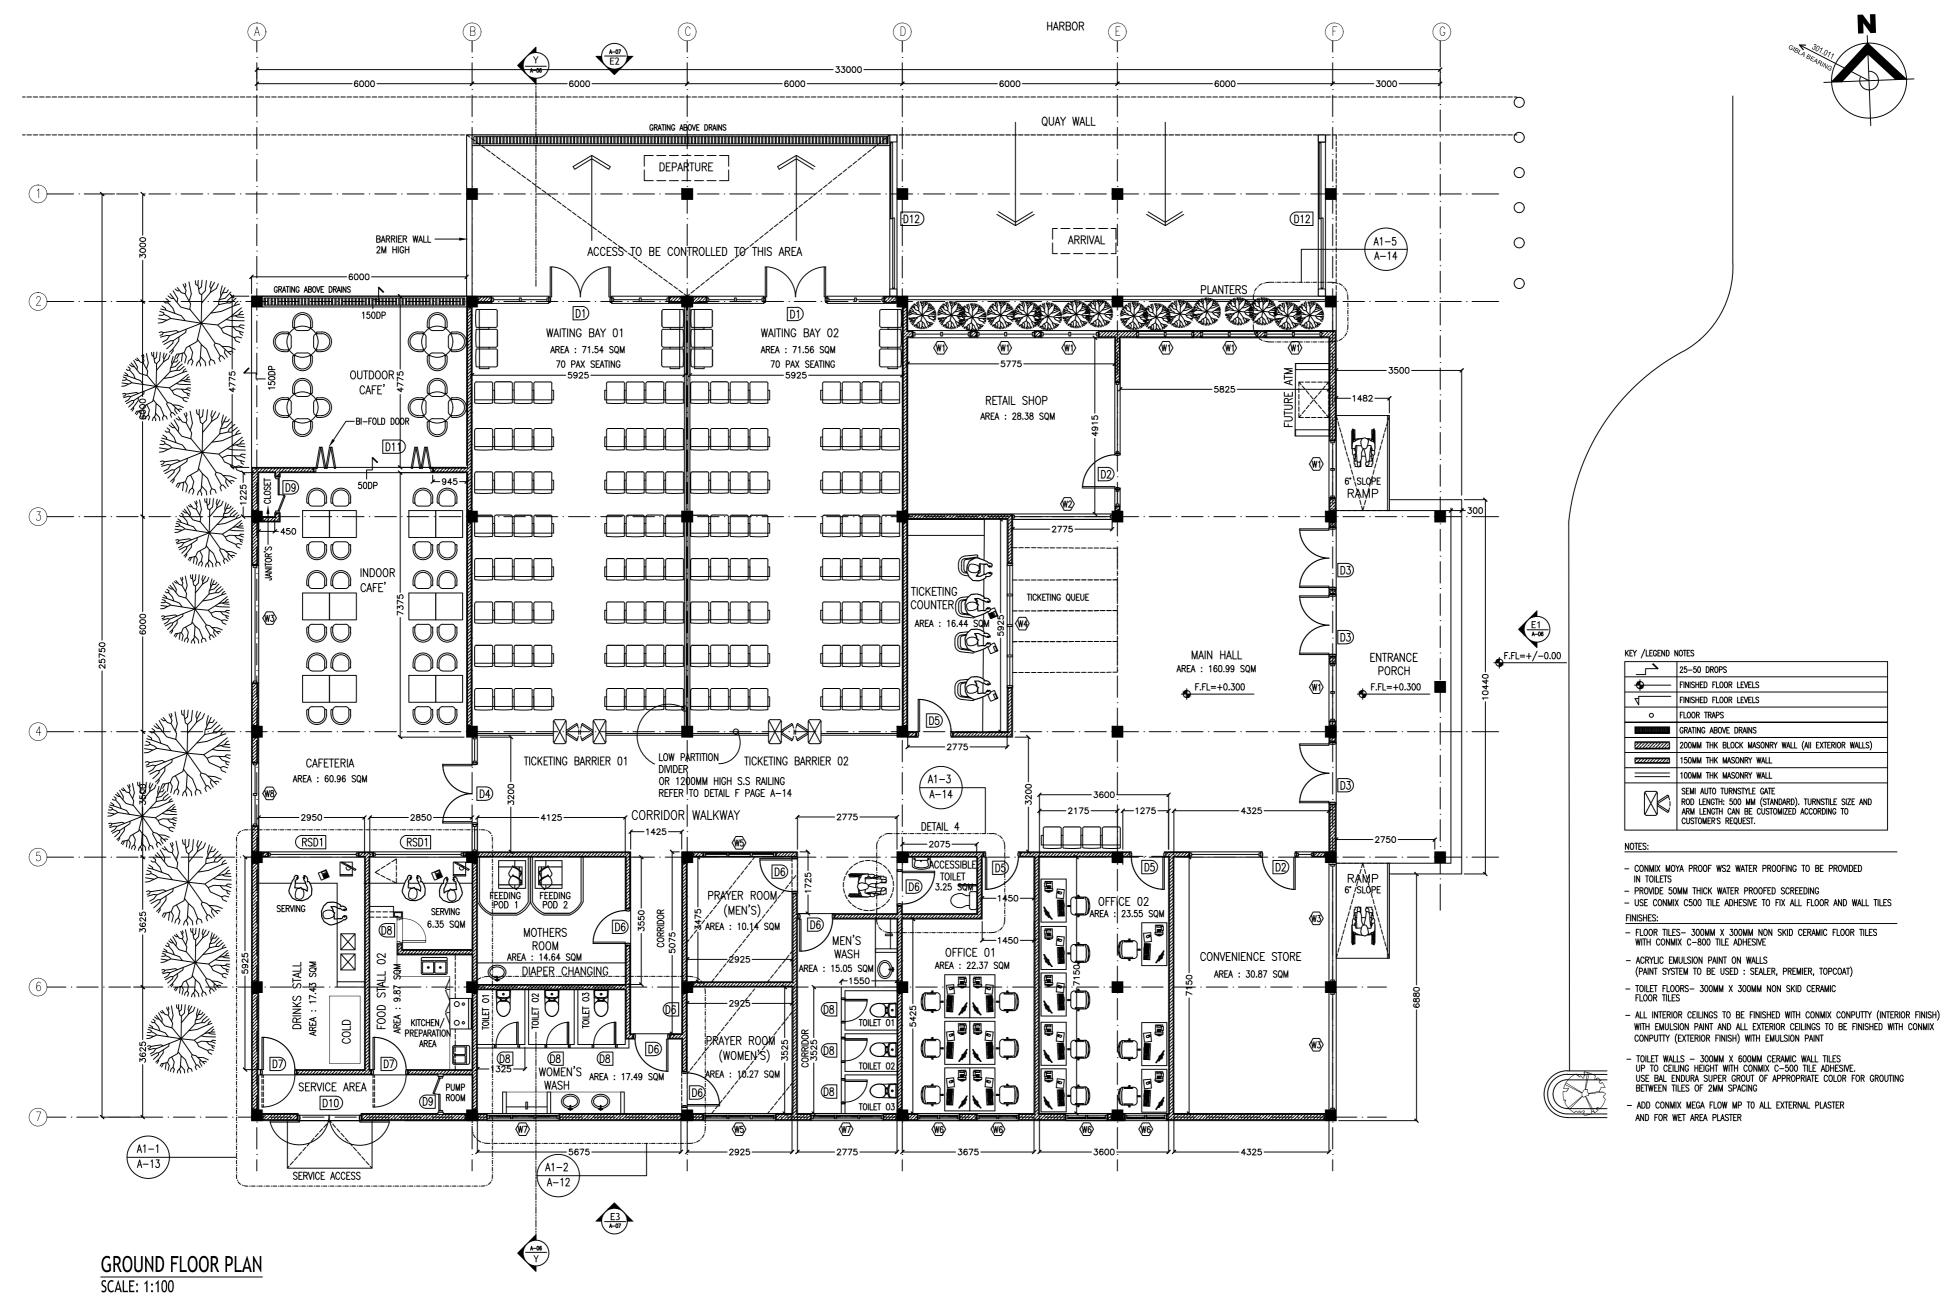

	वाप्कोस लिमिटेड
· with	WAPCOS LIMITED
TA RAIL	(भारत सरकार का उपक्रम)
जल	। संसाधन, नदी विकास व गंगा संरक्षण मंत्रालय
	(A Government of India Undertaking)

SION:	PRINCIPAL ARCHITECT: MOHAMED HAMEEN
	ARCHITECT: AHMED AMEEL SHAKEEL
	PRINCIPAL ENGINEER: MOHAMED AHSAN
	ENGINEER: SHAUFA AHMED

ROJECT: S	INGLE STOREY FERRY T		
OCATION: HDH. KULHUDUFUSHI		V U3	
RAWING TITLE:	WING TITLE: AS GIVEN		A- U3
JENT: MINISTRY OF HOUSING AND INFRASTRUCTURE		DWG NO	
CALE: AS GIVEN	DIMENSION: MM	DATE: JAN 2018	PROJECT NO:

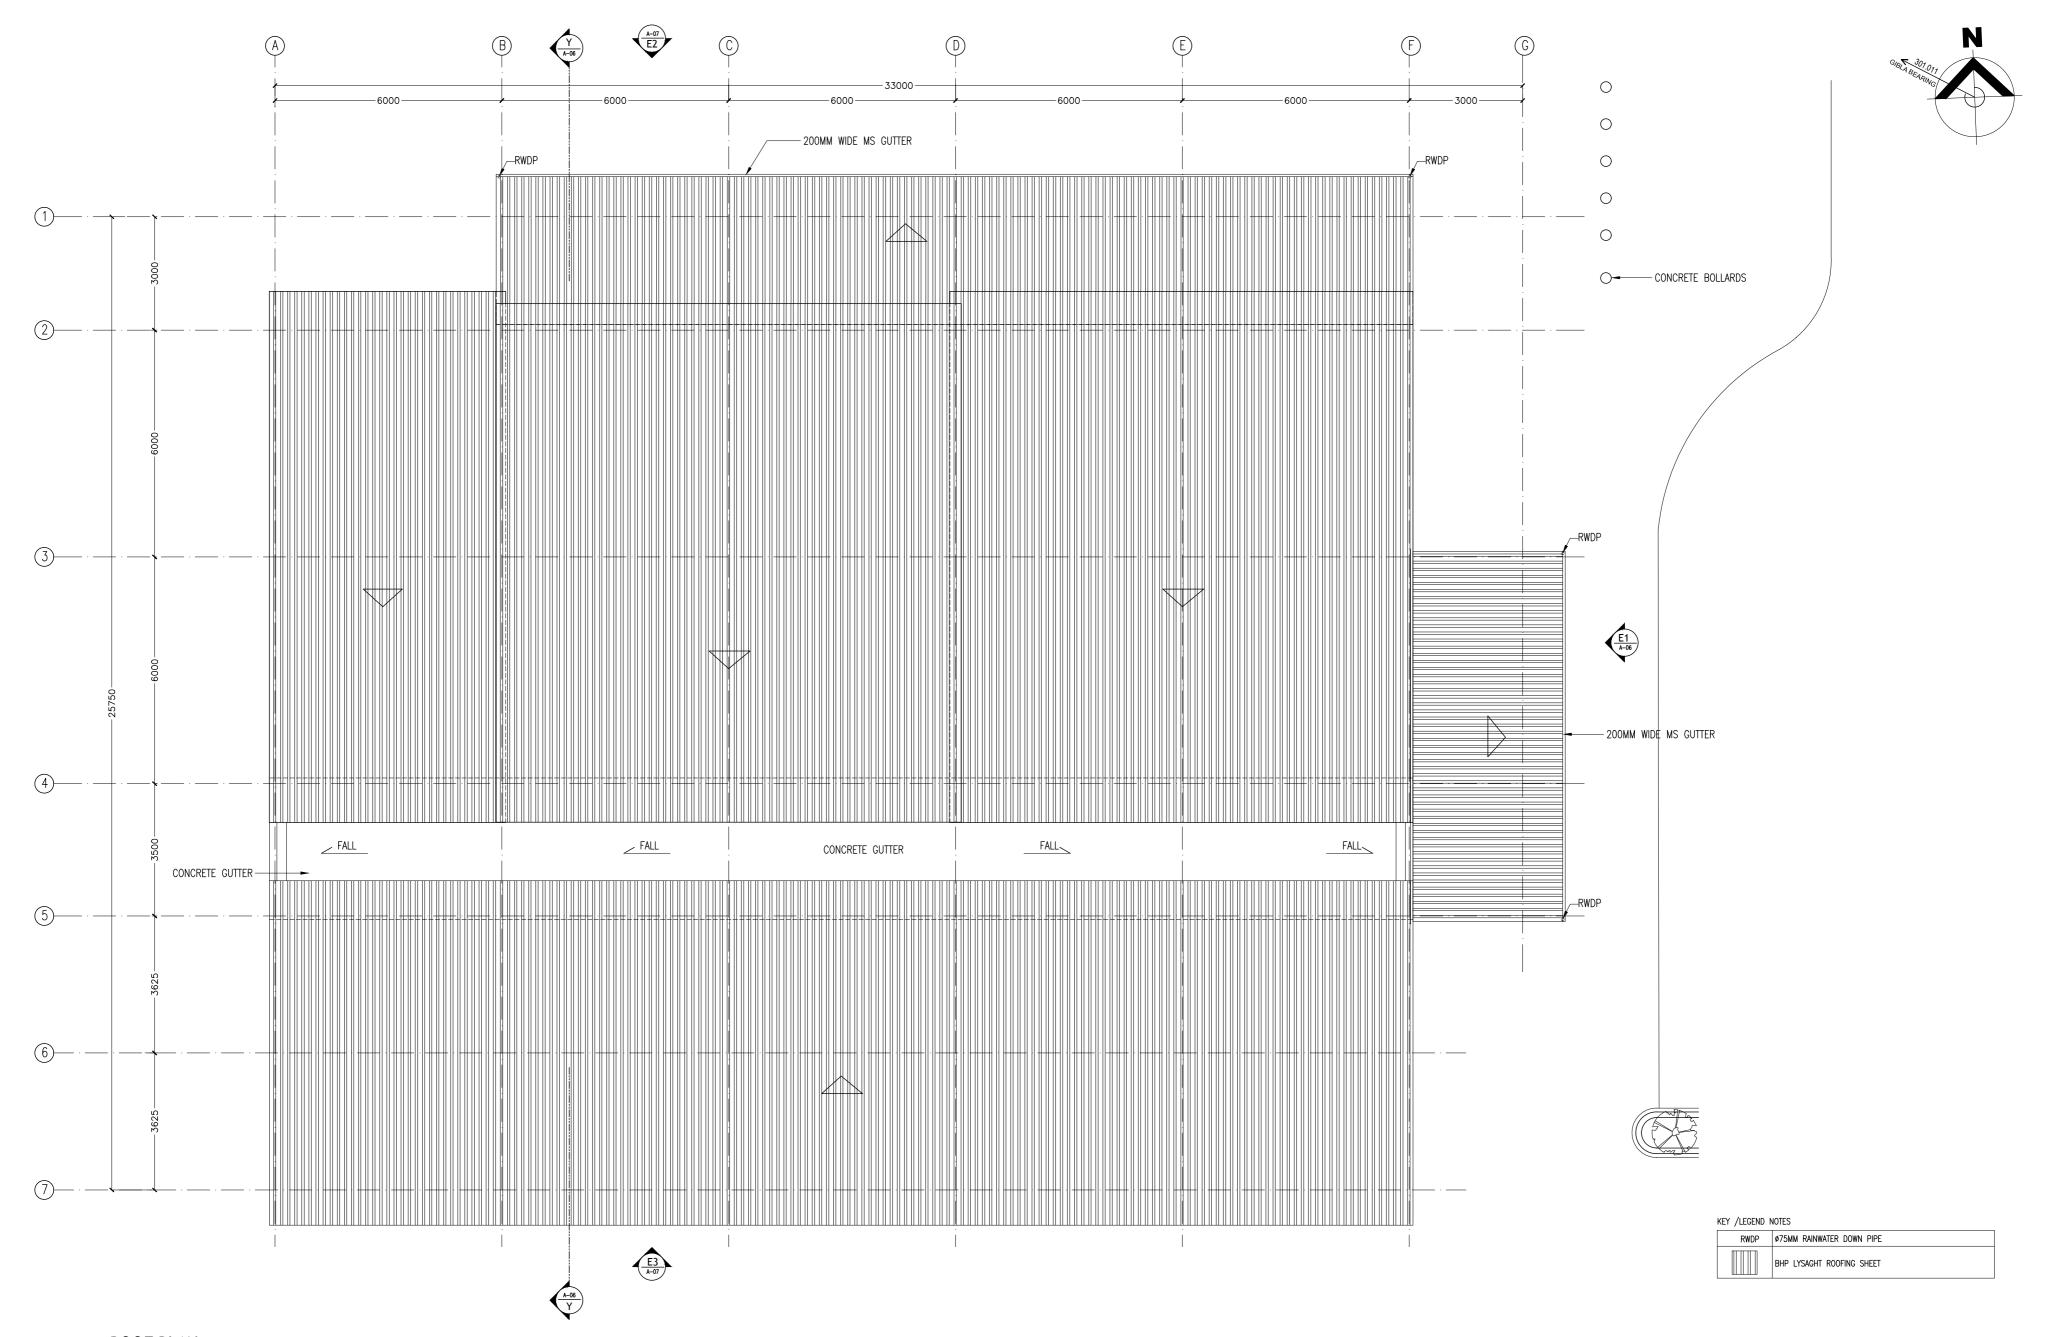

ROOF PLAN SCALE: 1:100

WAPCOS LIMITED
(भारत सरकार का उपक्रम)
जल संसाम, नदी विकास व गंगा संस्था भंगालय
(A Government of India Undertaking)
Ministry of Water Resources, River Development & Ganga Relievenation

PRINCIPAL ARCHITECT: MOHAMED HAMEEN

ARCHITECT: AHMED AMEEL SHAKEEL

PRINCIPAL ENGINEER: MOHAMED AHSAN

ENGINEER: SHAUFA AHMED

DRAWN BY: MALEEHA IBRAHIM

PROJECT: SINGLE STOREY FERRY TERMINAL


LOCATION: HDH. KULHUDUFUSHI

DRAWING TITLE: AS GIVEN

CLIENT: MINISTRY OF HOUSING AND INFRASTRUCTURE

SCALE: AS GIVEN DIMENSION: MM DATE: JAN 2018


PROJECT NO:

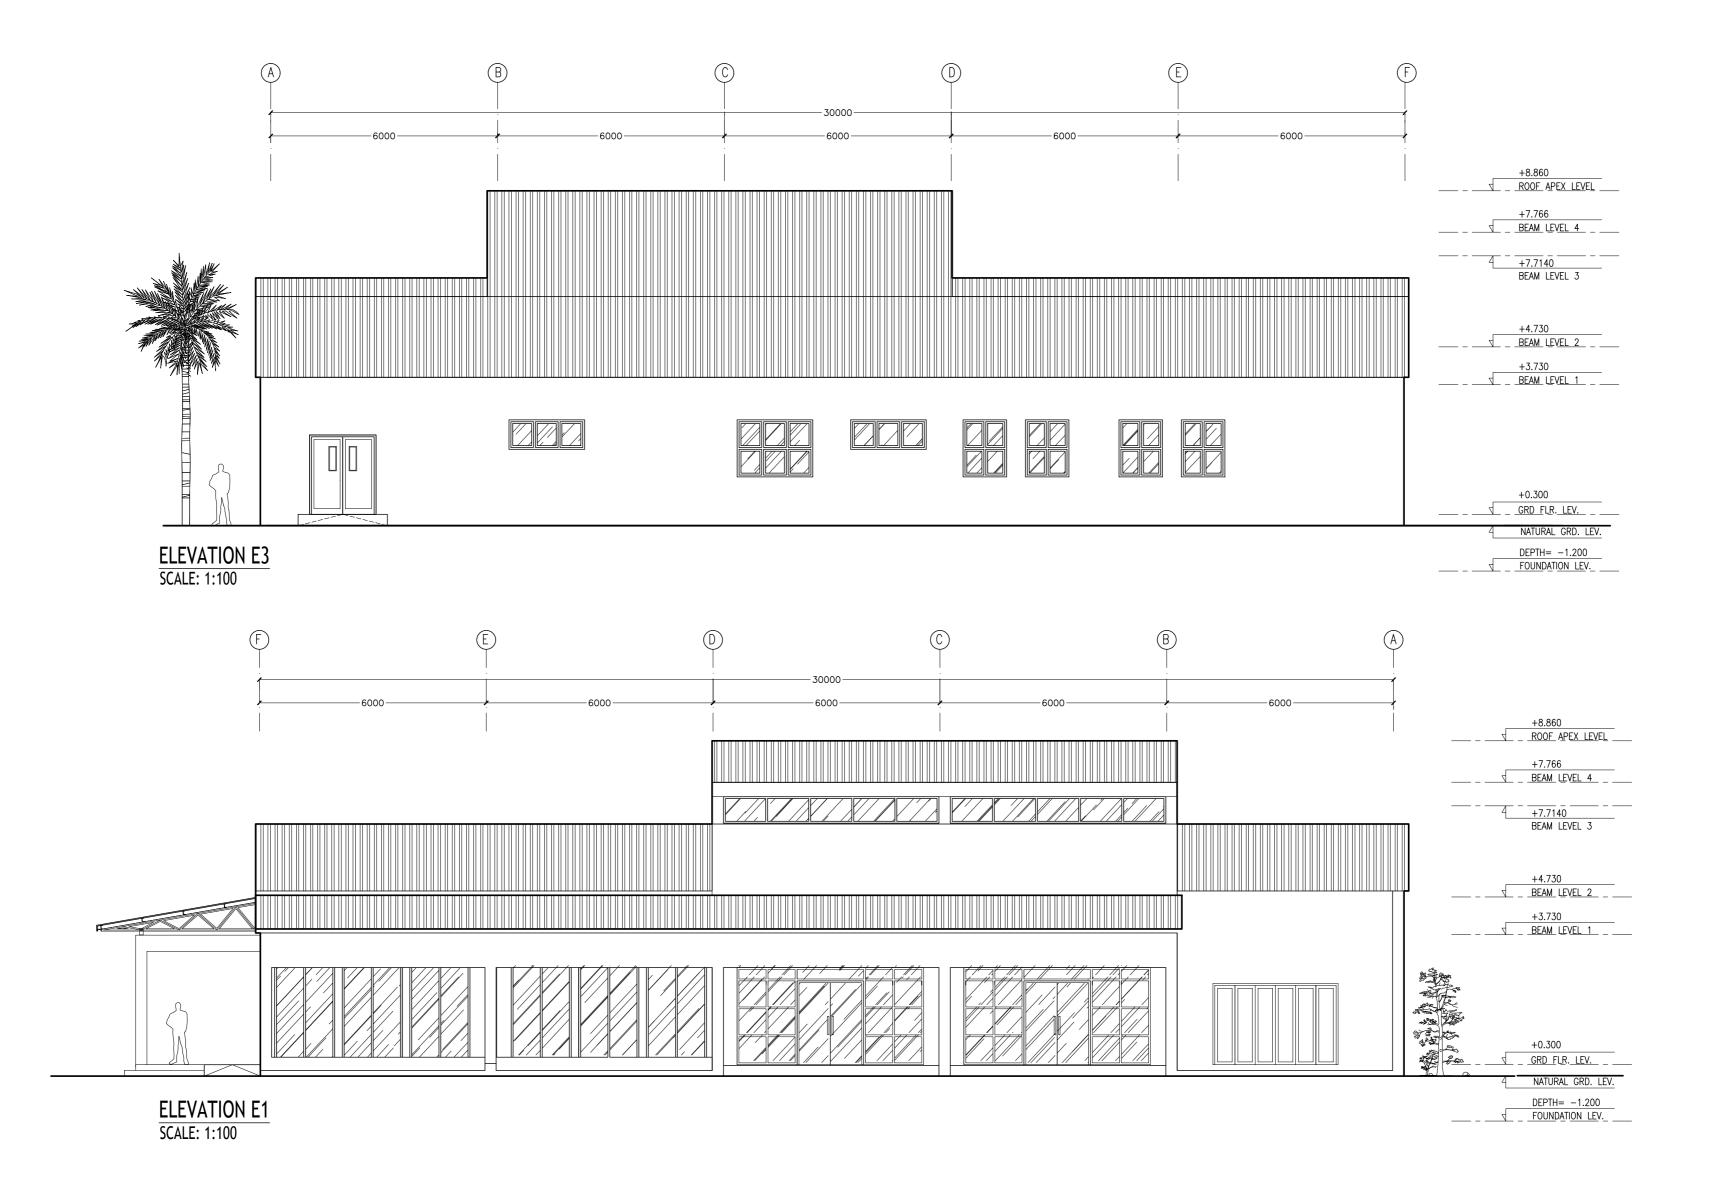


े वाप्कोस लिमिटेड	REVISION:	PRINCIPAL ARCHITECT: MOHAMED HAMEEN	PROJECT: 5	SINGLE STOREY FERRY T	ERMINAL
		ARCHITECT: AHMED AMEEL SHAKEEL	LOCATION:	HDH. KULHUDUFUSHI	
WAPCOS LIMITED		PRINCIPAL ENGINEER: MOHAMED AHSAN	DRAWING TITLE:	AS GIVEN	
(भारत सरकार का उपक्रम) जल संसाधन, नदी विकास व गंगा संरक्षण मंत्रालय		ENGINEER: SHAUFA AHMED	CLIENT: MINISTRY (OF HOUSING AND INFRAS	STRUCTURE
(A Government of India Undertaking)		DRAWN BY: MALEEHA IBRAHIM	SCALE: AS GIVEN	DIMENSION: MM	DATE: JAN 2018

A-05

DWG NO
PROJECT NO:

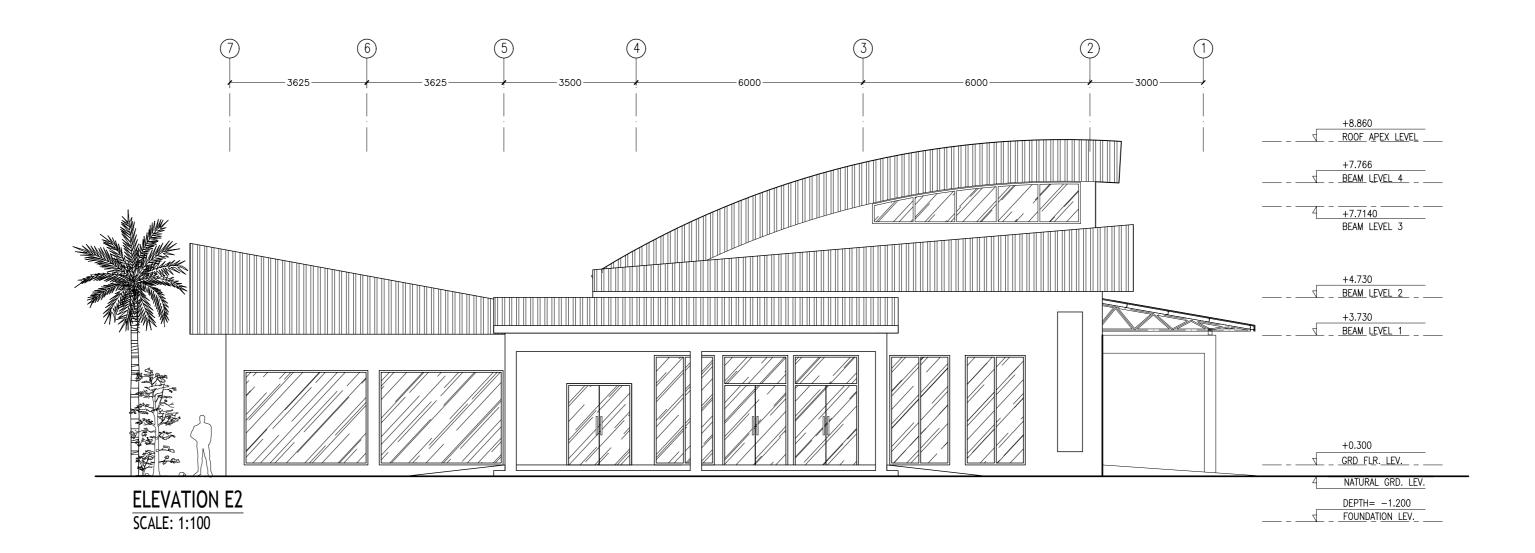


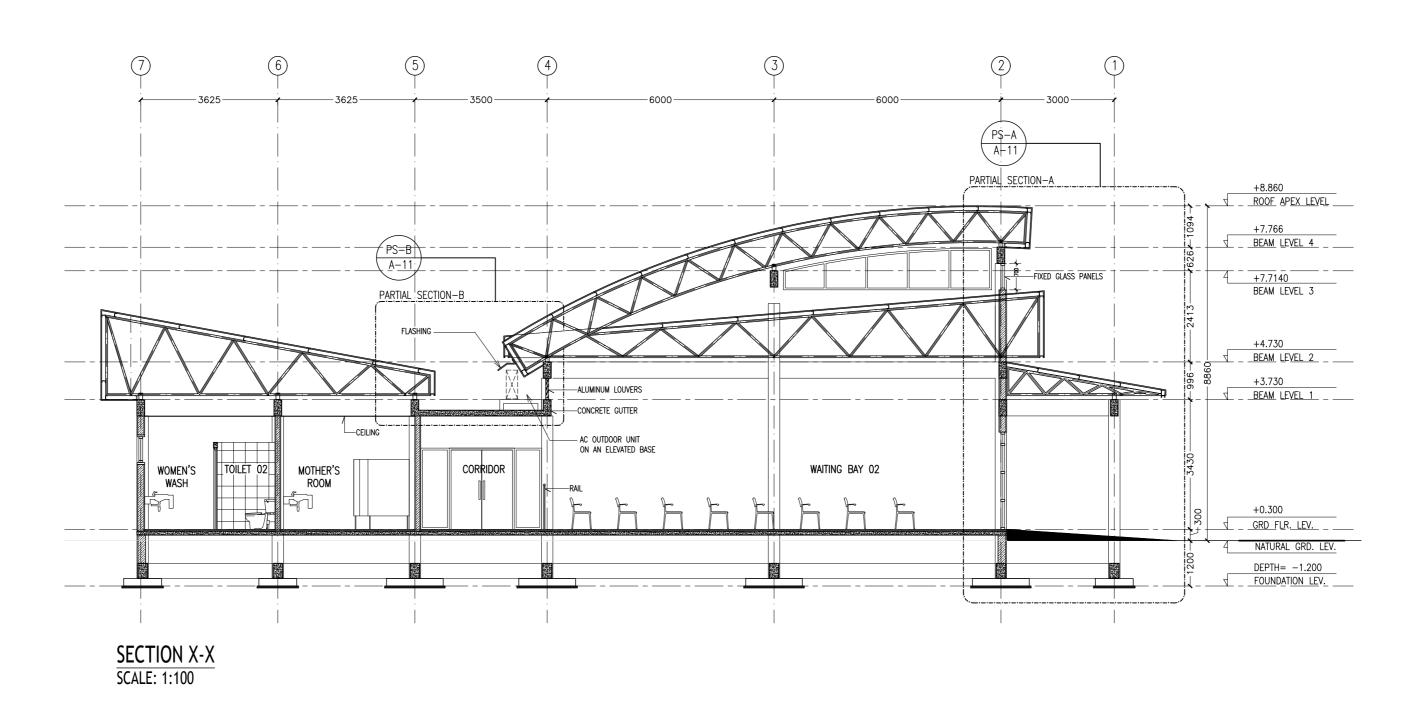



EVISION:	PRINCIPAL ARCHITECT: MOHAMED HAMEEN
	ARCHITECT: AHMED AMEEL SHAKEEL
	PRINCIPAL ENGINEER: MOHAMED AHSAN
	ENGINEER: SHAUFA AHMED
	DDAWN DV AND ESTA IDDAWN

PROJECT:	SINGLE STOREY FERRY TERMINAL		
LOCATION:	HDH. KULHUDUFUSHI		A-06
DRAWING TITLE:	ING TITLE: AS GIVEN		A-UU
CLIENT: MINISTRY OF HOUSING AND INFRASTRUCTURE		DWG NO	
SCALE: AS GIVEN	DIMENSION: MM	DATE: JAN 2018	PROJECT NO:

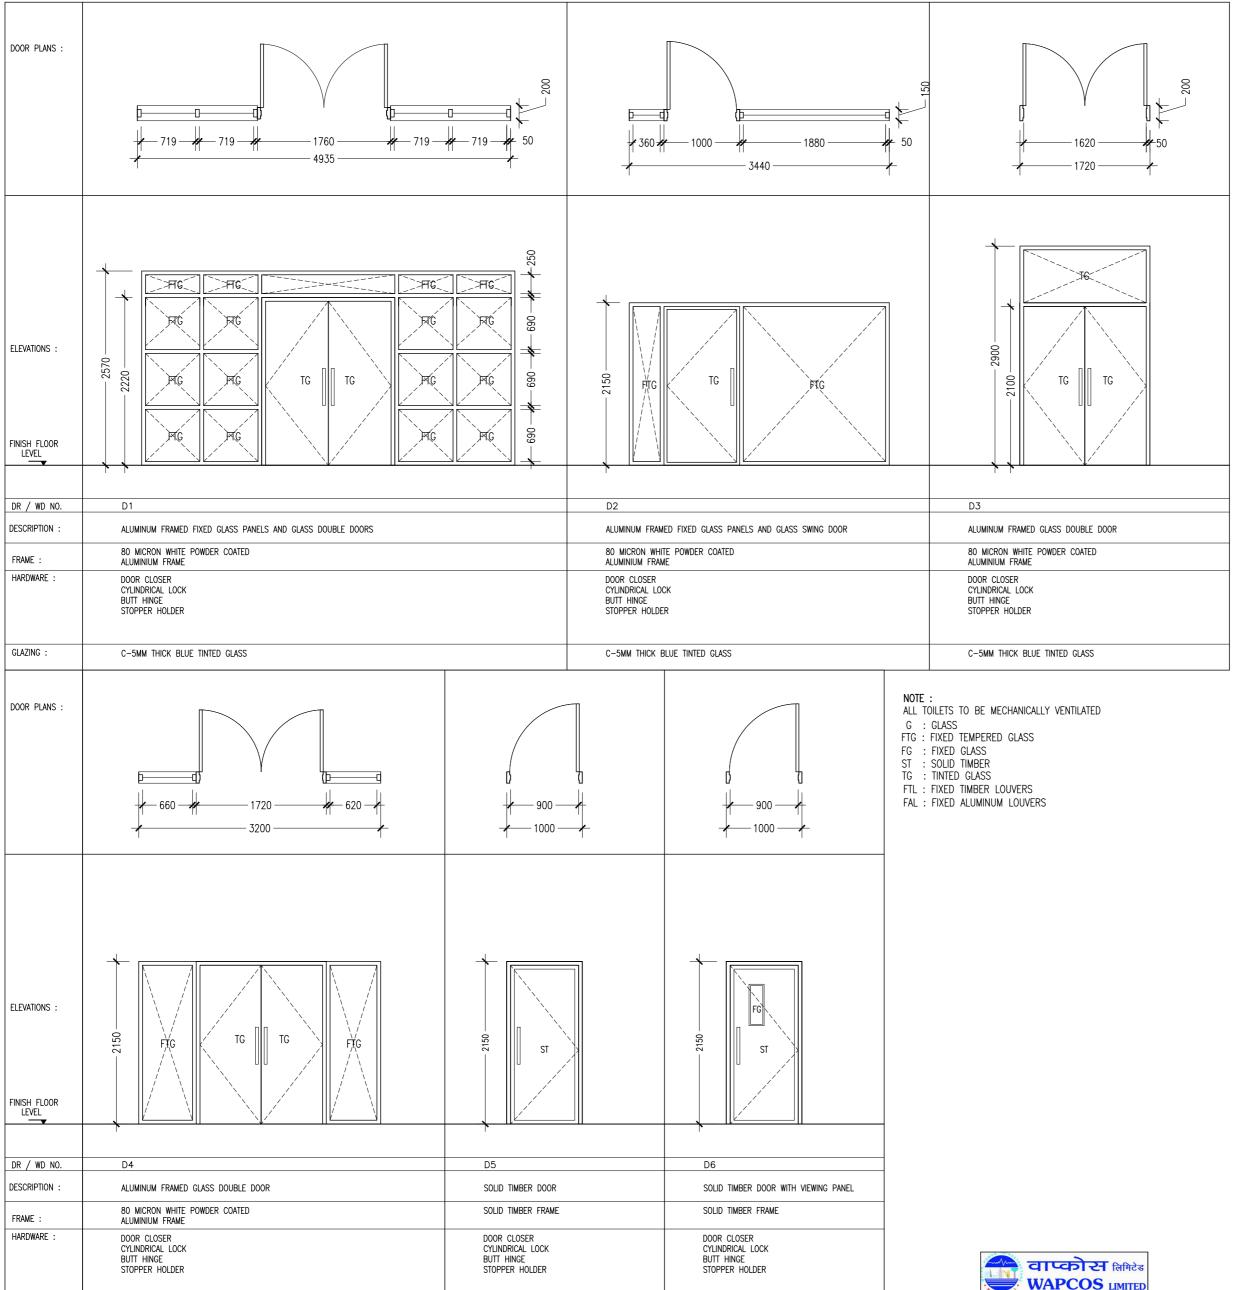

CLEAR GLASS

GLAZING :


C-5MM THICK BLUE TINTED GLASS

DOOR SCHEDULE -01 SCALE 1:50



REVISION:	PRINCIPAL ARCHITECT: MOHAMED HAMEEN	PROJEC
	ARCHITECT: AHMED AMEEL SHAKEEL	LOCATI
	PRINCIPAL ENGINEER: MOHAMED AHSAN	DRAWIN
	ENGINEER: SHAUFA AHMED	CLIENT
	DRAWN BY: MALEEHA IBRAHIM	SCALE:

PROJECT:	SINGLE STOREY FERRY TERMINAL		
 LOCATION:	HDH. KULHUDUFUSHI		A_07
 DRAWING TITLE:	AS GIVEN		A-U /
CLIENT: MINISTRY	OF HOUSING AND INFRAS	TRUCTURE	DWG NO
 SCALE: AS GIVEN	DIMENSION: MM	DATE: JAN 2018	PROJECT NO:

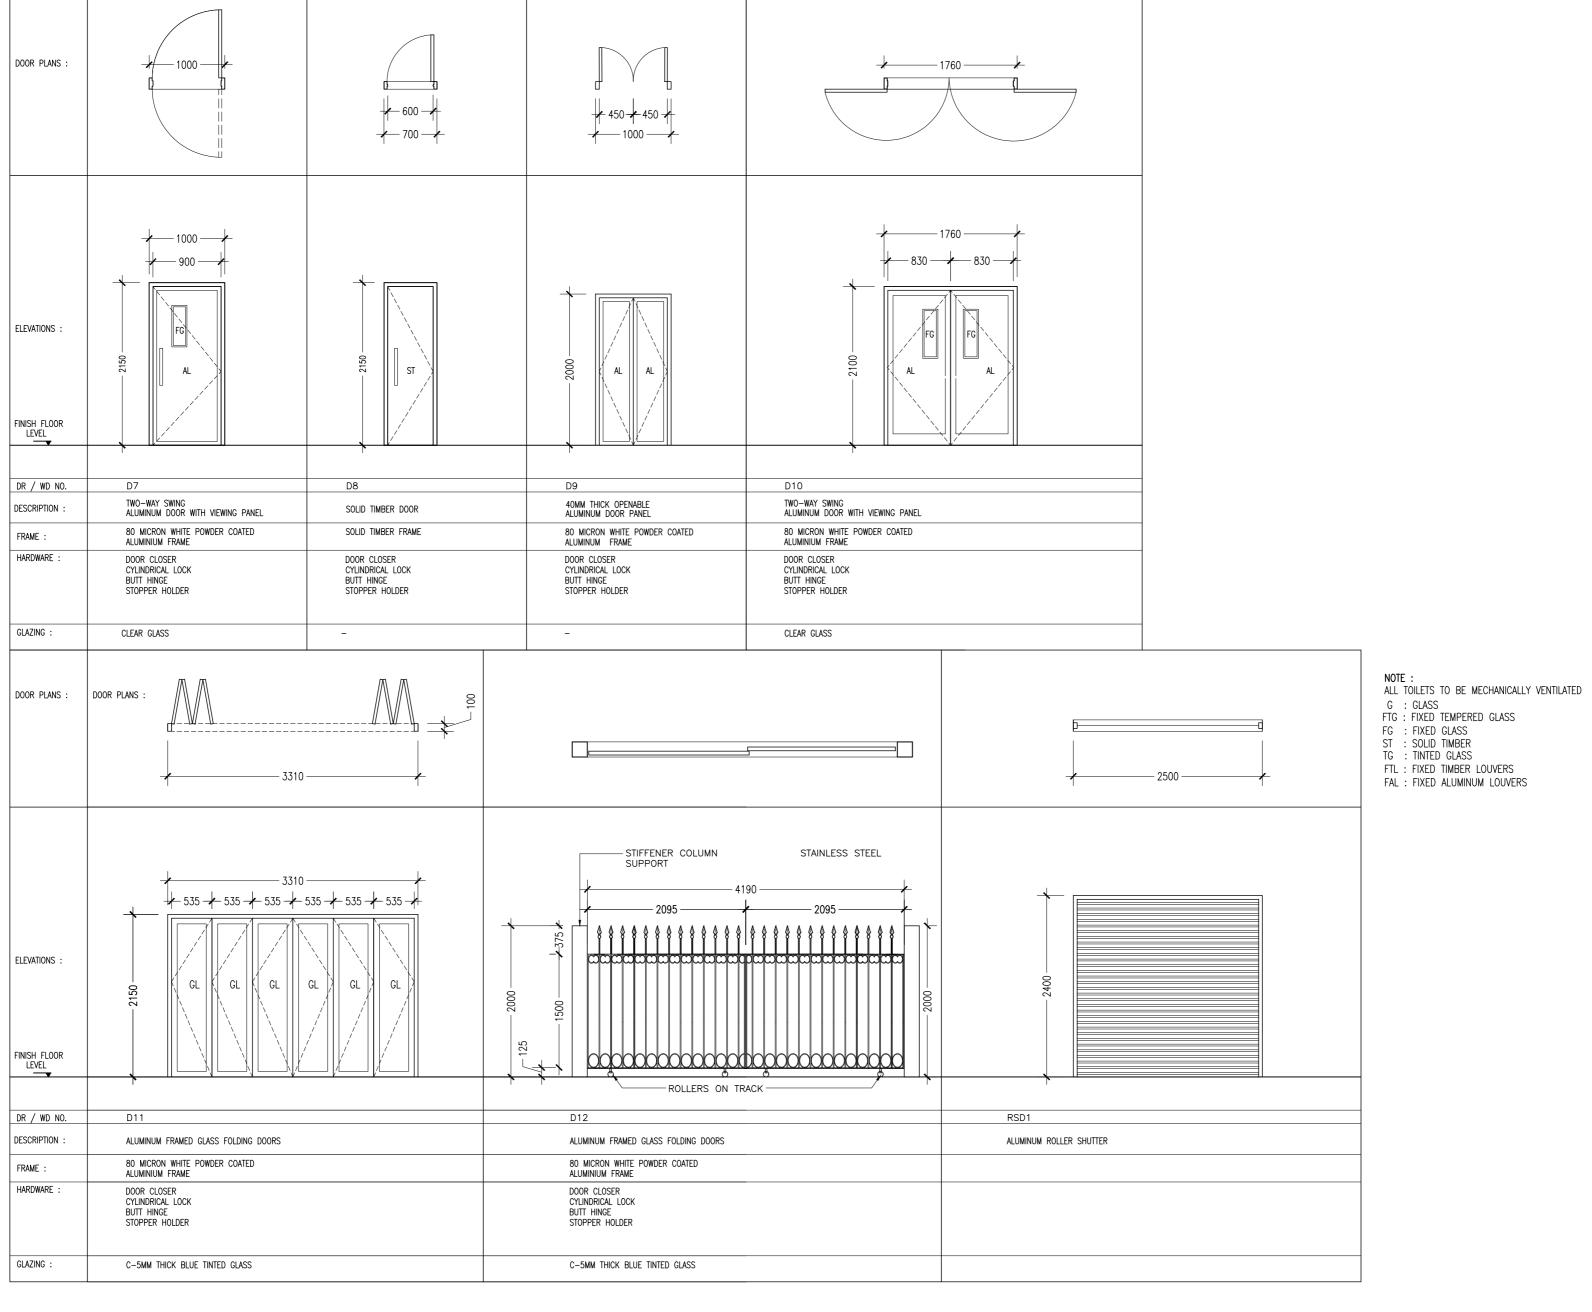


OOOR SCHEDULE -02 SCALE 1:50



EVISION:	PRINCIPAL ARCHITECT: MOHAMED HAMEEN
	ARCHITECT: AHMED AMEEL SHAKEEL
	PRINCIPAL ENGINEER: MOHAMED AHSAN
	ENGINEER: SHAUFA AHMED
	DDAMN BY: MAI FEHA IDDAHIM

PROJECT: S	SINGLE STOREY FERRY T	ERMINAL	
LOCATION:	HDH. KULHUDUFUSHI		$\Lambda \Omega \Omega$
DRAWING TITLE:	AS GIVEN		A-U8
CLIENT: MINISTRY	OF HOUSING AND INFRAS	TRUCTURE	DWG NO
SCALE: AS GIVEN	DIMENSION: MM	DATE: JAN 2018	PROJECT NO:

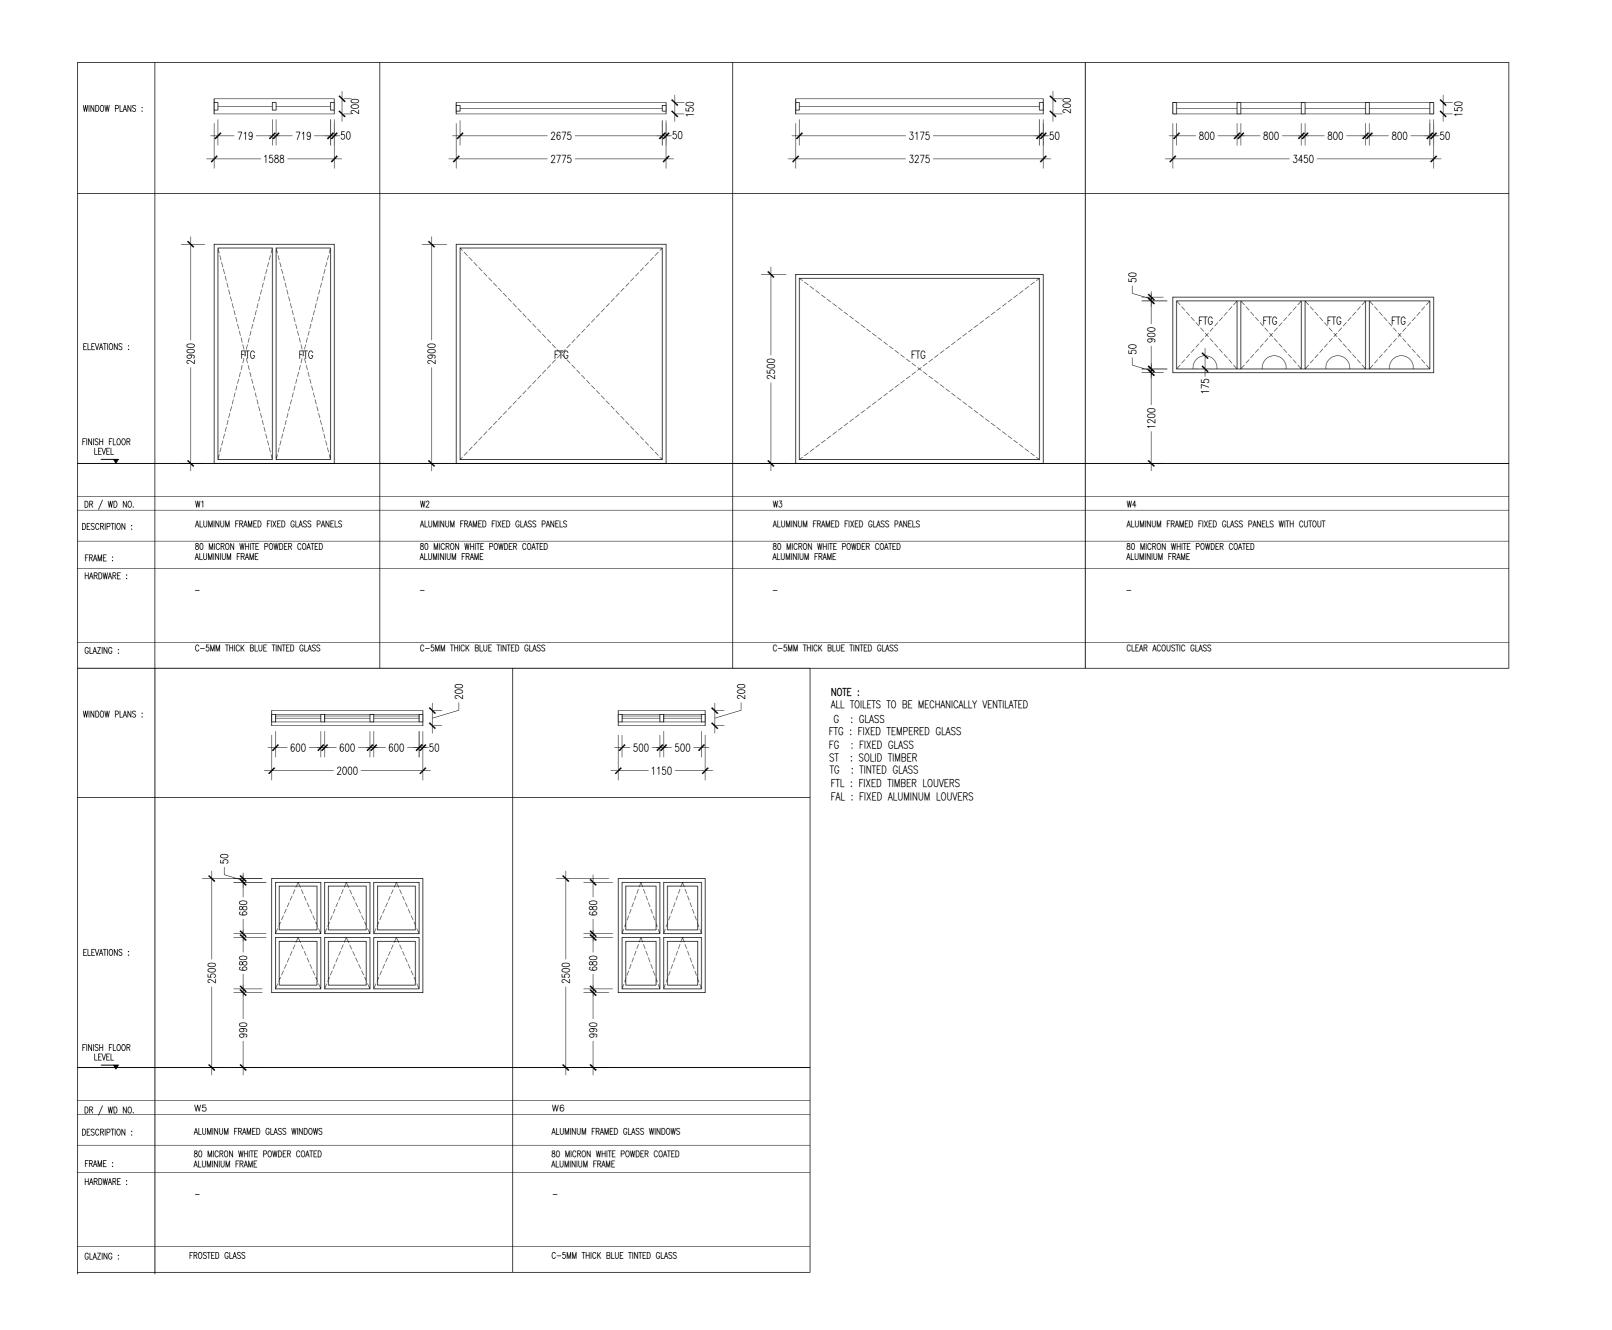



WINDOW SCHEDULE -01 SCALE 1:50



	REVISION:	PRINCIPAL ARCHITECT: MOHAMED HAME
वाप्कोस लिमिटेड		ARCHITECT: AHMED AMEEL SHAKEEL
WAPCOS LIMITED		PRINCIPAL ENGINEER: MOHAMED AHSAN
(भारत सरकार का उपक्रम)		ENGINEER: SHAUFA AHMED
संसाधन, नदी विकास व गंगा संरक्षण मंत्रालय		DRAWN BY: MALEEHA IBRAHIM

PROJECT:	SINGLE STOREY FERRY T	ERMINAL	
LOCATION:	HDH. KULHUDUFUSHI		Λ
DRAWING TITLE:	AS GIVEN		A-U9
CLIENT: MINISTRY	OF HOUSING AND INFRAS	STRUCTURE	DWG NO
SCALE: AS GIVEN	DIMENSION: MM	DATE: JAN 2018	PROJECT NO:

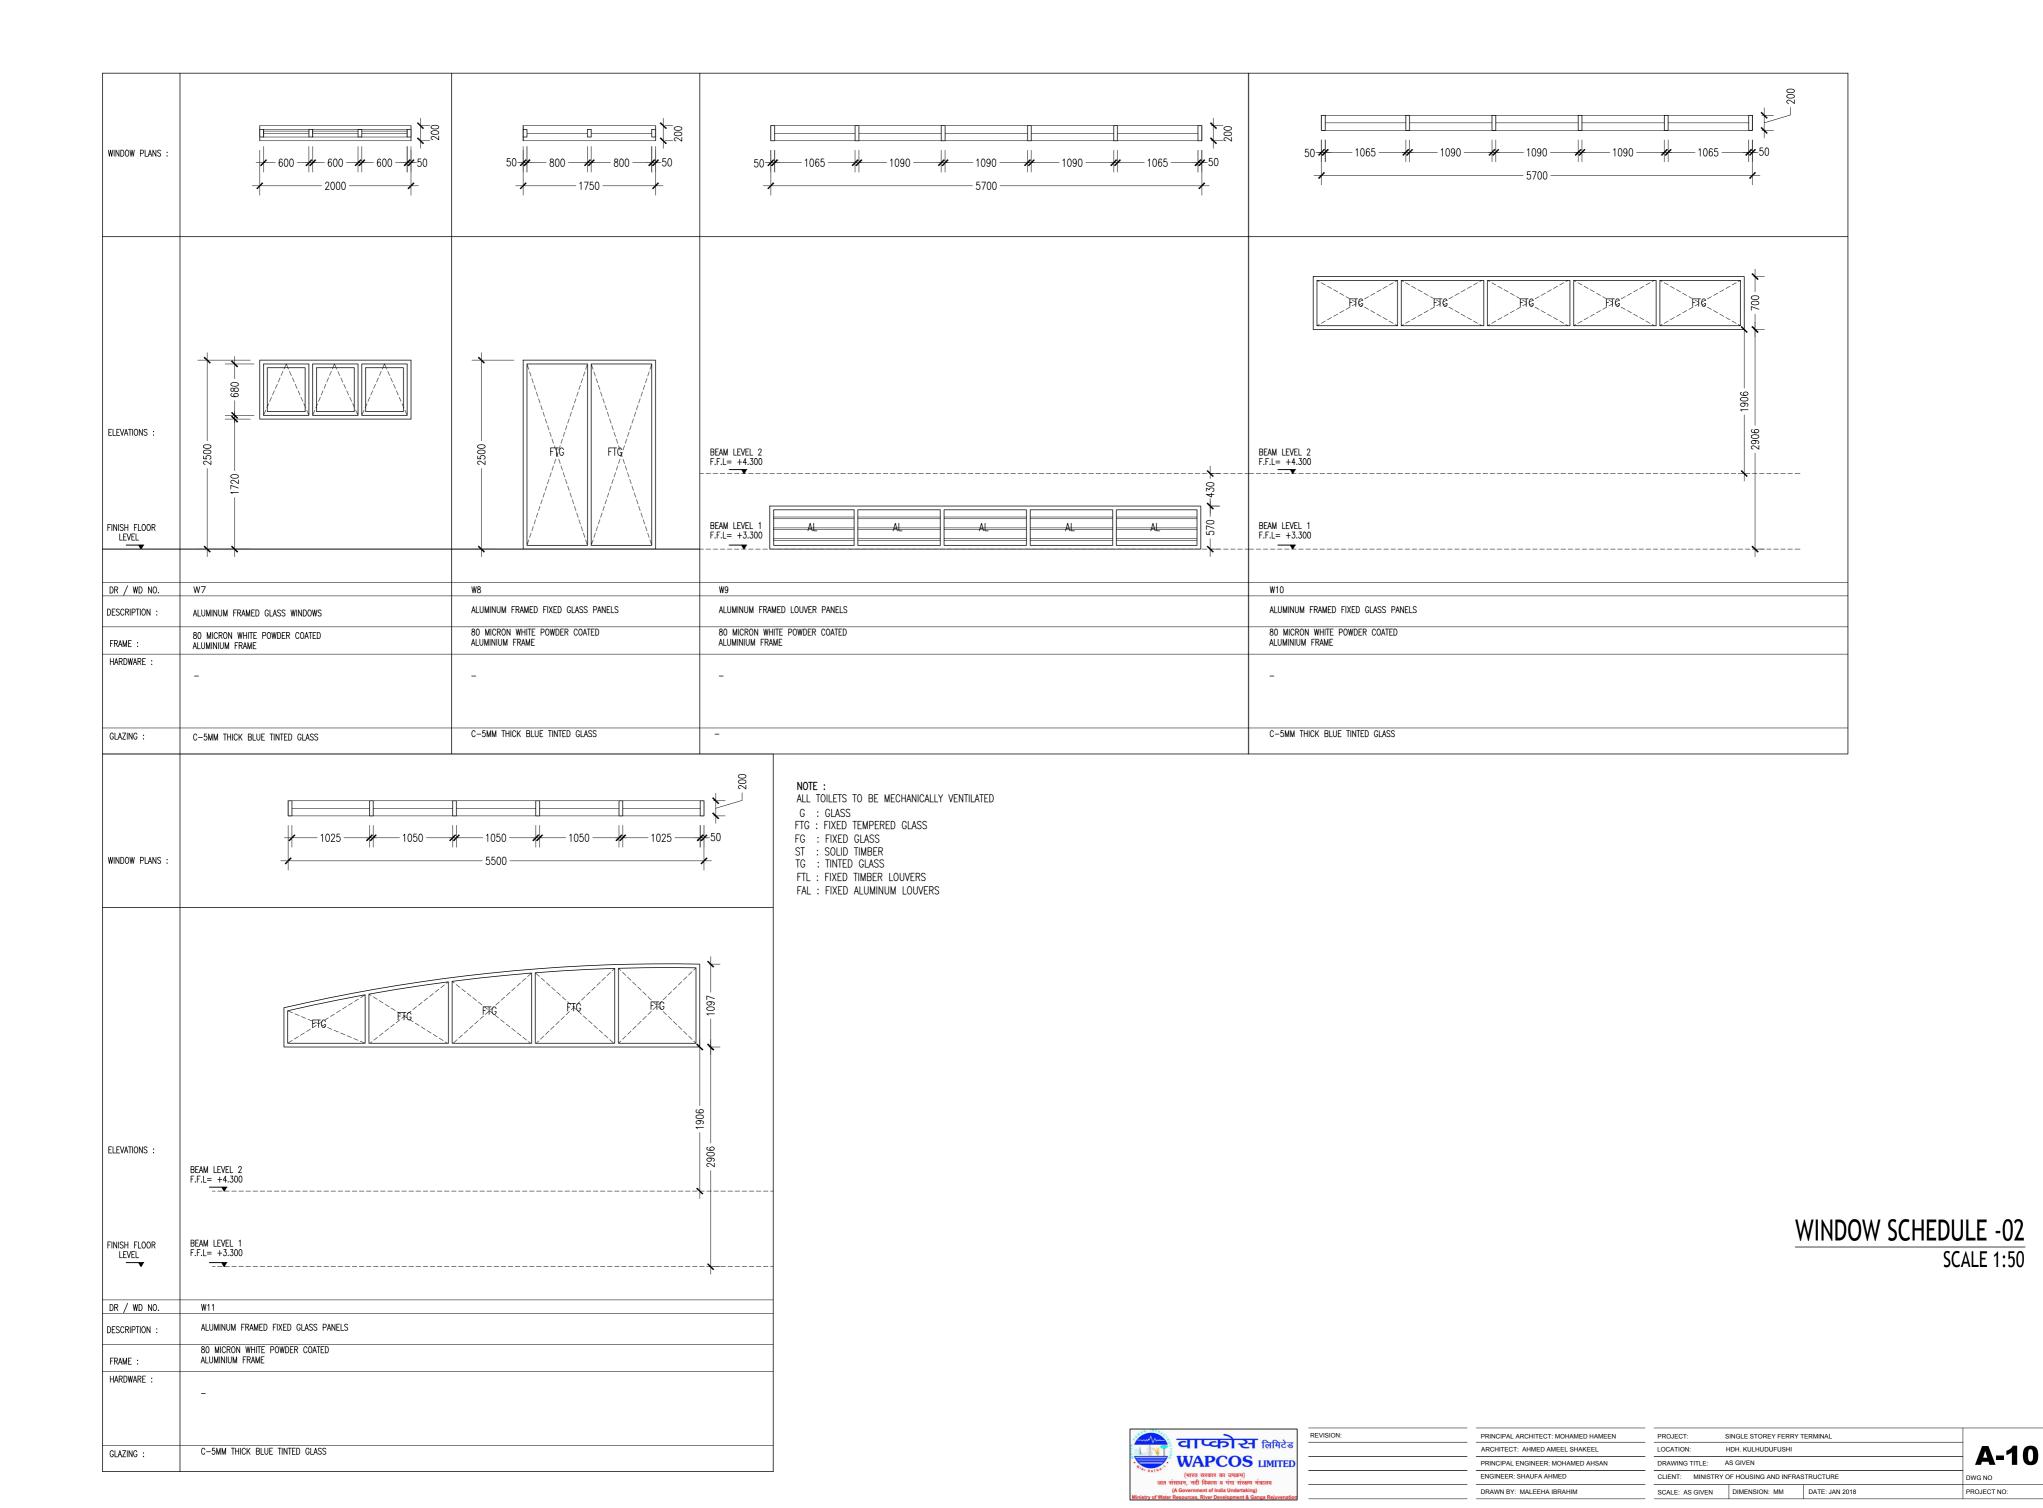

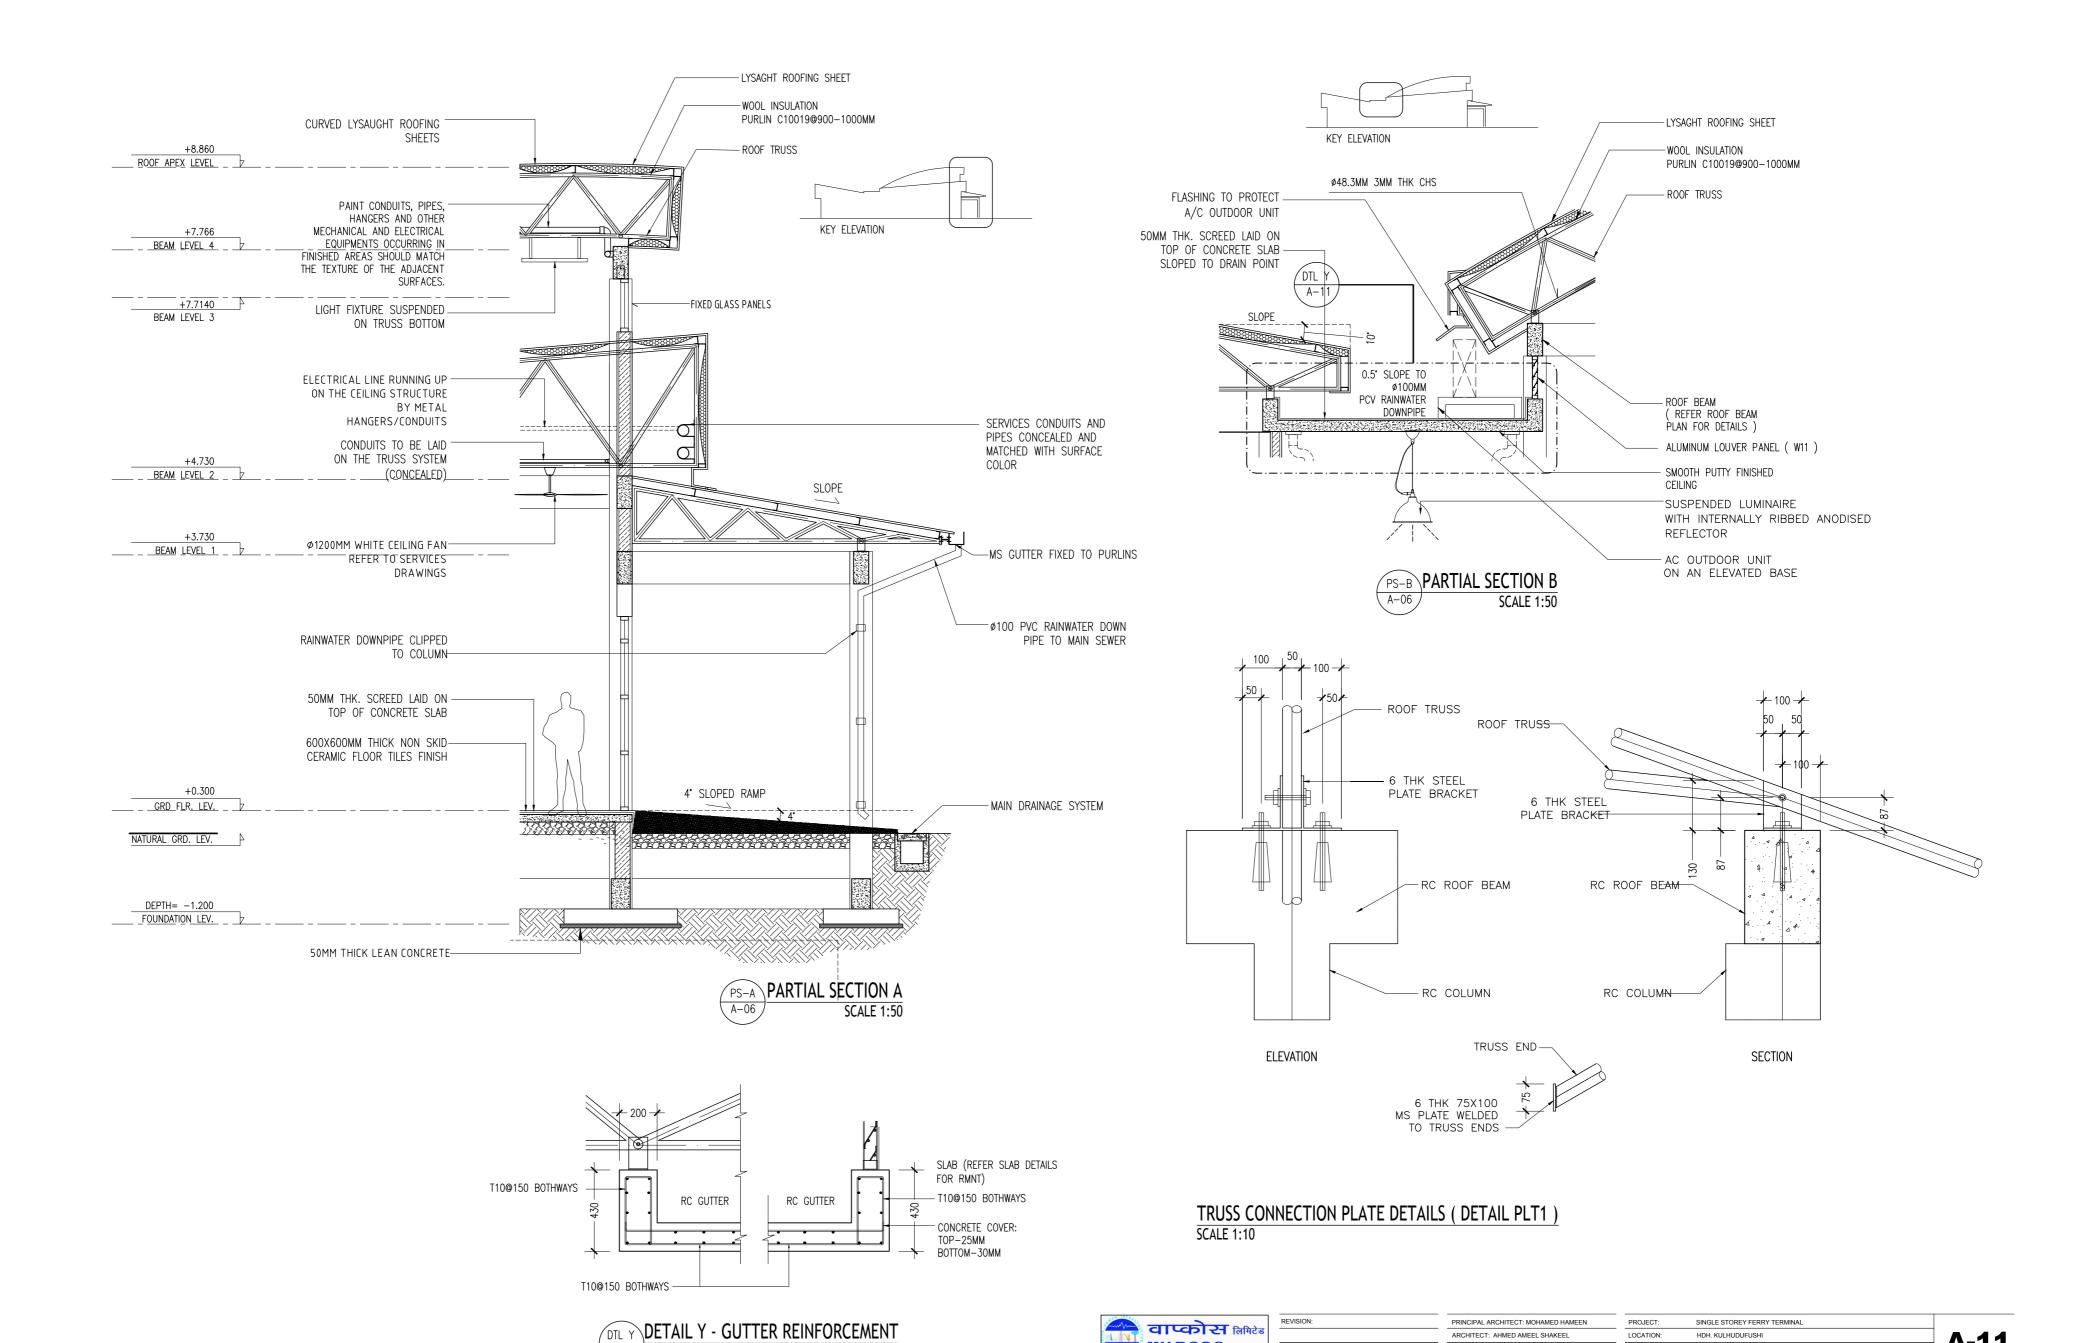

A-11 SCALE 1:20

WAPCOS LIMITED

(भारत सरकार का उपक्रम) जल संसाधन, नदी विकास व गंगा संरक्षण मंत्रालय

A-11

PROJECT NO:

ARCHITECT: AHMED AMEEL SHAKEEL

DRAWN BY: MALEEHA IBRAHIM


PRINCIPAL ENGINEER: MOHAMED AHSAN

LOCATION:

DRAWING TITLE: AS GIVEN

HDH. KULHUDUFUSHI


CLIENT: MINISTRY OF HOUSING AND INFRASTRUCTURE SCALE: AS GIVEN DIMENSION: MM DATE: JAN 2018

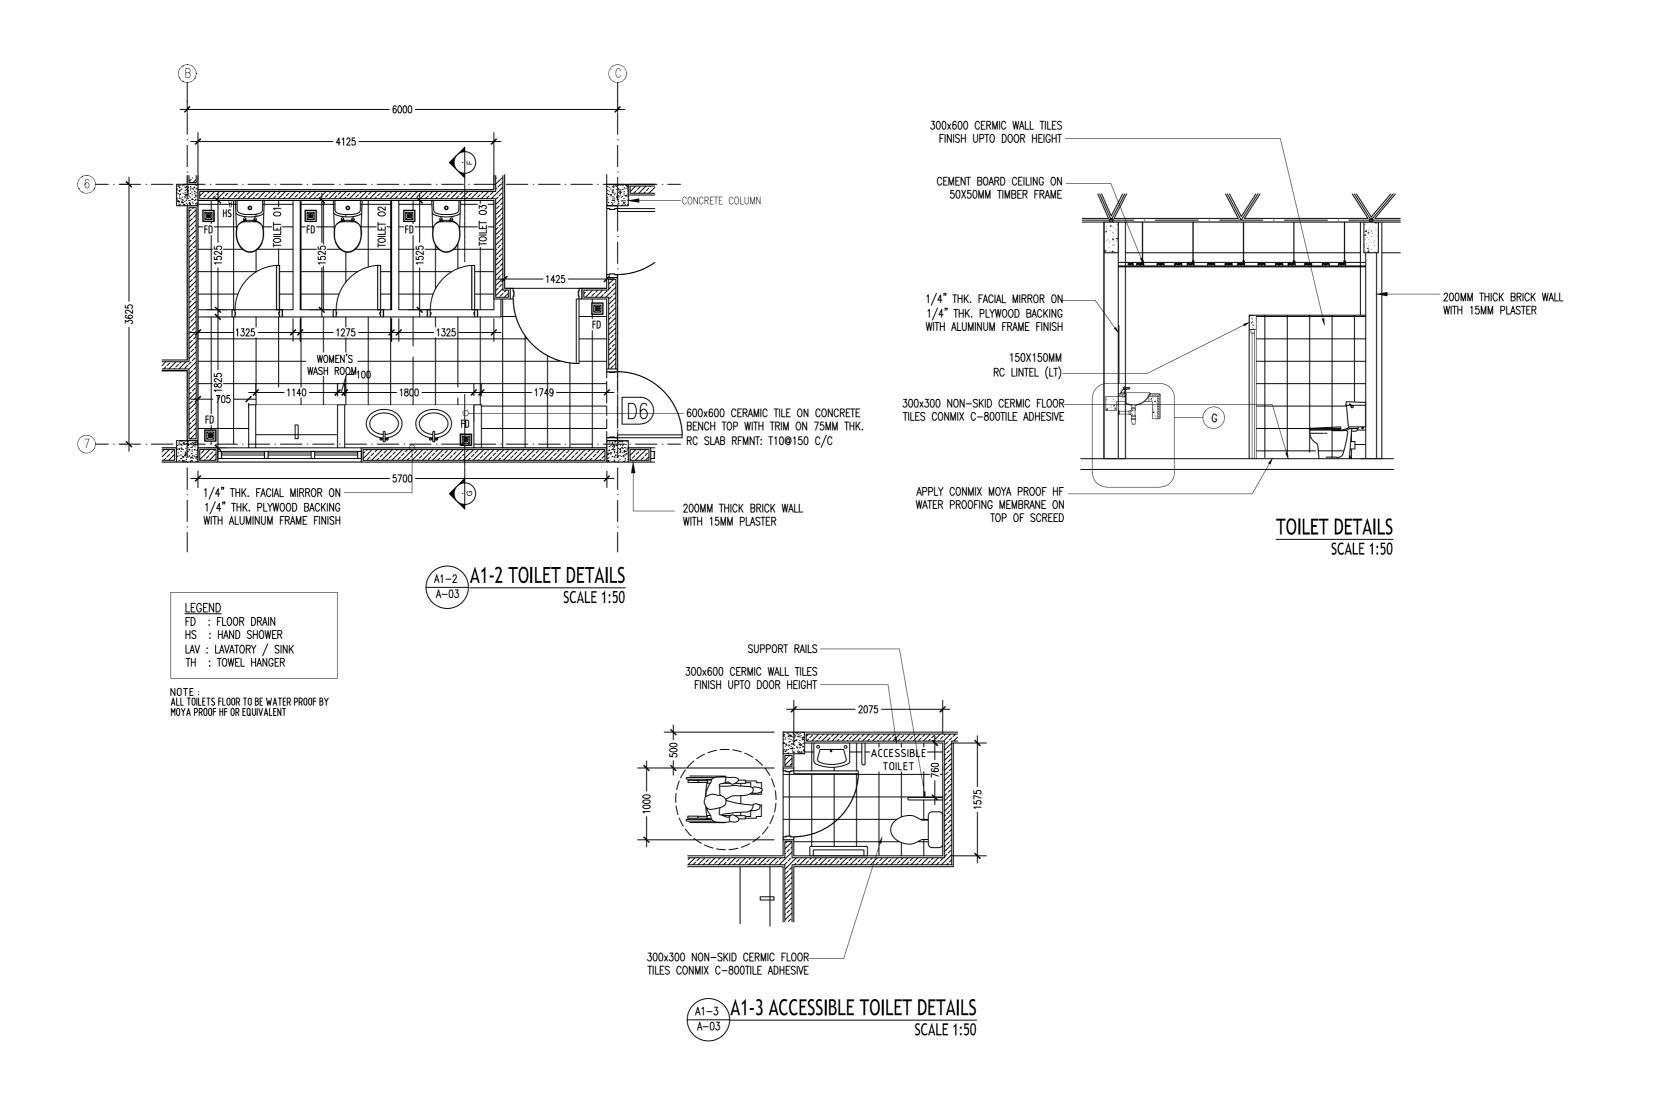




PRINCIPAL ARCHITECT: MOHAMED HAMEEN	PROJECT:	SINGLE STOREY FERRY T	ERMIN
ARCHITECT: AHMED AMEEL SHAKEEL	LOCATION:	HDH. KULHUDUFUSHI	
PRINCIPAL ENGINEER: MOHAMED AHSAN	DRAWING TITLE:	AS GIVEN	
ENGINEER: SHAUFA AHMED	CLIENT: MINISTRY	OF HOUSING AND INFRAS	TRUCT
DRAWN BY: MALEEHA IBRAHIM	SCALE: AS GIVEN	DIMENSION: MM	DATE

A-12

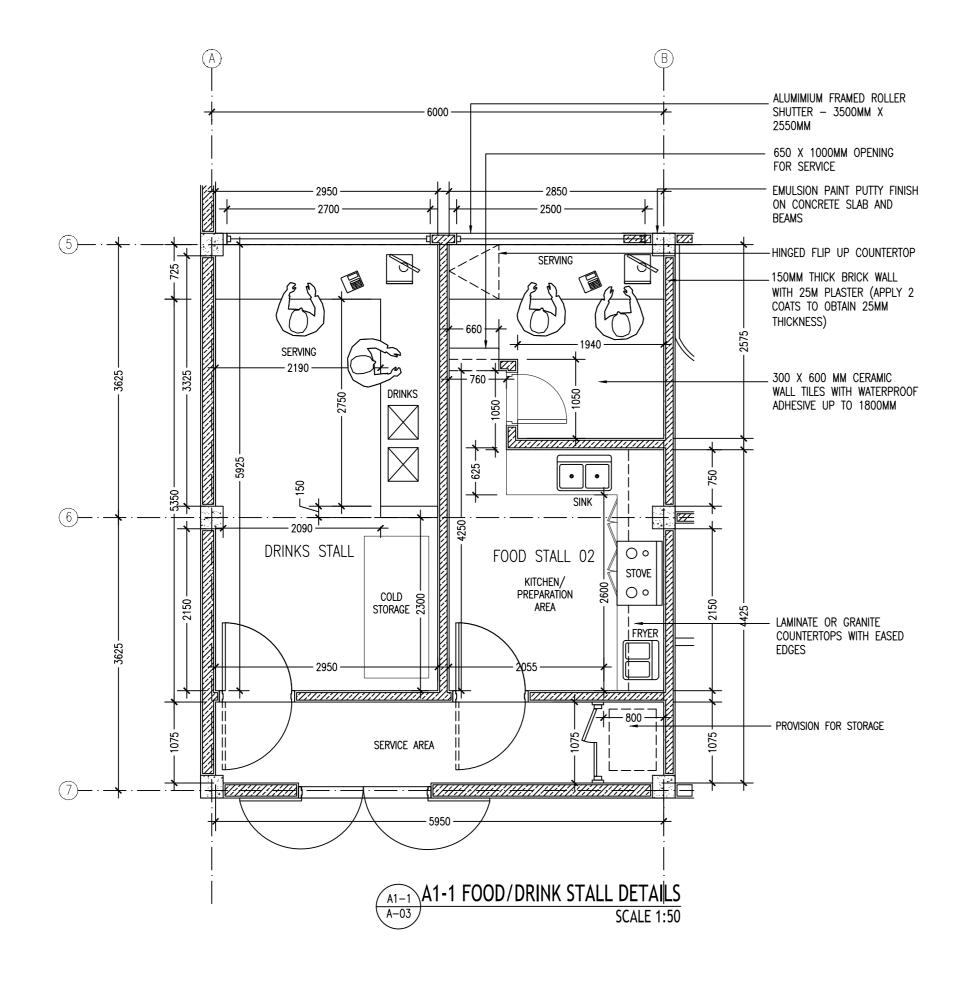



FOOD/DRINK STALL DETAILS
SCALE 1:50

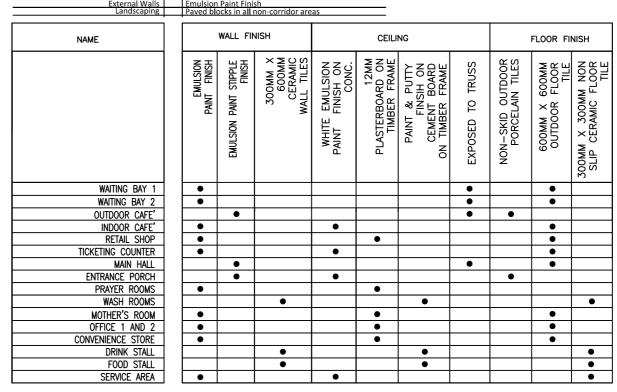



MATERIALS SCHEDULE



REVISION:	PRINCIPAL ARCHITECT: MOHAMED HAMEEN
	ARCHITECT: AHMED AMEEL SHAKEEL
	PRINCIPAL ENGINEER: MOHAMED AHSAN
	ENGINEER: SHAUFA AHMED

PROJECT:	SINGLE STOREY FERRY T	ERMINAL	
LOCATION:	HDH. KULHUDUFUSHI		A_42
DRAWING TITLE:	AS GIVEN		A-13
CLIENT: MINISTRY	OF HOUSING AND INFRAS	STRUCTURE	DWG NO
SCALE: AS GIVEN	DIMENSION: MM	DATE: JAN 2018	PROJECT NO:

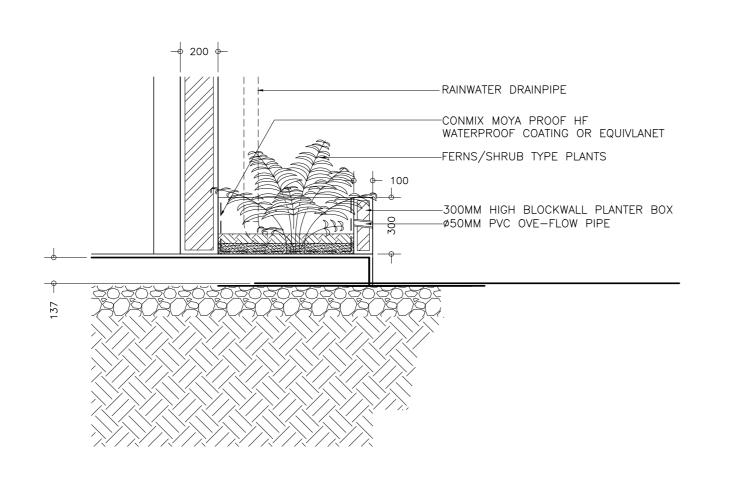


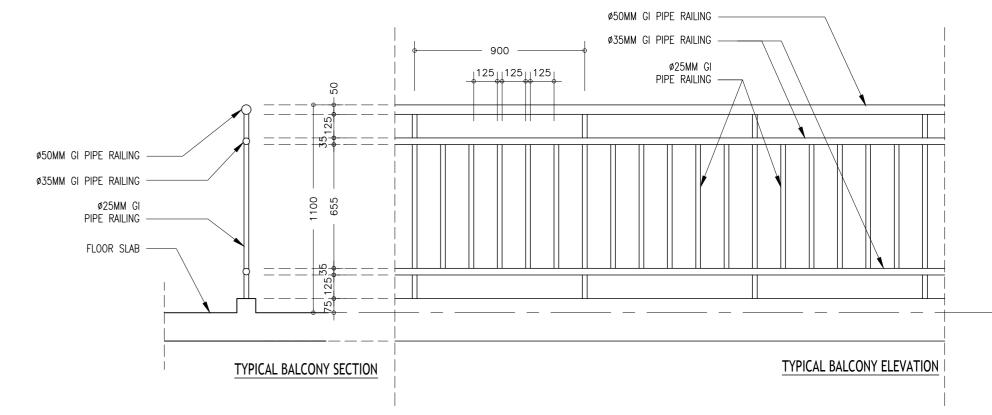



DETAIL F -BALCONY RAILING DETAILS

SCALE 1:20



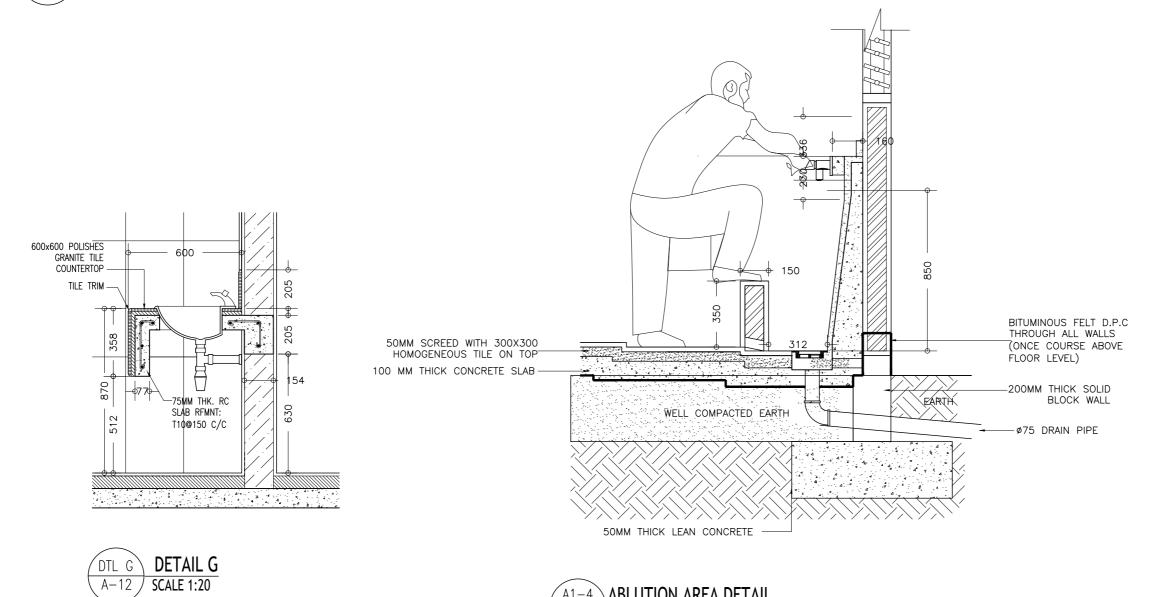

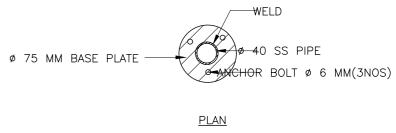

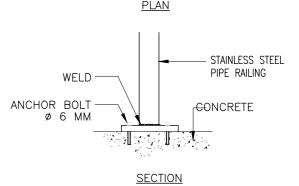

DTL F RAILING DETAIL A - DETAIL F A-03 SCALE 1:20




A1-4 A-03 SCALE 1:20



/ISION:	PRINCIPAL ARCHITECT: MOHAMED HAMEEN
	ARCHITECT: AHMED AMEEL SHAKEEL
	PRINCIPAL ENGINEER: MOHAMED AHSAN
	ENGINEER: SHAUFA AHMED
	DRAWN BY: MALEEHA IBRAHIM

_	PROJECT:	SINGLE STOREY FERRY 1	FERMINAL	
	LOCATION:	HDH. KULHUDUFUSHI		A-14
	DRAWING TITLE:	AS GIVEN		~
	CLIENT: MINISTRY	OF HOUSING AND INFRAS	STRUCTURE	DWG NO
	SCALE: AS GIVEN	DIMENSION: MM	DATE: JAN 2018	PROJECT NO:

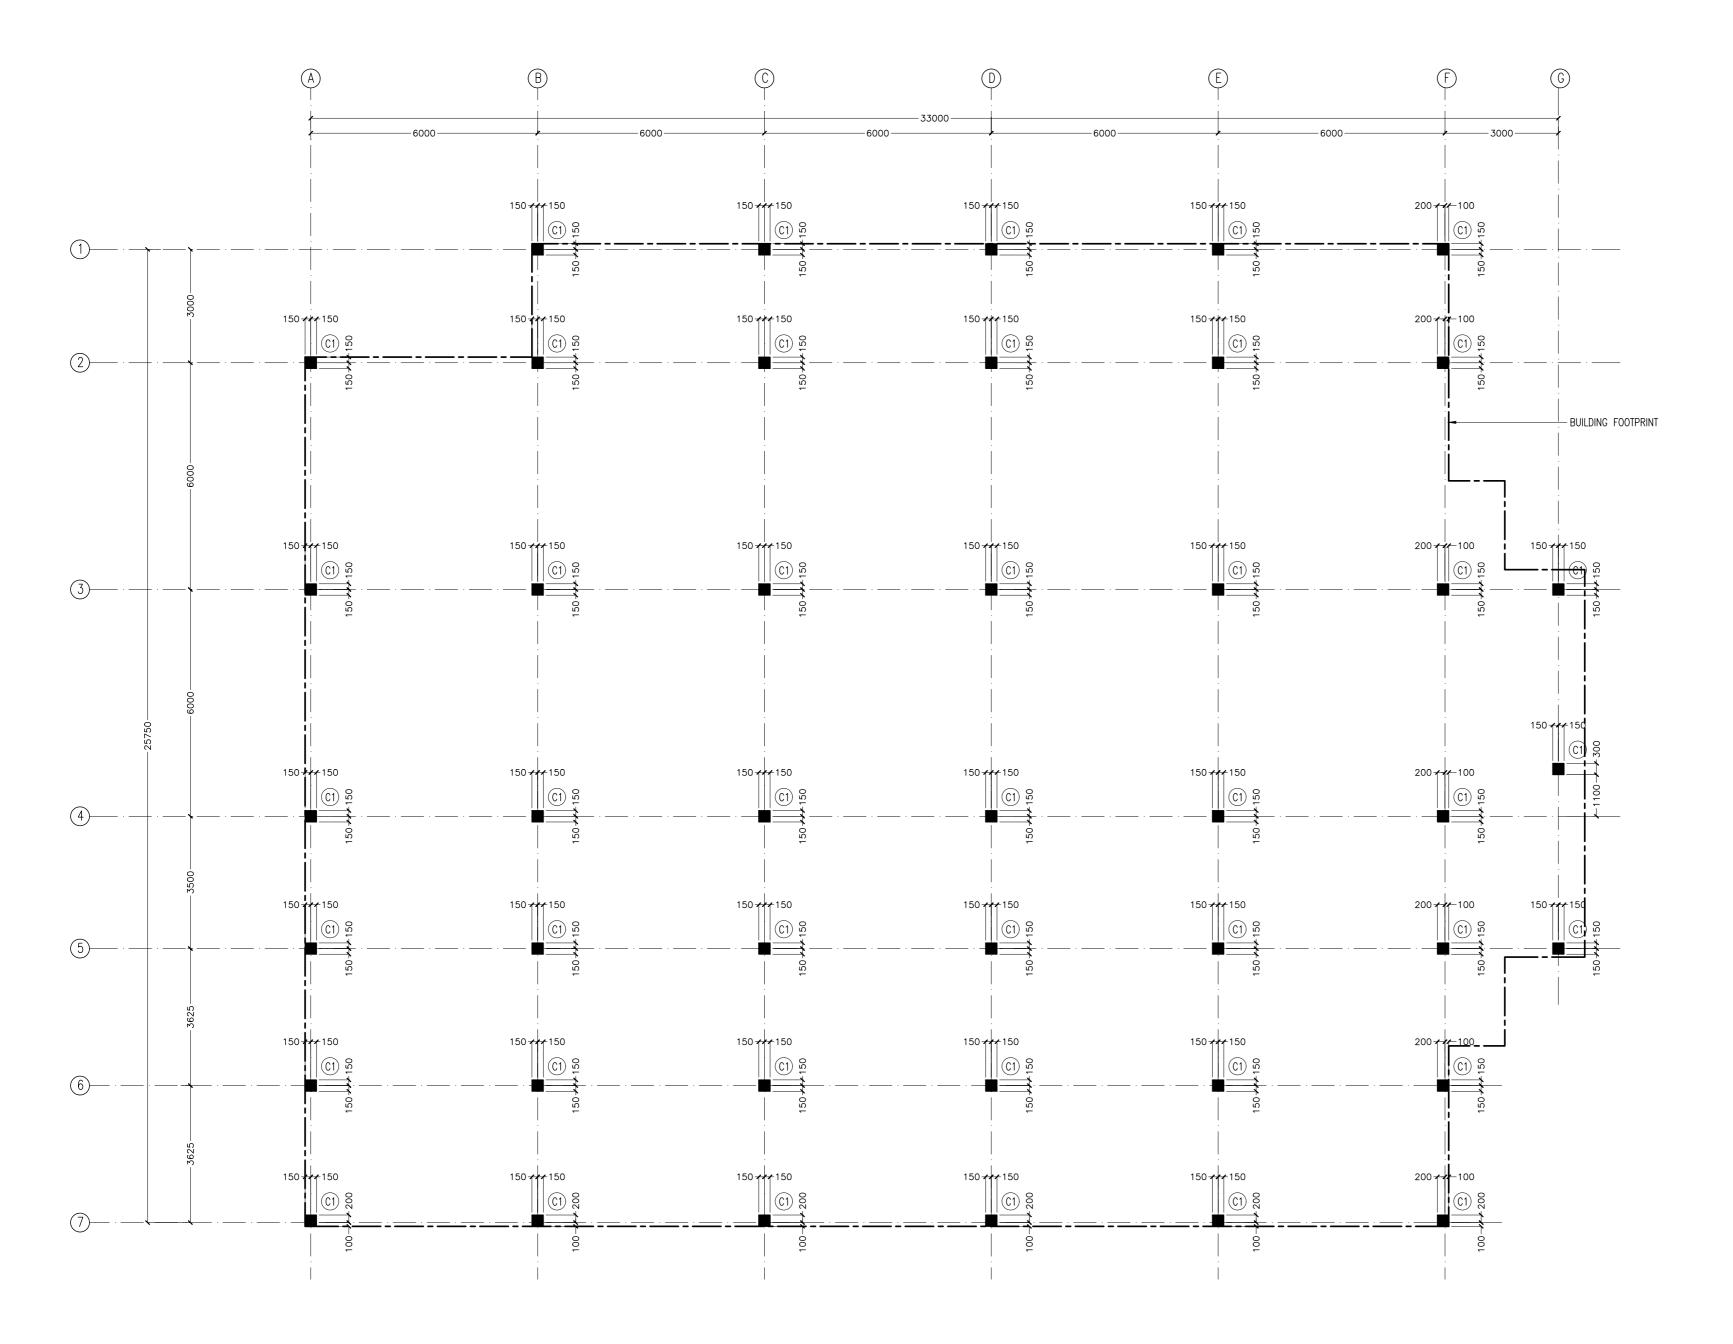



NOTES:


- FOUNDATION DEPTH : 1200MM
- FOUNDATION FOOTING COVER: 50MM
- BELOW GROUND CONCRETE COVER : 50MM - COVER TO COLUMNS : 40MM
- CONCRETE MIX : 1:2:3 UNLESS OTHER STATED
- MINIMUM CONCRETE CUBE STRENGTH 25 N/MM2
- ALL FOUNDATION SHALL BE FOUND ON 50MM THICK LEAN CONCRETE
- APPLY CONMIX MOYA SHIELD RBE ON ALL SUB STRUCTURE CONCRETE AND PLASTERED MASONRY WALLS FOR WATER PROOFING
- ADD CONMIX MEGA ADD WL1 TO ALL BELOW GROUND CONCRETE.

COLUMN SETTING LAYOUT PLAN SCALE: 1:100





	REVISION:	PRINCIPAL ARCHITECT: MOHAMED HAMEEN
ड		ARCHITECT: AHMED AMEEL SHAKEEL
ED		PRINCIPAL ENGINEER: MOHAMED AHSAN
		ENGINEER: SHAUFA AHMED
		DRAWN RY: MAI FEHA IRRAHIM

PROJECT:	SINGLE STOREY FERRY T	TERMINAL	
LOCATION:	HDH. KULHUDUFUSHI		C 04
DRAWING TITLE:	AS GIVEN		3-01
CLIENT: MINISTRY	OF HOUSING AND INFRAS	STRUCTURE	DWG NO
SCALE: AS GIVEN	DIMENSION: MM	DATE: JAN 2018	PROJECT NO:

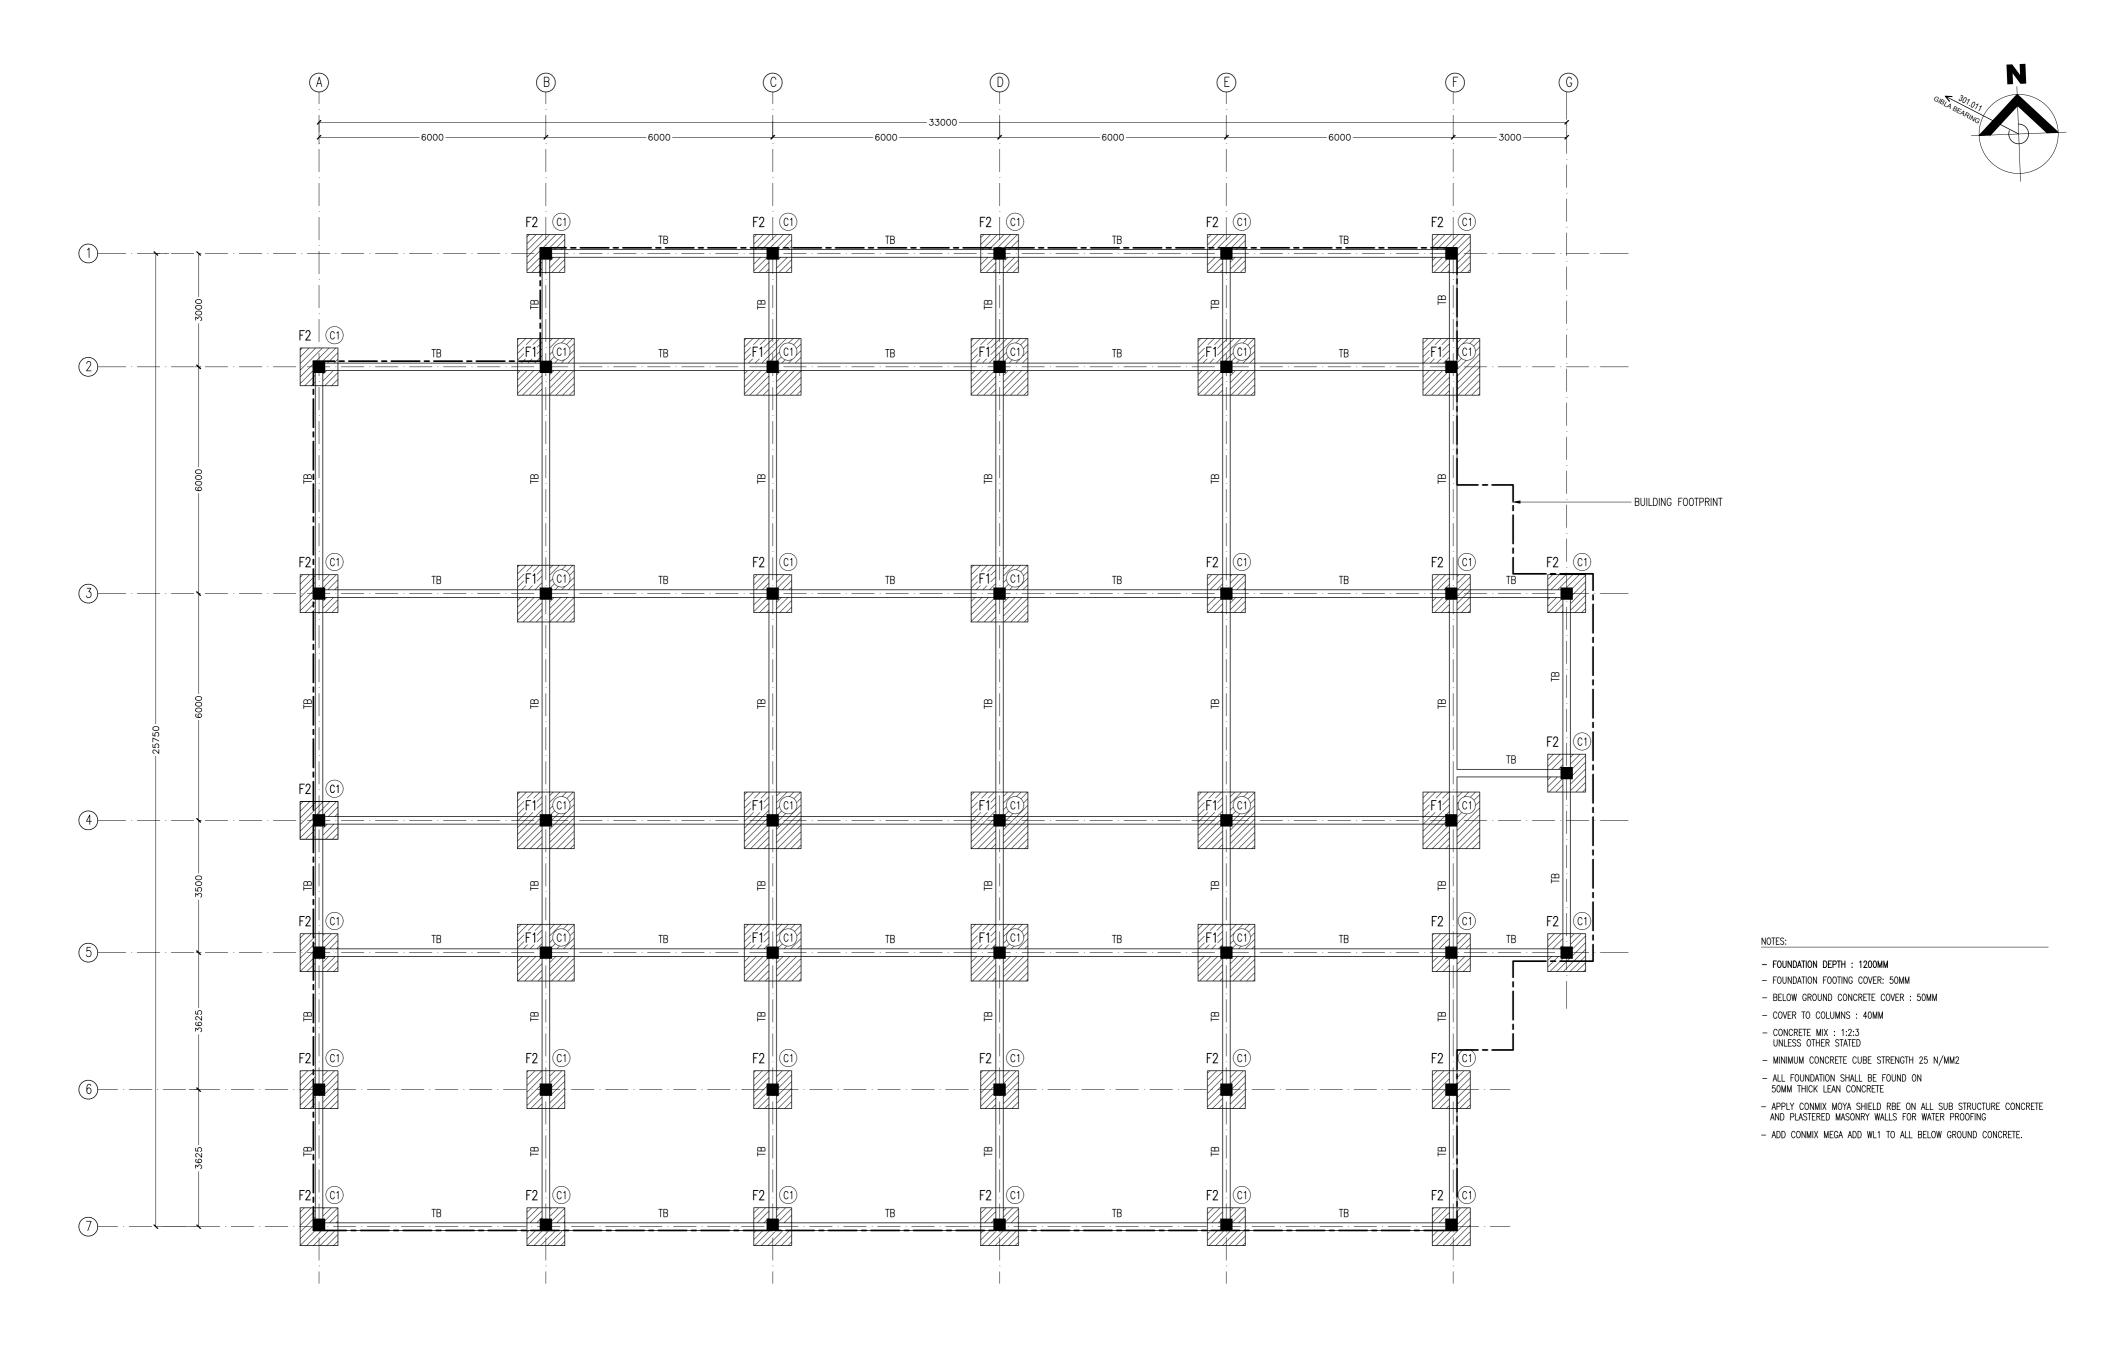

FOUNDATION PLAN SCALE: 1:100

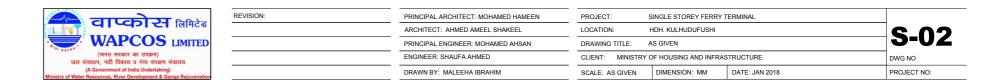

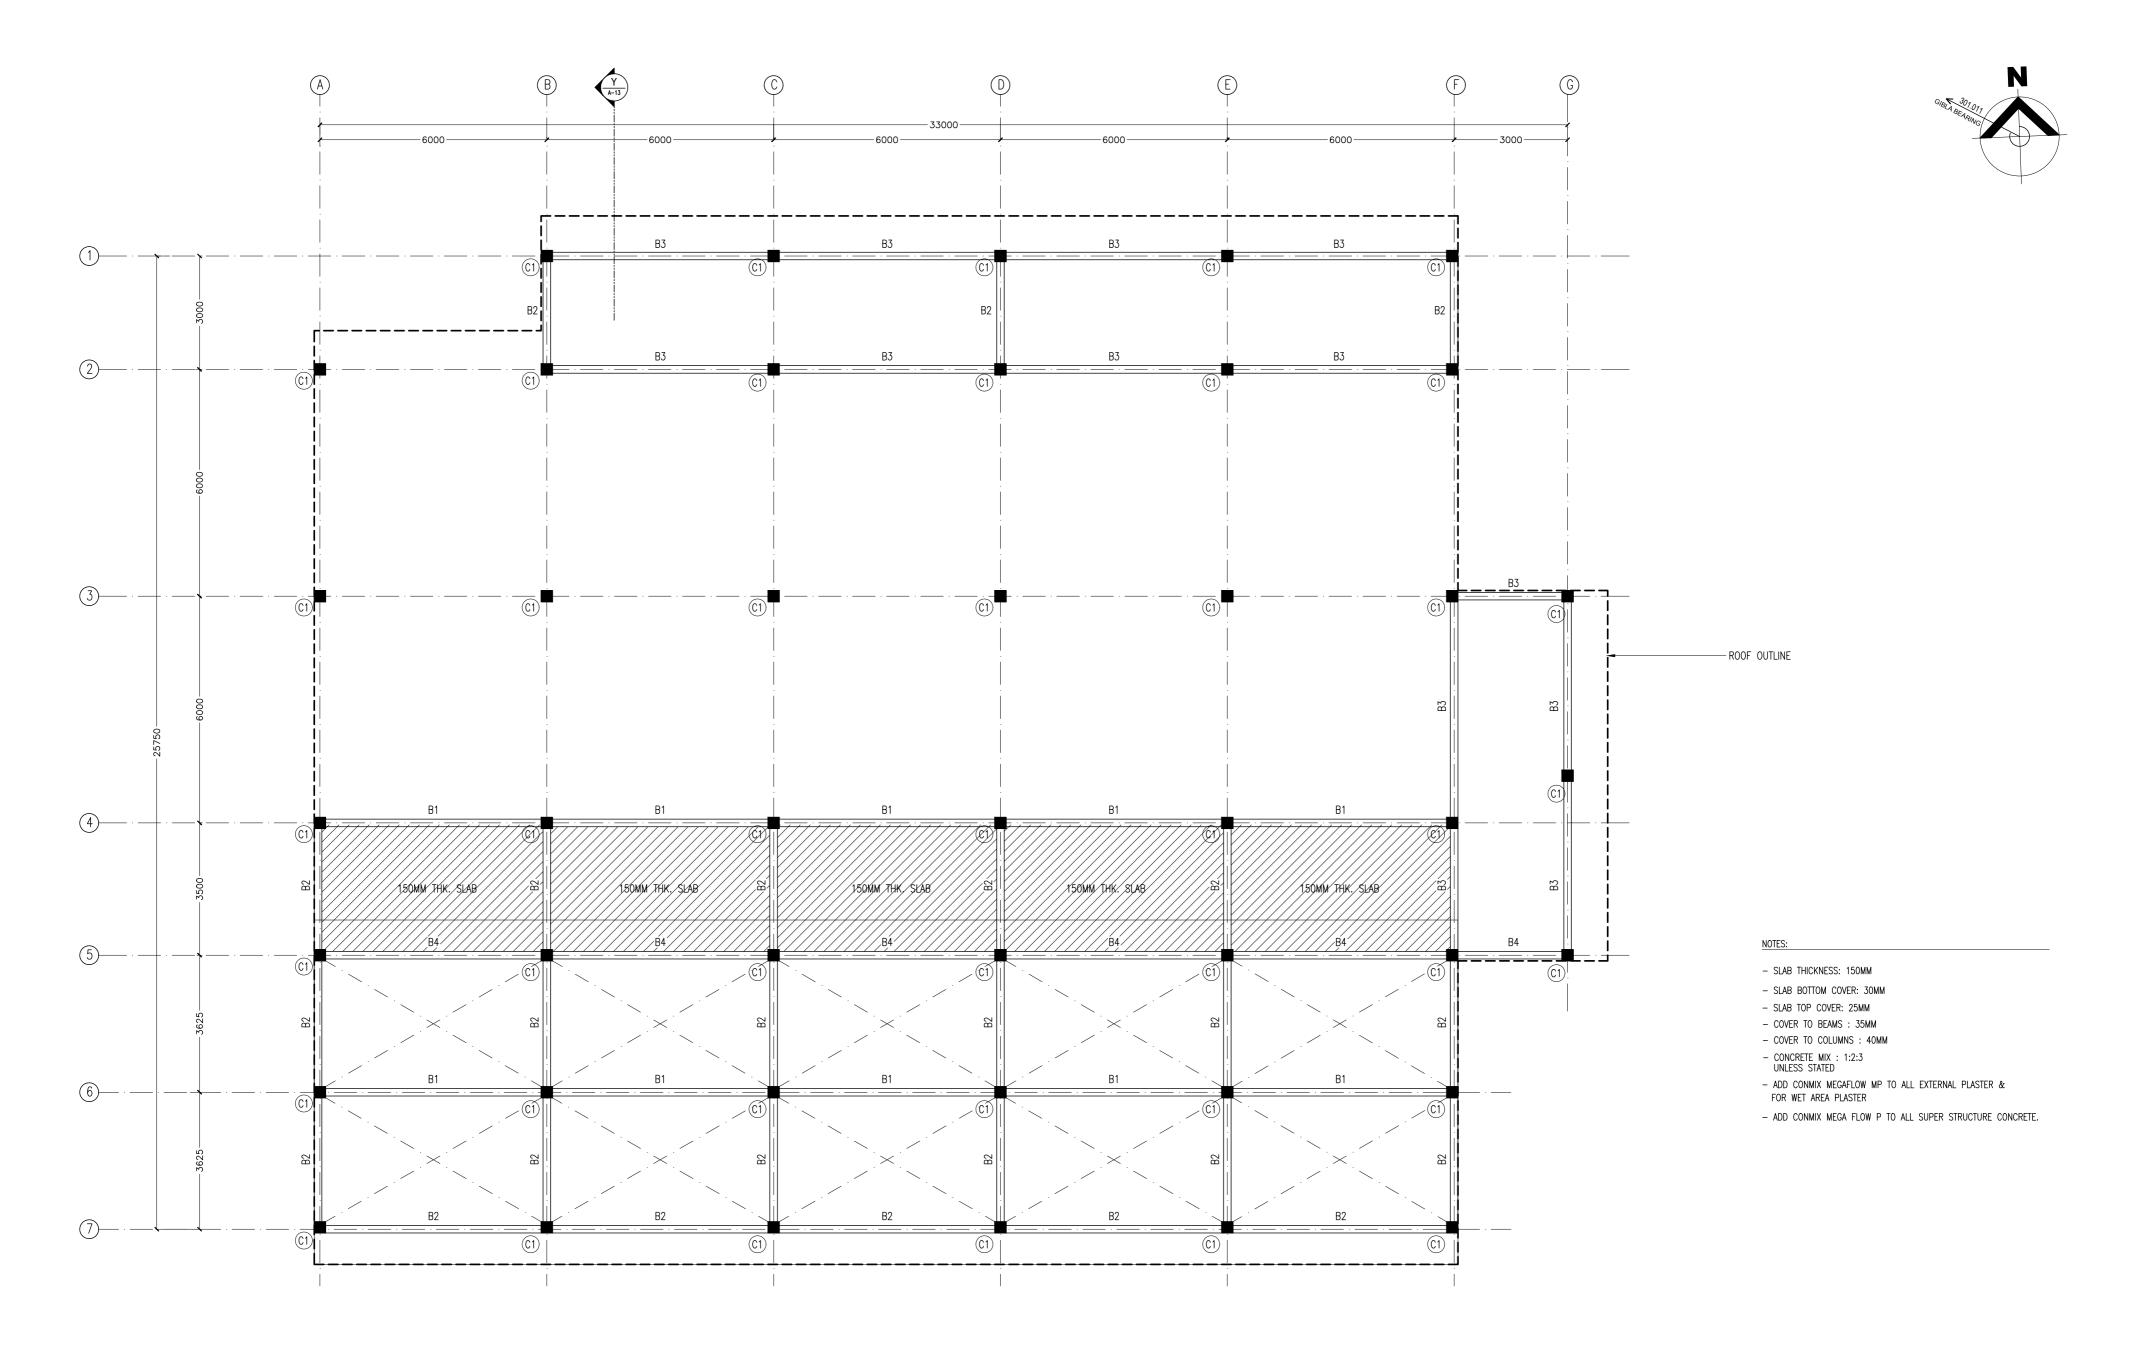

BEAM PLAN AT 3.73M LEVEL SCALE: 1:100



EVISION:	PRINCIPAL ARCHITECT: MOHAMED HAMEEN
	ARCHITECT: AHMED AMEEL SHAKEEL
	PRINCIPAL ENGINEER: MOHAMED AHSAN
	ENGINEER: SHAUFA AHMED
	DRAWN BY: MALEEHA IBRAHIM

PROJECT: SINGLE STOREY FERRY TERMINAL


LOCATION: HDH. KULHUDUFUSHI

DRAWING TITLE: AS GIVEN

CLIENT: MINISTRY OF HOUSING AND INFRASTRUCTURE

SCALE: AS GIVEN DIMENSION: MM DATE: JAN 2018

PROJECT NO:

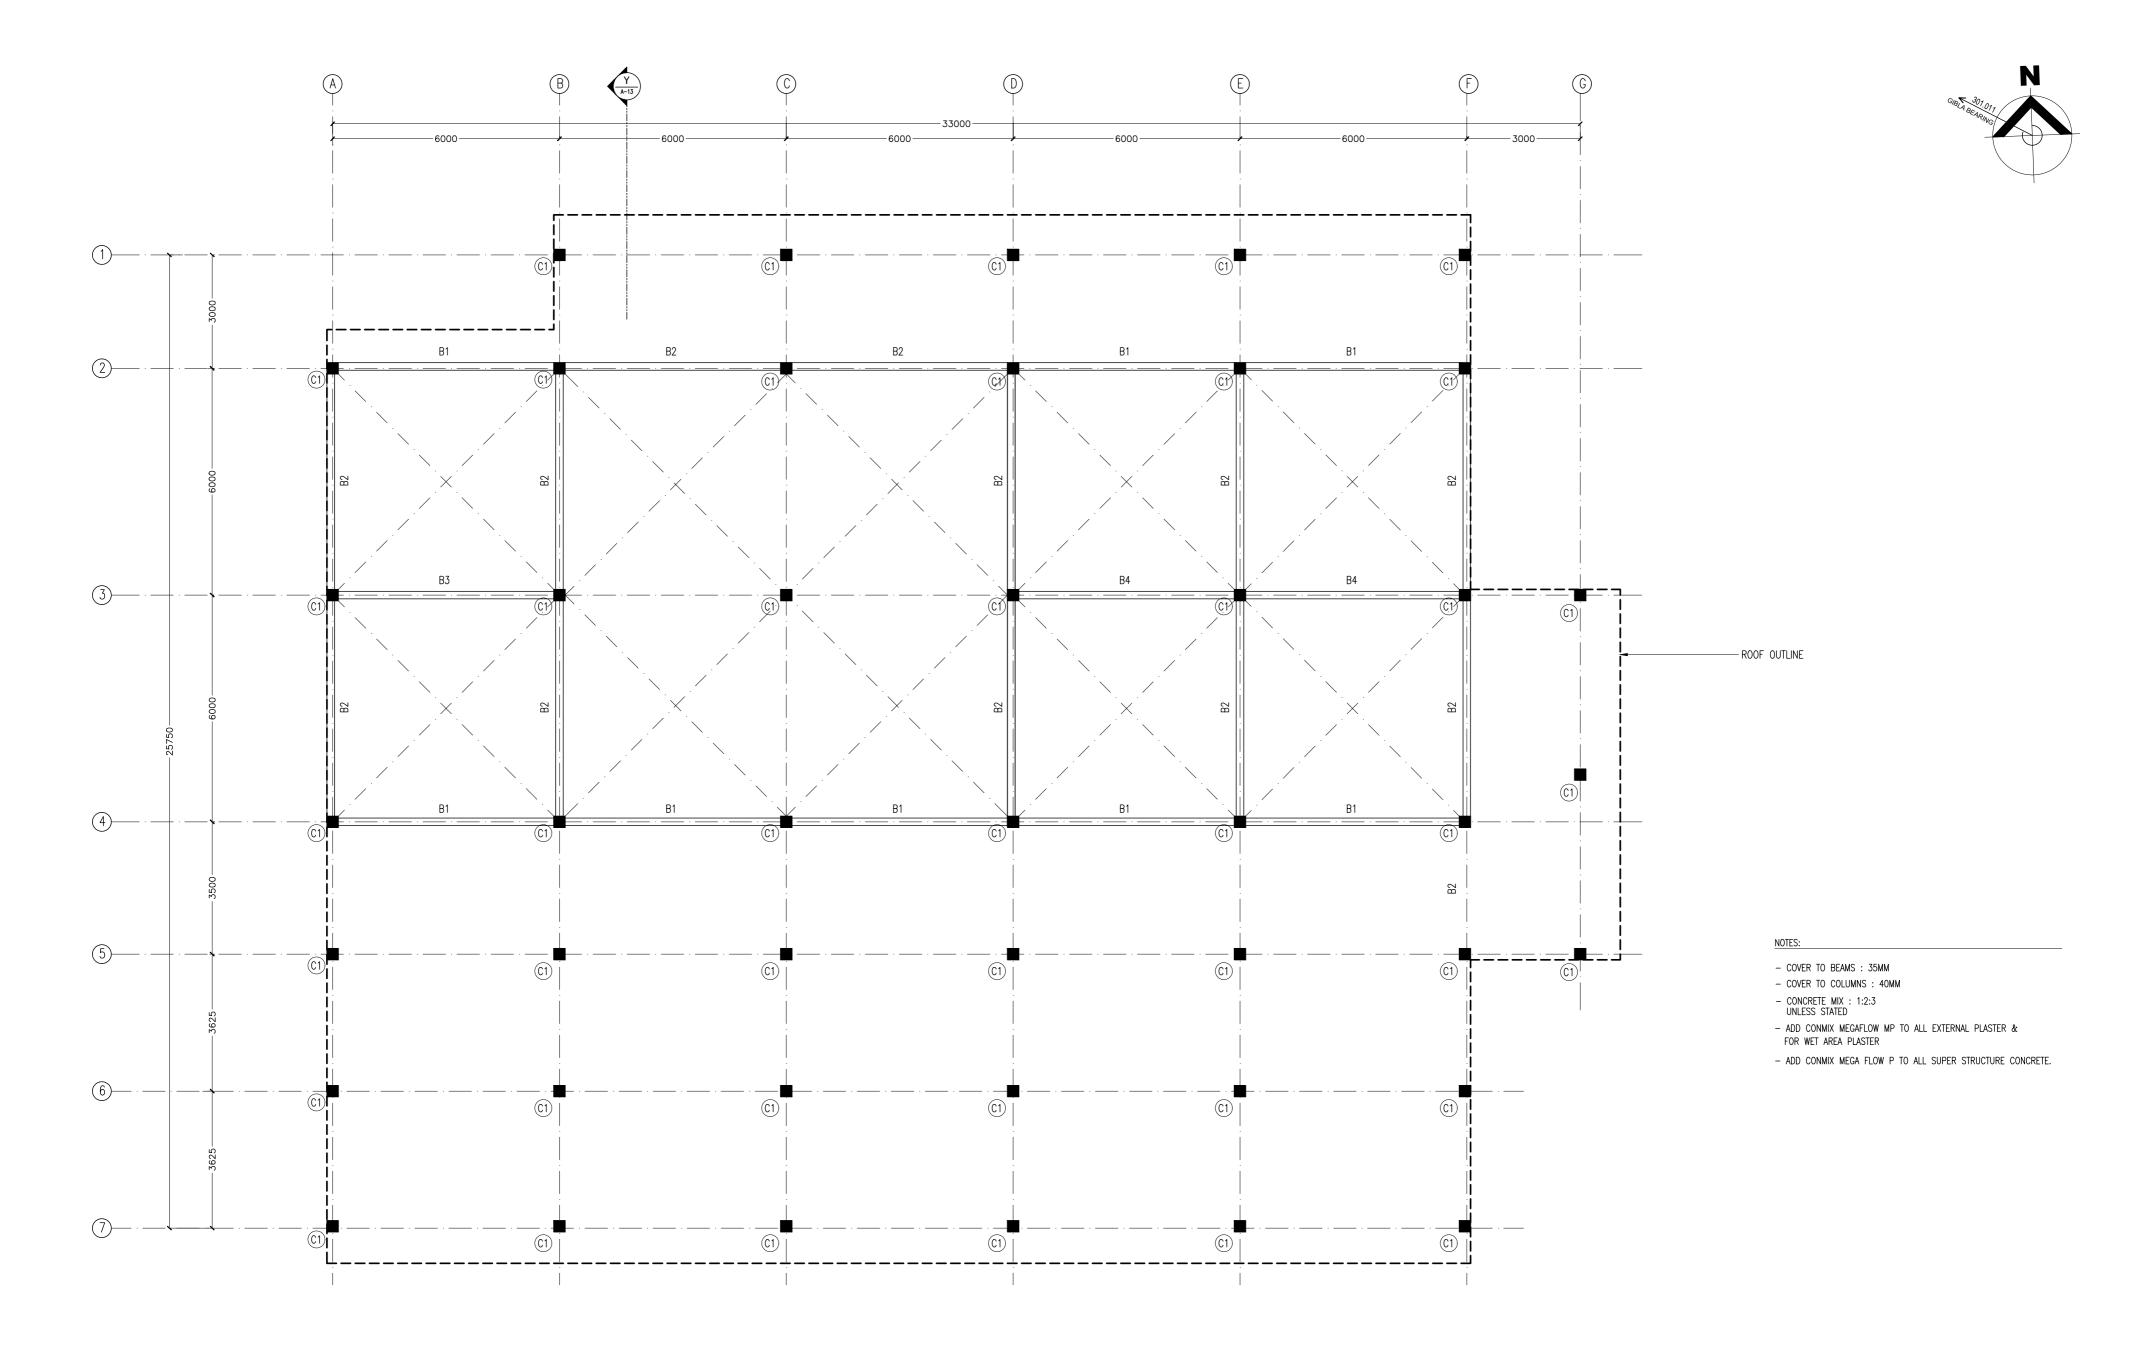


BEAM PLAN AT 4.73M LEVEL SCALE: 1:100



EVISION:	PRINCIPAL ARCHITECT: MOHAMED HAMEEN
	ARCHITECT: AHMED AMEEL SHAKEEL
	PRINCIPAL ENGINEER: MOHAMED AHSAN
	ENGINEER: SHAUFA AHMED
	DDAWN DV: MAI EEHA IDDAHIM

PROJECT: 5	SINGLE STOREY FERRY T	ERMINAL	
LOCATION:	HDH. KULHUDUFUSHI		S 04
DRAWING TITLE:	AS GIVEN		3-04
CLIENT: MINISTRY (OF HOUSING AND INFRAS	TRUCTURE	DWG NO
SCALE: AS GIVEN	DIMENSION: MM	DATE: JAN 2018	PROJECT NO:

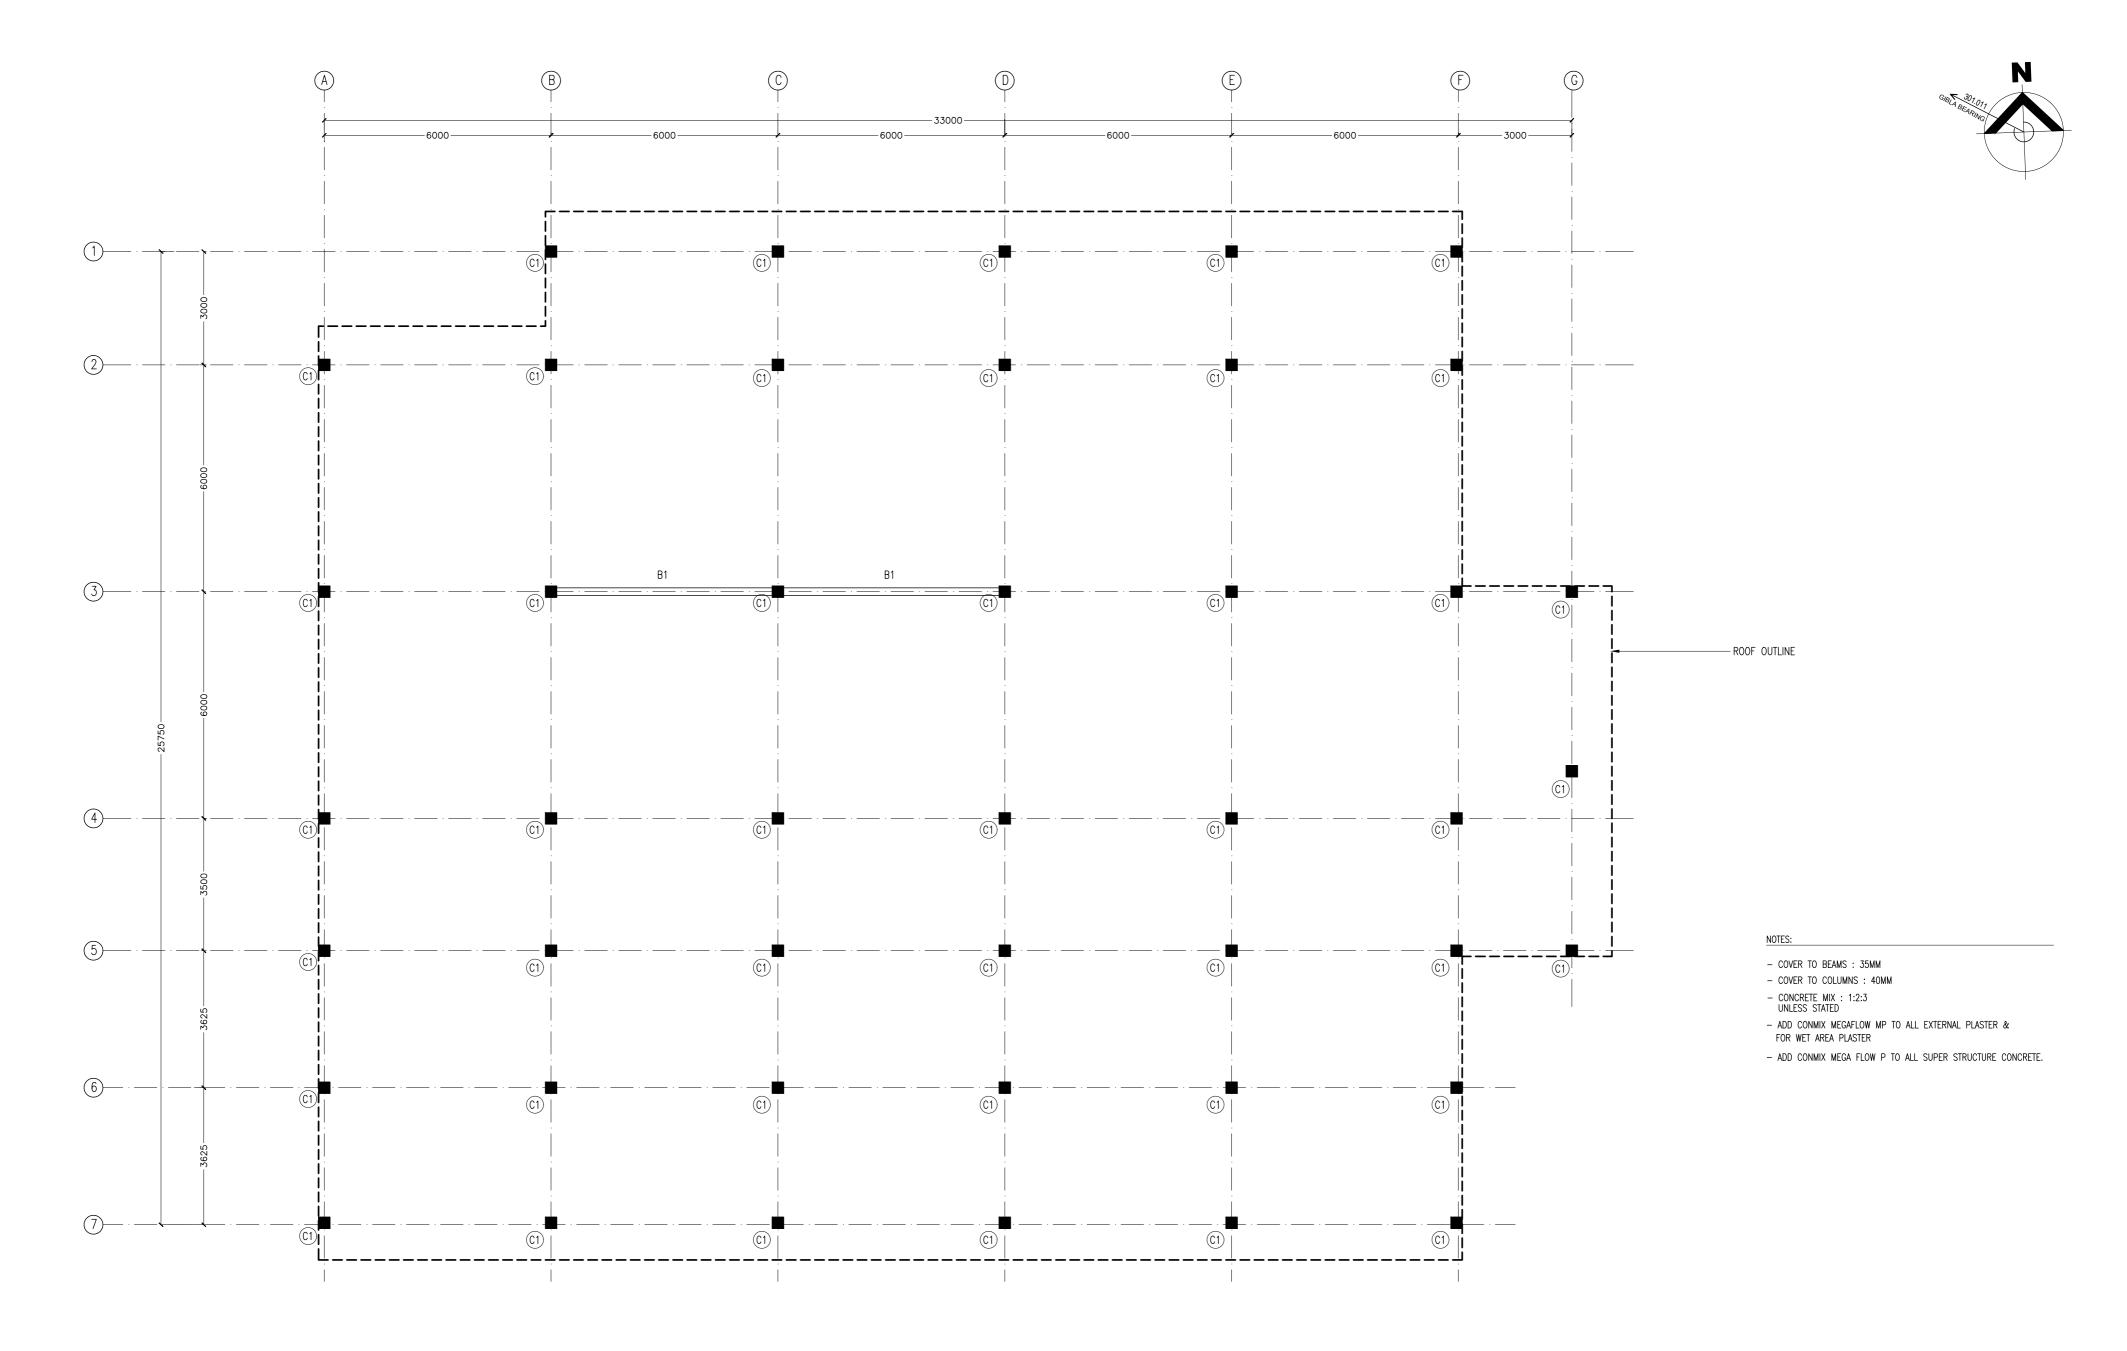


BEAM PLAN AT 7.714M LEVEL SCALE: 1:100



EVISION:	PRINCIPAL ARCHITECT: MOI
	ARCHITECT: AHMED AMEEL
	PRINCIPAL ENGINEER: MOH
	ENGINEER: SHAUFA AHMED
	DRAWN BY: MALEEHA IBRA

 PROJECT:	SINGLE STOREY FERRY T	EPMINAI	
 	HDH. KULHUDUFUSHI	FINAL	e ne
DRAWING TITLE:	AS GIVEN		9- 03
CLIENT: MINISTRY	OF HOUSING AND INFRAS	TRUCTURE	DWG NO
SCALE: AS GIVEN	DIMENSION: MM	DATE: JAN 2018	PROJECT NO:

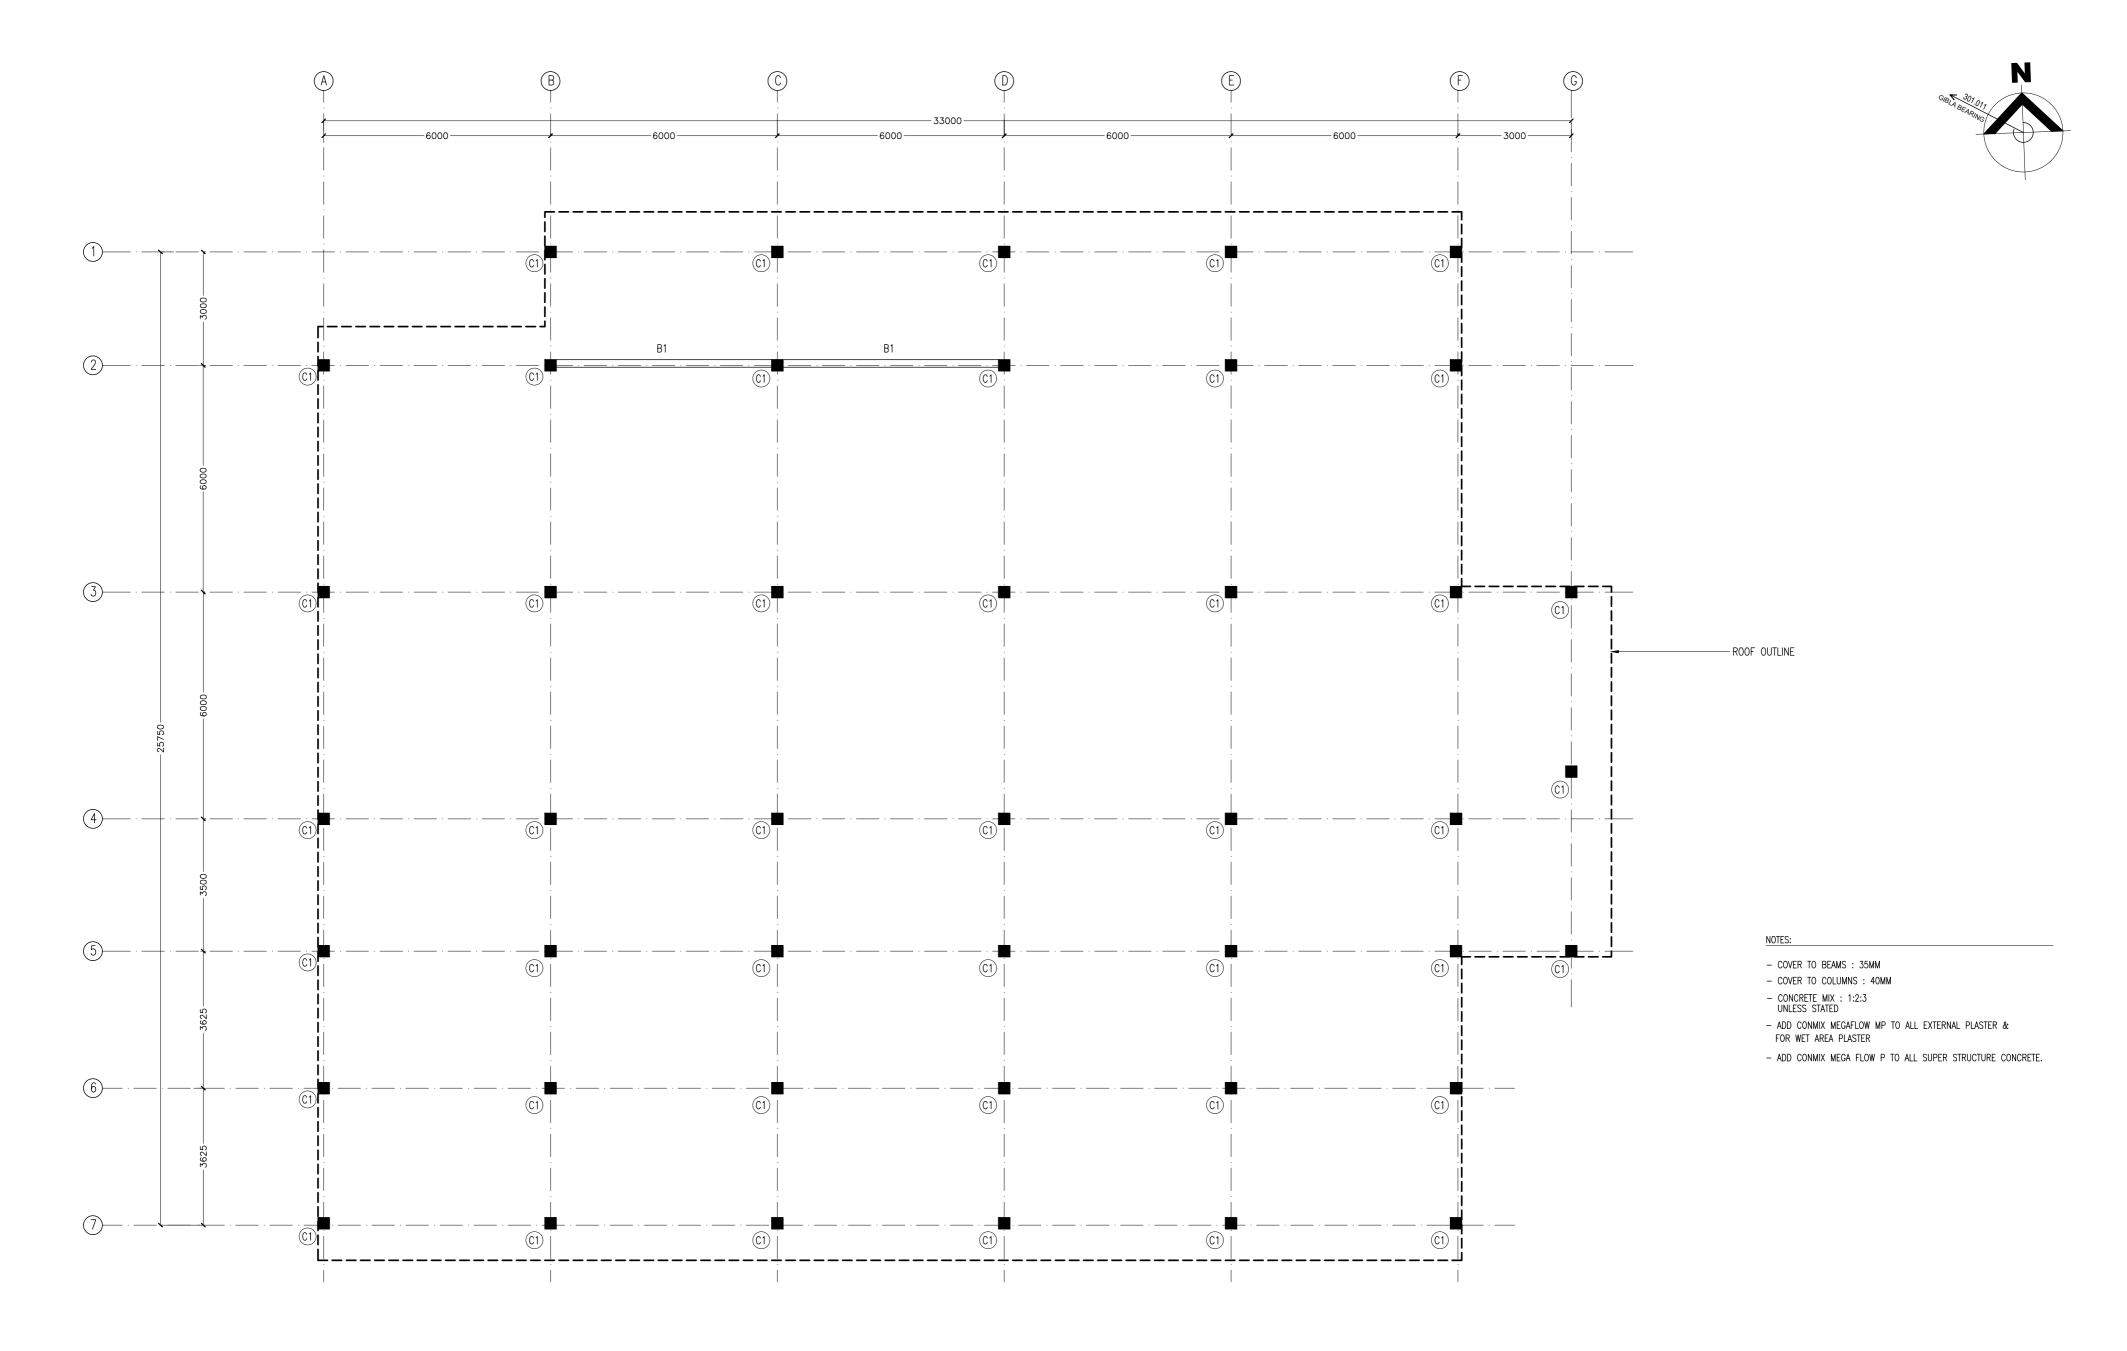


BEAM PLAN AT 7.766M LEVEL SCALE: 1:100

	वाप्को	रन लिमिटेड
WINI RATHA.		OS LIMITED
जल	(भारत सरकार का उ संसाधन, नदी विकास व गंग	
oici	(A Government of India U	
Ministry of Wat	er Resources, River Develop	

VISION:	PRINCIPAL ARCHITECT: MOHAME
	ARCHITECT: AHMED AMEEL SHA
	PRINCIPAL ENGINEER: MOHAMEI
	ENGINEER: SHAUFA AHMED
	DDAWN DV: MAI EEUA IDDAUIM

PROJECT:	SINGLE STOREY FERRY T	ERMINAL	
LOCATION:	HDH. KULHUDUFUSHI		90.9
DRAWING TITLE:	AS GIVEN		3-00
CLIENT: MINISTRY	OF HOUSING AND INFRAS	TRUCTURE	DWG NO
SCALE: AS GIVEN	DIMENSION: MM	DATE: JAN 2018	PROJECT NO:

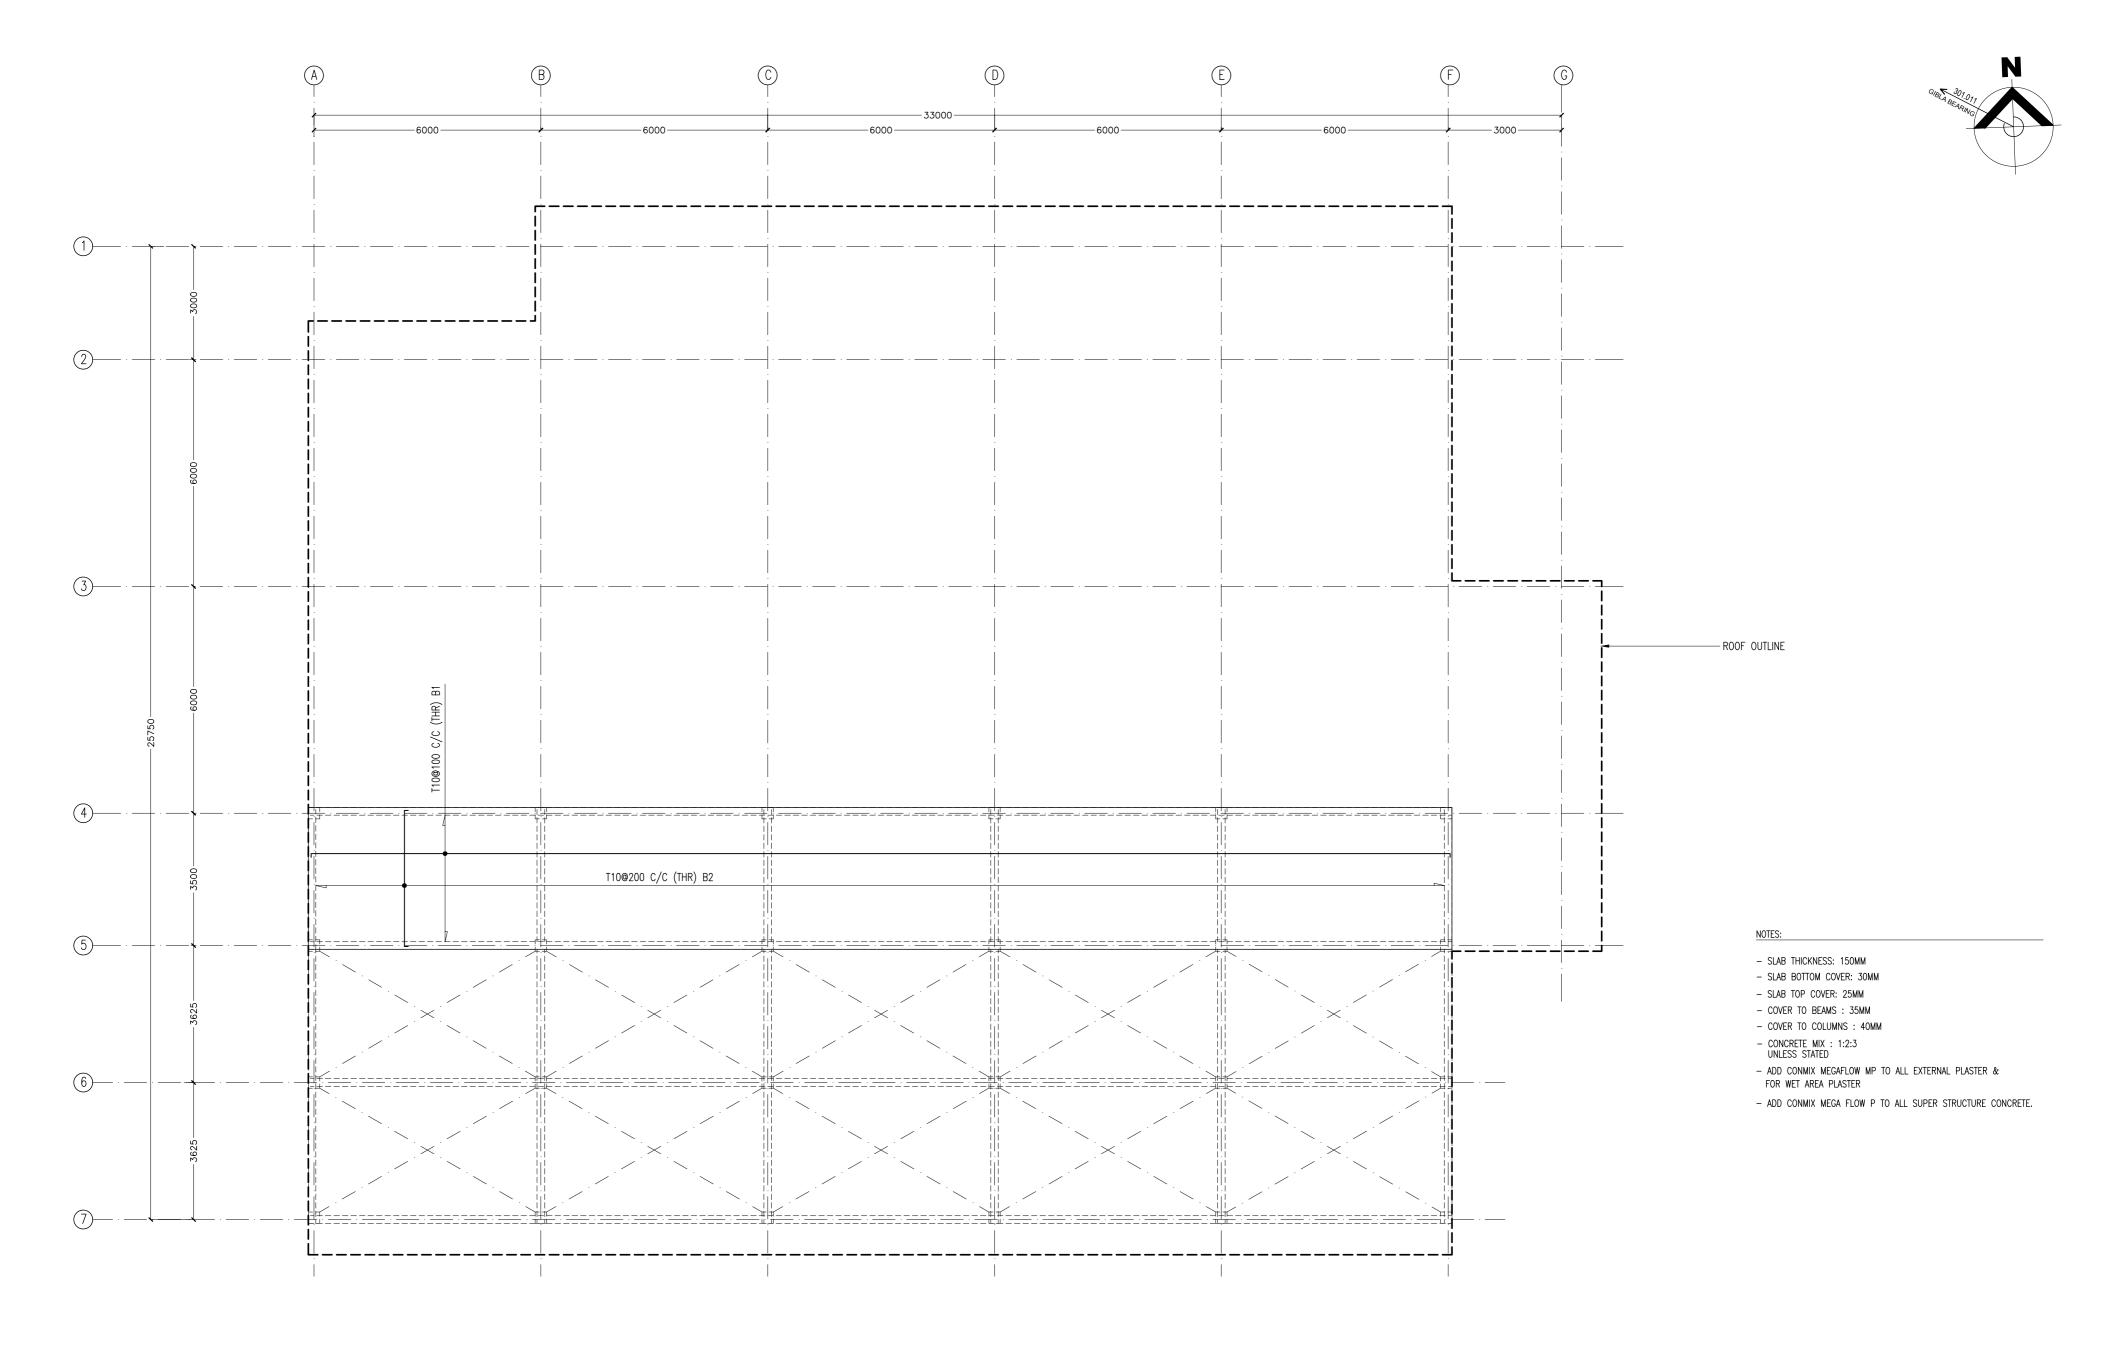


CONCRETE GUTTER-SLAB REINFORCEMENT PLAN AT 3.73M LEVEL SCALE: 1:100



REVISION:	PRINCIPAL ARCHITECT: MOHAMED HAMEEN
	ARCHITECT: AHMED AMEEL SHAKEEL
	PRINCIPAL ENGINEER: MOHAMED AHSAN
	ENGINEER: SHAUFA AHMED
	DRAWN BY: MALEEHA IBRAHIM

PROJECT:	SINGLE STOREY FERRY T	ERMINAL	
LOCATION:	HDH. KULHUDUFUSHI		9 0
DRAWING TITLE:	AS GIVEN		3- U
 CLIENT: MINISTRY	OF HOUSING AND INFRAS	TRUCTURE	DWG NO
SCALE: AS GIVEN	DIMENSION: MM	DATE: JAN 2018	PROJECT NO:

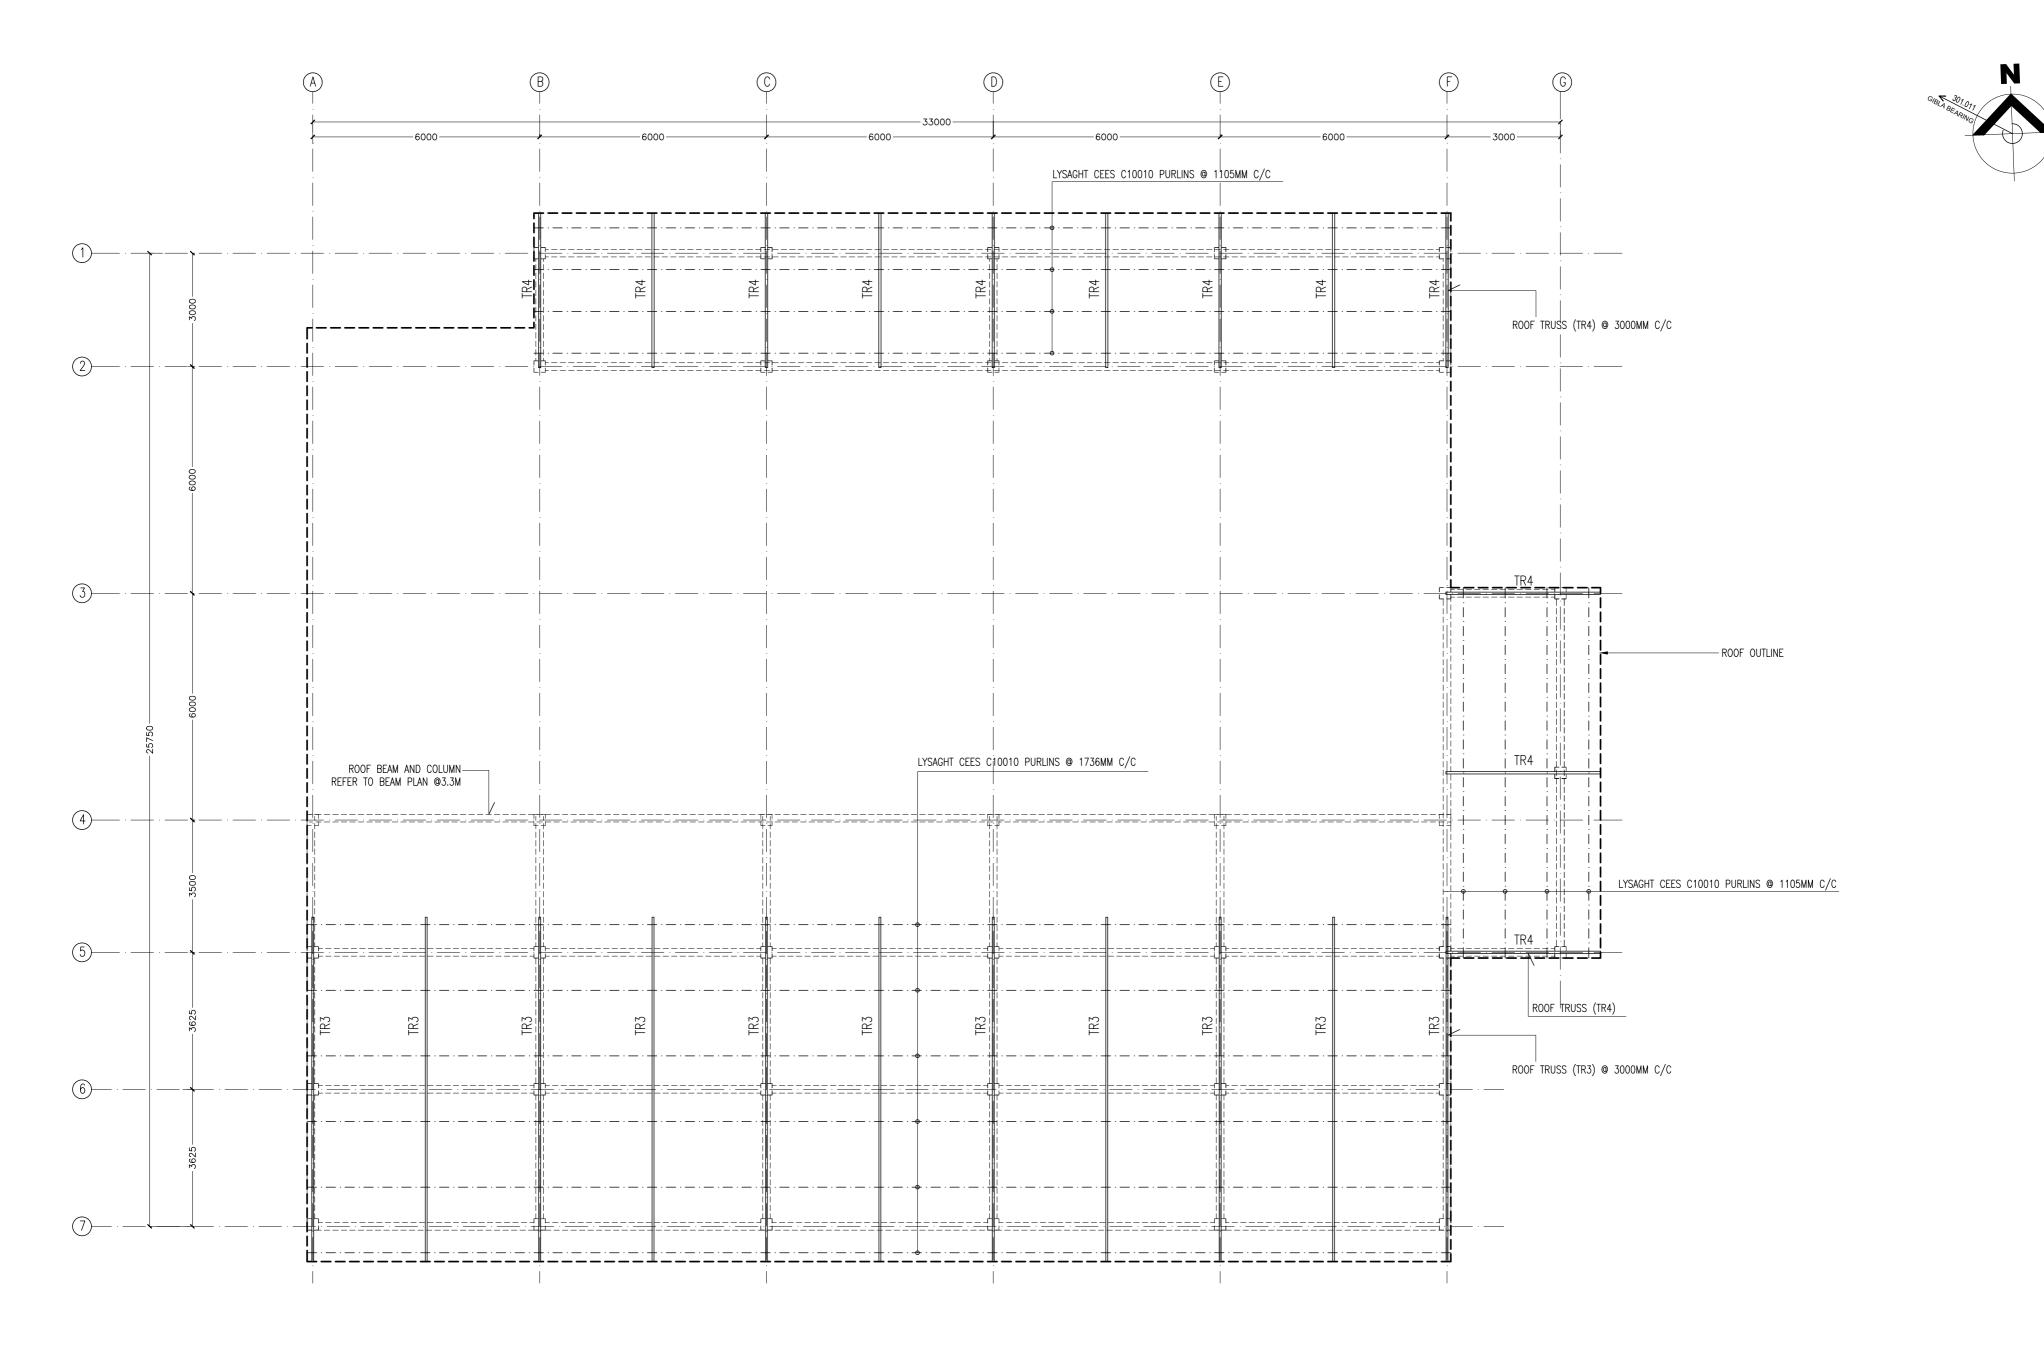


ROOF STRUCTURE PLAN AT 3.73M LEVEL SCALE: 1:100



ISION:	PRINCIPAL ARCHITECT: N
	ARCHITECT: AHMED AME
	PRINCIPAL ENGINEER: MO
	ENGINEER: SHAUFA AHM
	DRAWN BY: MALEEHA IBI

DJECT:	SINGLE STOREY FERRY T	ERMINAL	
CATION:	HDH. KULHUDUFUSHI		S-08
AWING TITLE:	AS GIVEN		3-00
ENT: MINISTRY	OF HOUSING AND INFRAS	STRUCTURE	DWG NO
ALE: AS GIVEN	DIMENSION: MM	DATE: JAN 2018	PROJECT NO:

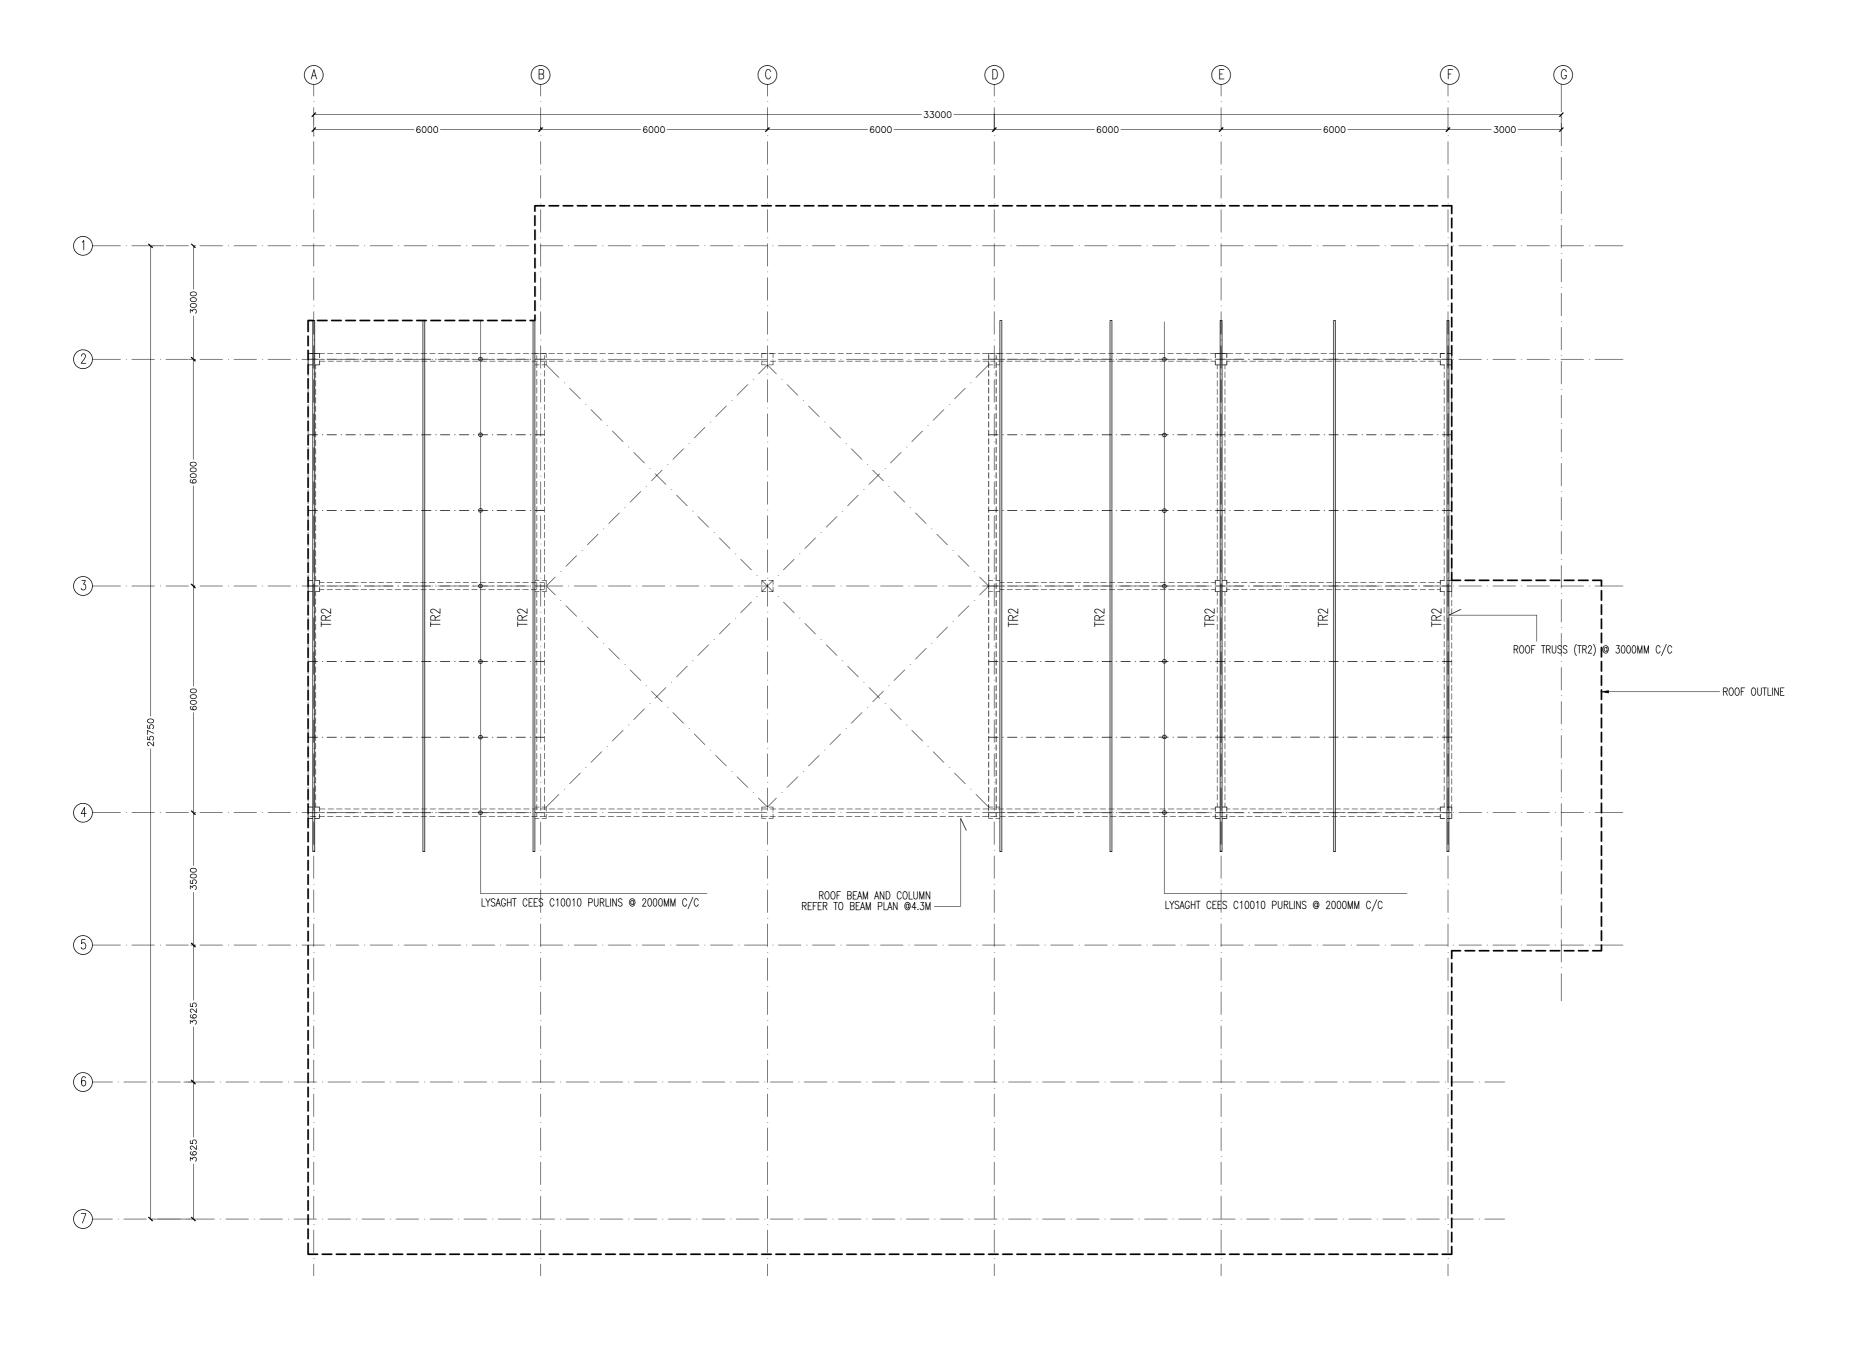






REVISION:	PRINCIPAL ARCHITECT: MOHAMED HAMEEN
	ARCHITECT: AHMED AMEEL SHAKEEL
	PRINCIPAL ENGINEER: MOHAMED AHSAN
	ENGINEER: SHAUFA AHMED
	DRAWN BY: MALEEHA IBRAHIM

PROJECT:	SINGLE STOREY FERRY	TERMINAL	
LOCATION:	HDH. KULHUDUFUSHI		9 00
DRAWING TITLE:	AS GIVEN		3- 03
CLIENT: MINISTRY	OF HOUSING AND INFRAS	STRUCTURE	DWG NO
SCALE: AS GIVEN	DIMENSION: MM	DATE: JAN 2018	PROJECT NO:

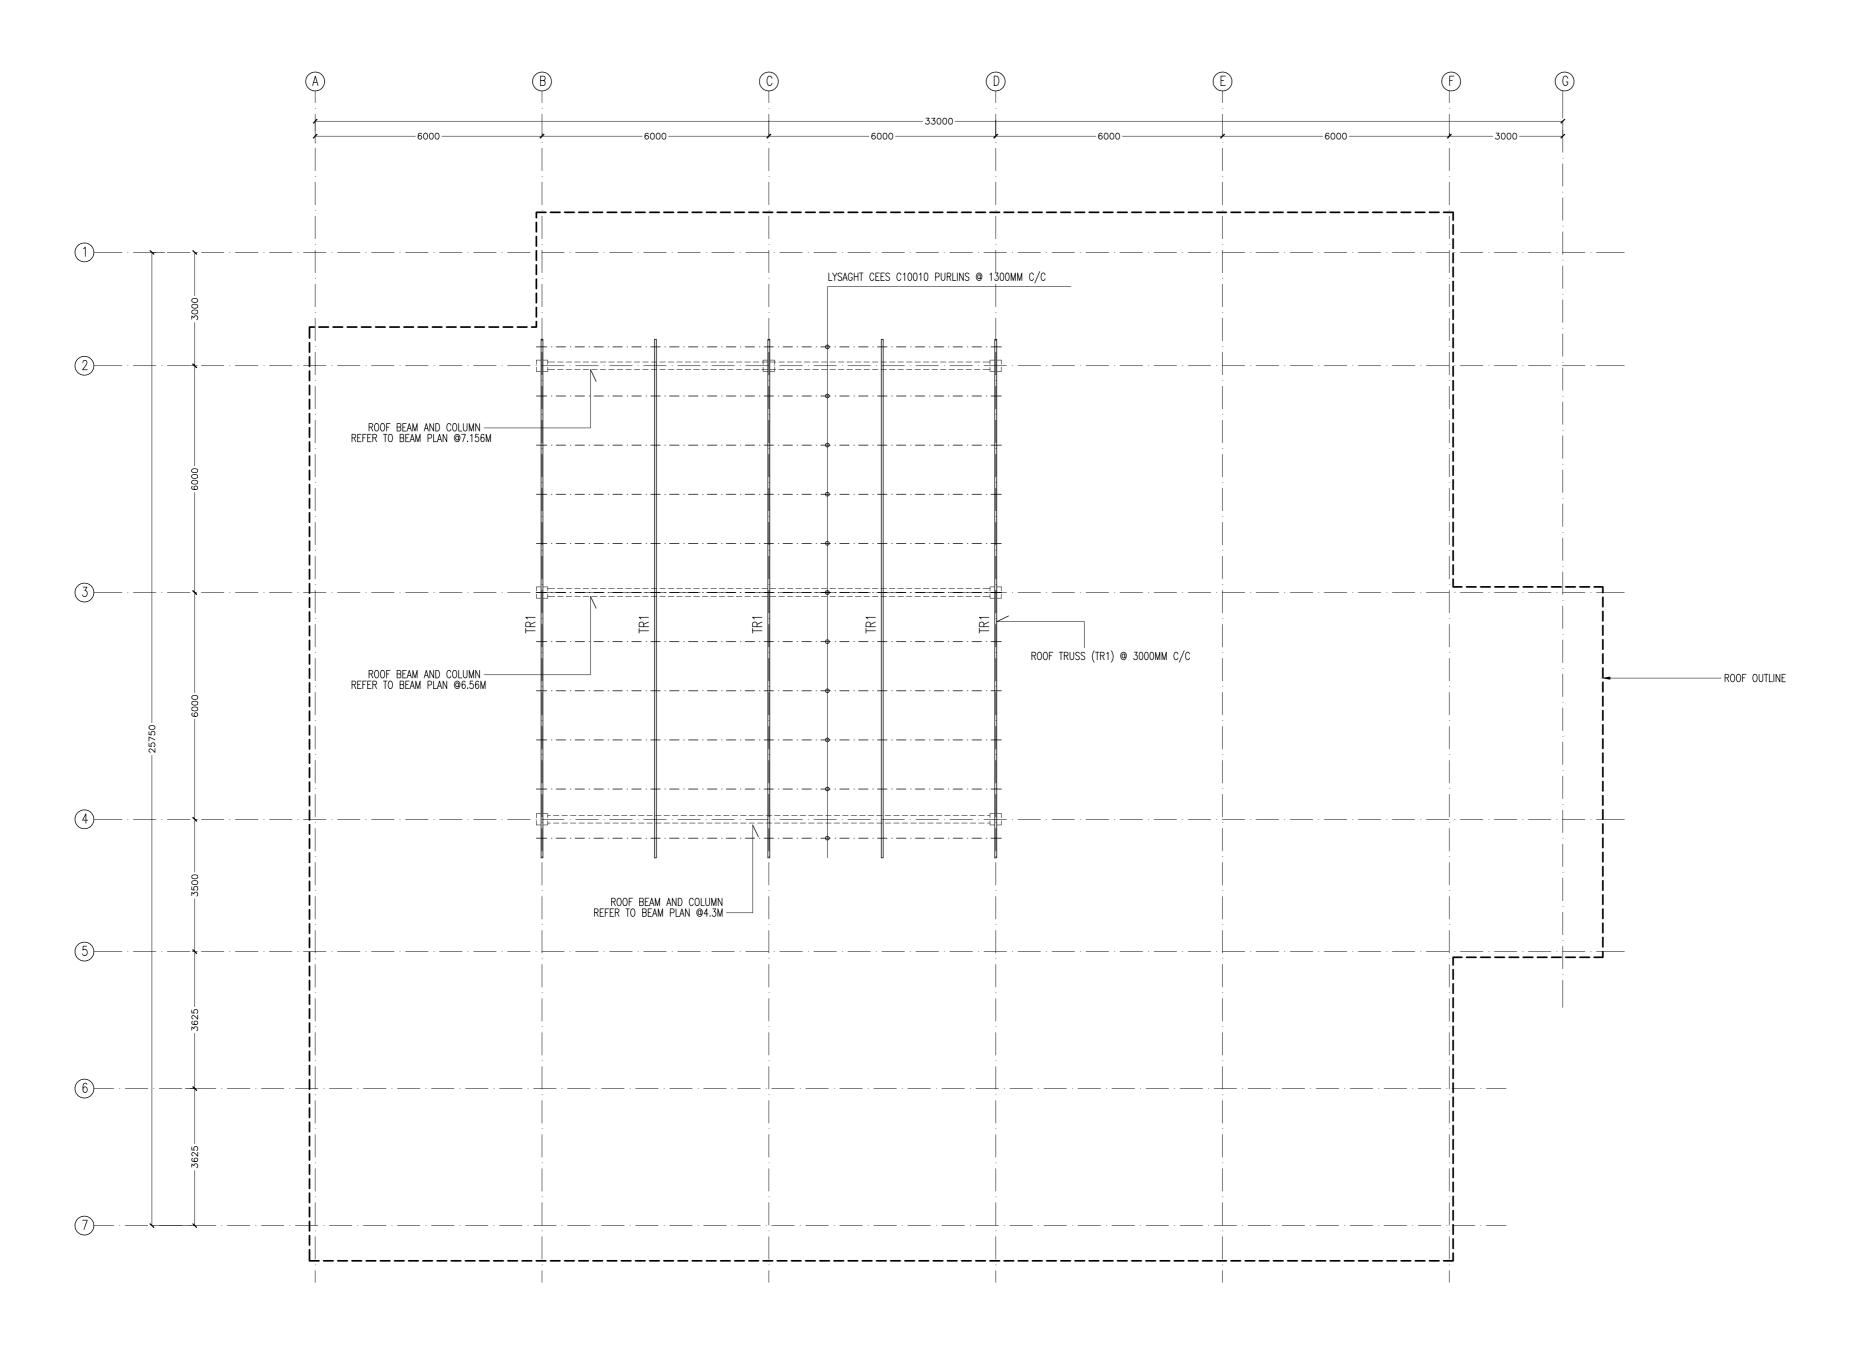



ROOF STRUCTURE PLAN AT 7.766M LEVEL SCALE: 1:100




	REVISION:
वाप्कोस लिमिटेड	
VAPCOS LIMITED	
(भारत सरकार का उपक्रम) न, नदी विकास व गंगा संरक्षण मंत्रालय	
iovernment of India Undertaking) ources, River Development & Ganga Rejuvenation	

PRINCIPAL ARCHITECT: MOHAMED HAMEEN	PROJECT:
ARCHITECT: AHMED AMEEL SHAKEEL	LOCATION:
PRINCIPAL ENGINEER: MOHAMED AHSAN	DRAWING TITLE:
ENGINEER: SHAUFA AHMED	CLIENT: MINISTRY
DRAWN BY: MALEEHA IBRAHIM	SCALE: AS GIVEN

ECT: S	SINGLE STOREY FERRY T	ERMINAL	
TION: I	HDH. KULHUDUFUSHI		9 40
VING TITLE:	AS GIVEN		3-10
NT: MINISTRY	OF HOUSING AND INFRAS	TRUCTURE	DWG NO
E: AS GIVEN	DIMENSION: MM	DATE: JAN 2018	PROJECT NO:



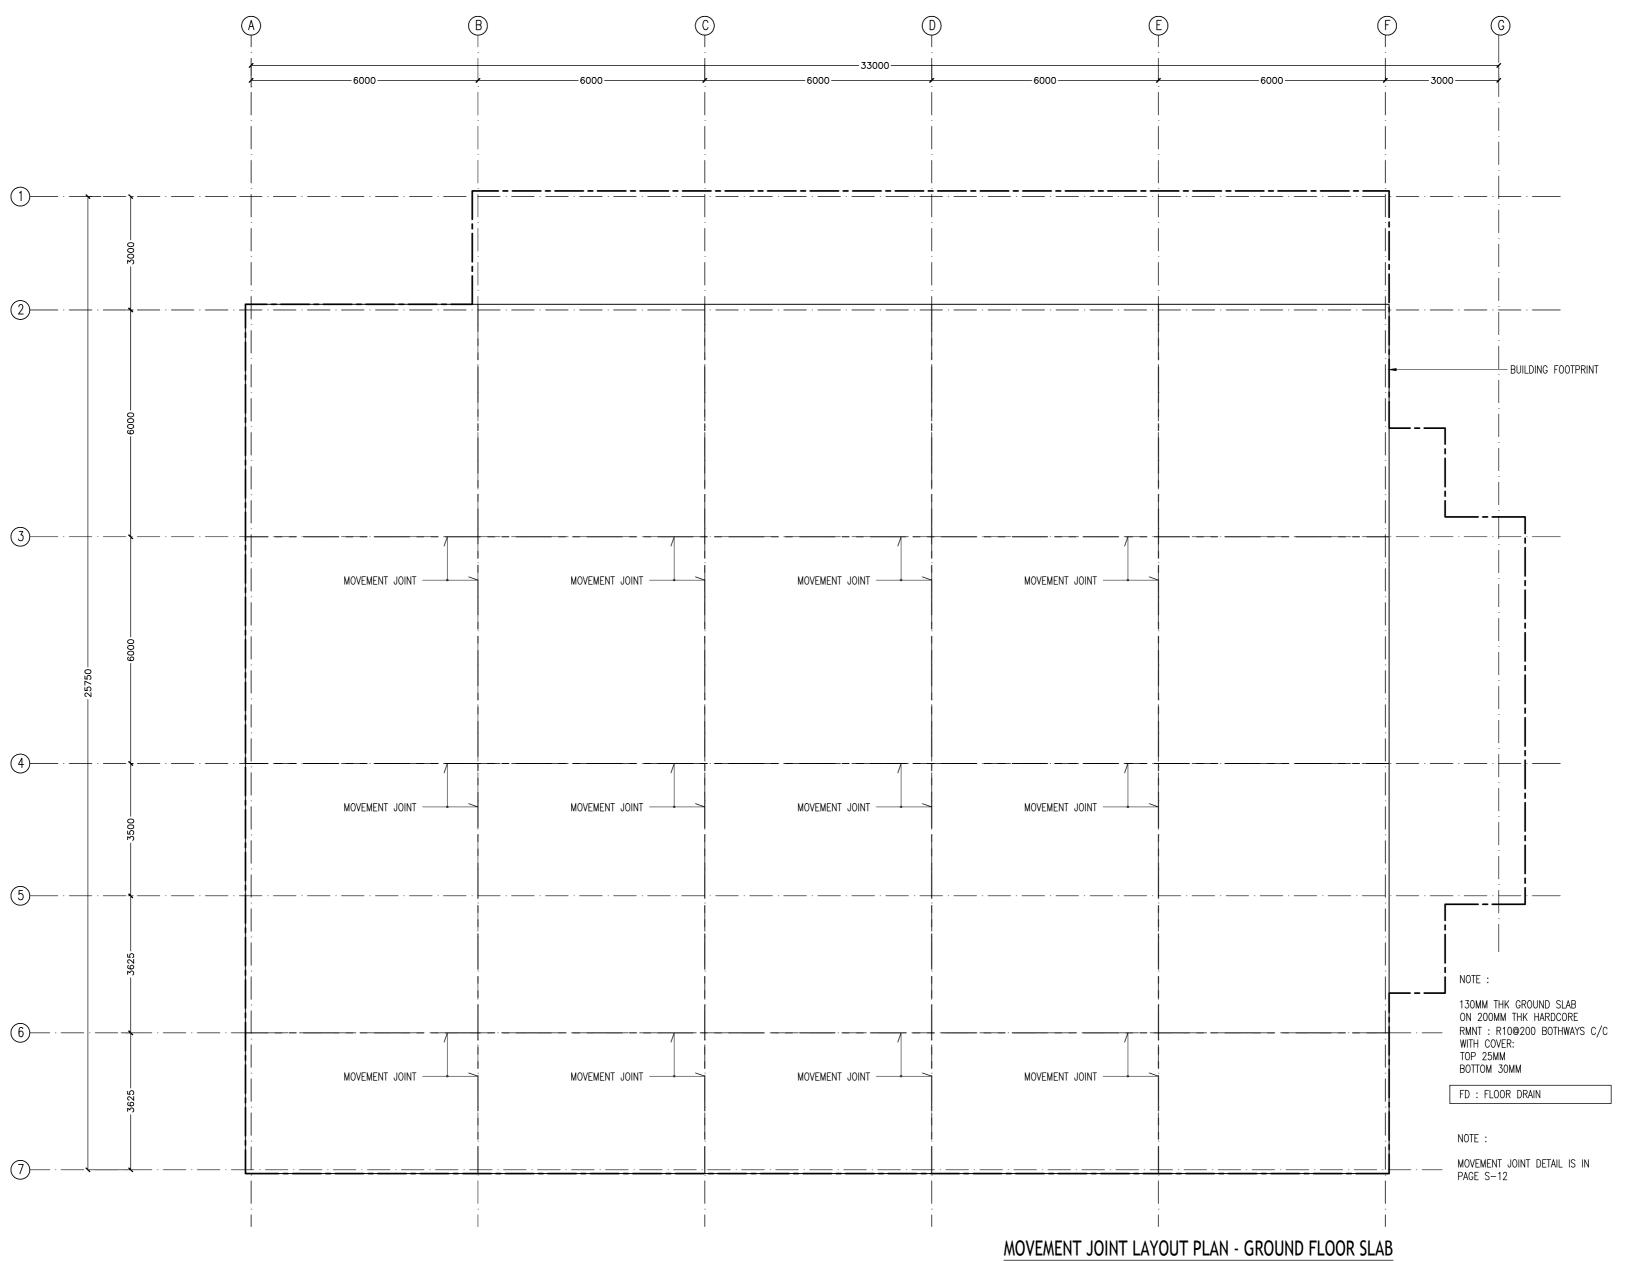


SCALE 1:100




EVISION:	PRINCIPAL ARCHITECT: MOHAMED HAMEEN
_	ARCHITECT: AHMED AMEEL SHAKEEL
	PRINCIPAL ENGINEER: MOHAMED AHSAN
	ENGINEER: SHAUFA AHMED
_	DRAWN BY: MALEEHA IBRAHIM

PROJECT:	SINGLE STOREY FERRY T		
LOCATION:	HDH. KULHUDUFUSHI	S-10A	
DRAWING TITLE:	WING TITLE: AS GIVEN		
CLIENT: MINISTRY OF HOUSING AND INFRASTRUCTURE			DWG NO
SCALE: AS GIVEN	DIMENSION: MM	DATE: JAN 2018	PROJECT NO:
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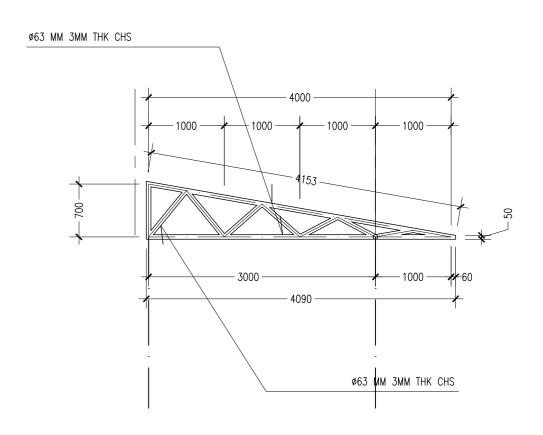


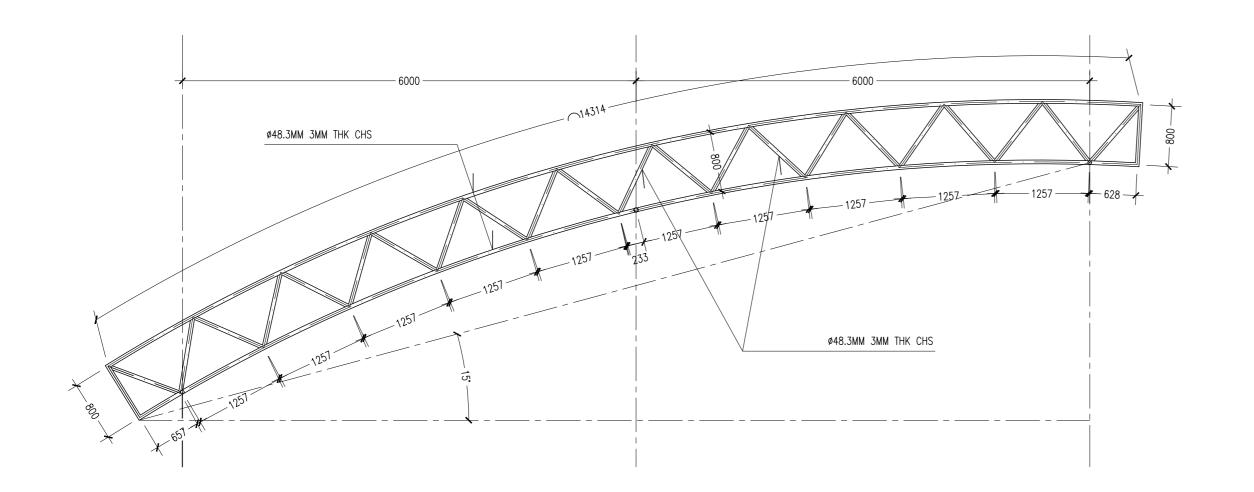TRUSS DETAILS (TR3) SCALE: 1:50

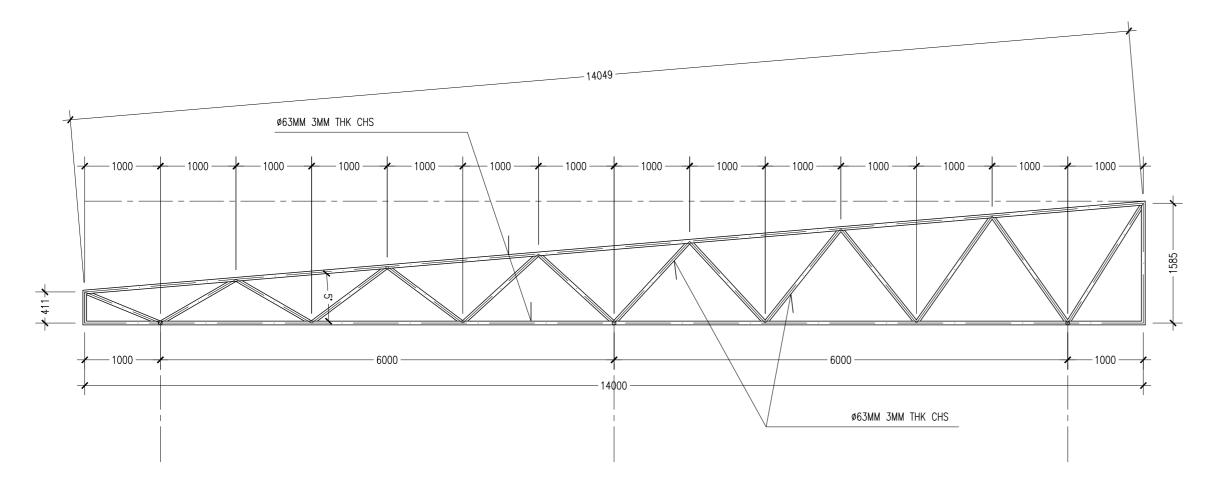

TRUSS DETAILS (TR2) SCALE: 1:50

TRUSS DETAILS (TR1)
SCALE: 1:50




TRUSS DETAILS (TR4) SCALE: 1:50




 PRINCIPAL ARCHITECT: MOHAMED HAMEEN
ARCHITECT: AHMED AMEEL SHAKEEL
PRINCIPAL ENGINEER: MOHAMED AHSAN
ENGINEER: SHAUFA AHMED
DDAWN BY: MALEEUA IRRAUIM


PROJECT: SINGLE STOR	SINGLE STOREY FERRY TERMINAL	
LOCATION: HDH. KULHUE	HDH. KULHUDUFUSHI	
DRAWING TITLE: AS GIVEN	AS GIVEN	
CLIENT: MINISTRY OF HOUSING	DWG NO	
SCALE: AS GIVEN DIMENSION	MM DATE: JAN 2018	PROJECT NO:

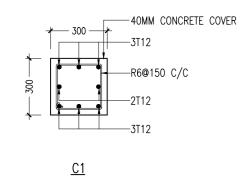



COLUMN DETAILS

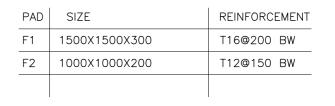

FOUNDATION PAD DETAILS

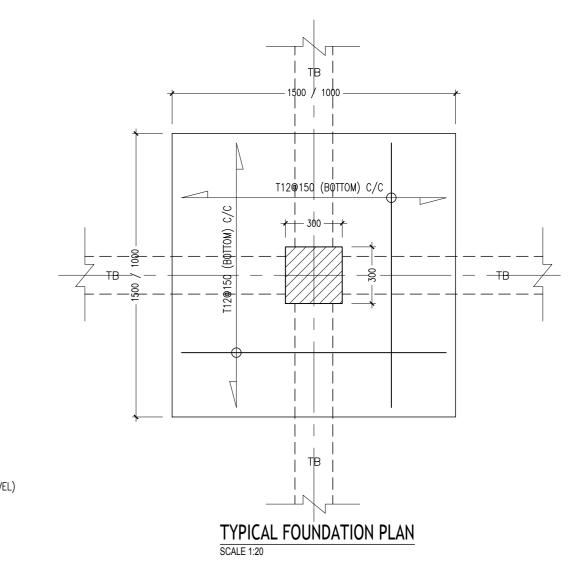

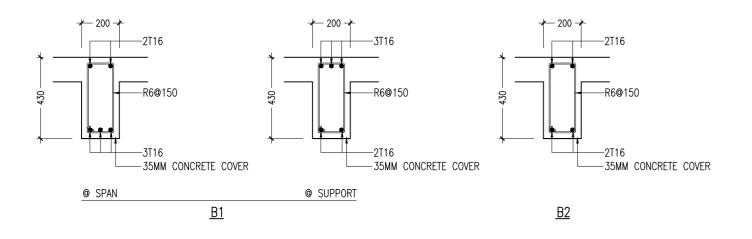


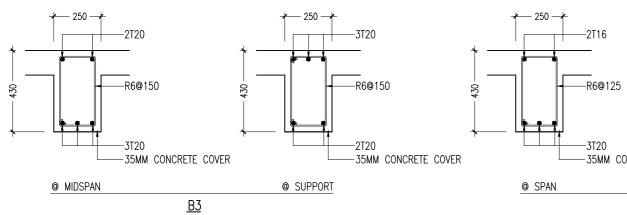

50MM FLR SCREES-

100MM GRD SLAB -

DPM -

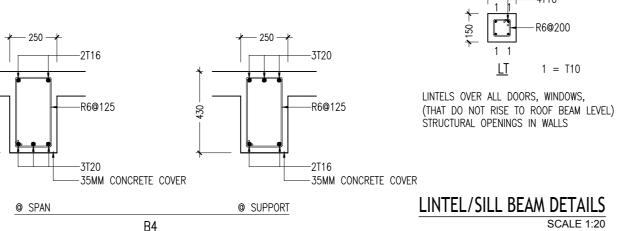

<u>B4</u>

-GILL COVERING

ANY BITUMINOUS WATER
PROOFING ON BOTH SIDES


-CONCRETE GUTTER




NOTES:

- FOUNDATION FOOTING: 50MM
- COVER TO COLUMNS : 40MM
- COVER TO BEAMS : 35MM - UNNERTETATION: 1:2:3



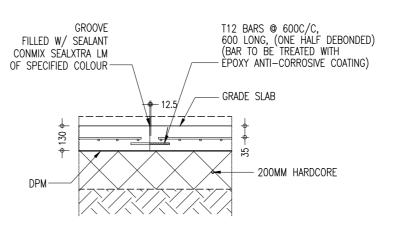

MOVEMENT JOINT SCALE 1:20

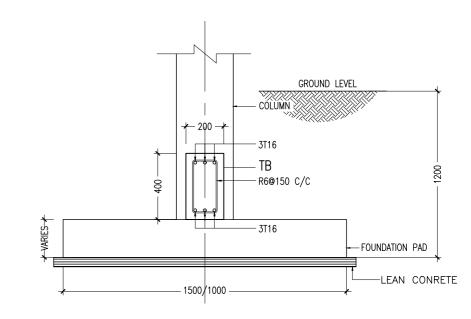

TYPICAL FOUNDATION SECTION SCALE 1:20

A CONTRACTOR OF THE CONTRACTOR	REVISION:
वाष्क्रीस लिमिटेड	
WAPCOS LIMITED	
^{*4} , _{RAT} ** (भारत सरकार का उपक्रम) जल संसाधन, नदी विकास व गंगा संरक्षण मंत्रालय	
(A Government of India Undertaking) Ministry of Water Resources, River Development & Ganga Rejuvenation	

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PRINCIPAL ENGINEER: MOHAMED AHSAN	
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DRAWN BY: MALEEHA IBRAHIM	

PROJEC	PROJECT: SINGLE STOREY FERRY TERMINAL			
LOCATIO	LOCATION: HDH. KULHUDUFUSHI			S-012
DRAWIN	G TITLE:	AS GIVEN		3-0 I Z
CLIENT:	CLIENT: MINISTRY OF HOUSING AND INFRASTRUCTURE			DWG NO
SCALE:	AS GIVEN	DIMENSION: MM	DATE: JAN 2018	PROJECT NO:
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