

B.EYDHAFUSHI HOSPITAL
SERVICES PLOT _ WASTE MANAGEMENT BLOCK
CLIENT: MINISTRY OF HEALTH

DETAILED ARCHITECTURAL & STRUCTURAL DRAWINGS




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3rd floor, H. Azumi, Ameermeenagau, Male'

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05 STOREY
MAIN HOSPITAL BLOCK
159.29 SQM / 1715 Sqft

03 STOREY
STAFF ACCOMMODATION BLOCK
350 SQM / 3767 Sqft

SINGLE STOREY
STAFF LAUNDRY BLOCK
184 SQM / 1980 Sqft

SINGLE STOREY
WASTE MANAGEMENT
74 SQM / 796 Sqft

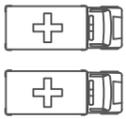SINGLE STOREY
SERVICES BLOCK
204 SQM / 2195 Sqft

LEGEND

-  Proposed Hospital Plots
-  Proposed Main Hospital Building
-  Proposed Accommodation Block
-  Proposed Laundry Block
-  Proposed Services Block
-  Proposed Services Block



KEY PLAN
NOT TO SCALE

B.Eydhafushi Hospital - Waste Management Block
Client: Ministry of Health

Rev no	Date
01	June 2022
02	
03	
04	
05	

Project Number: B21110MOH-BE
Date: June 2022
Architect: Mariyam Irasha Shareef
Engineer: Zainal Abiddeen Ali Rasheed
Drawn by: Zunabath Abdul Mujid
Interior: -



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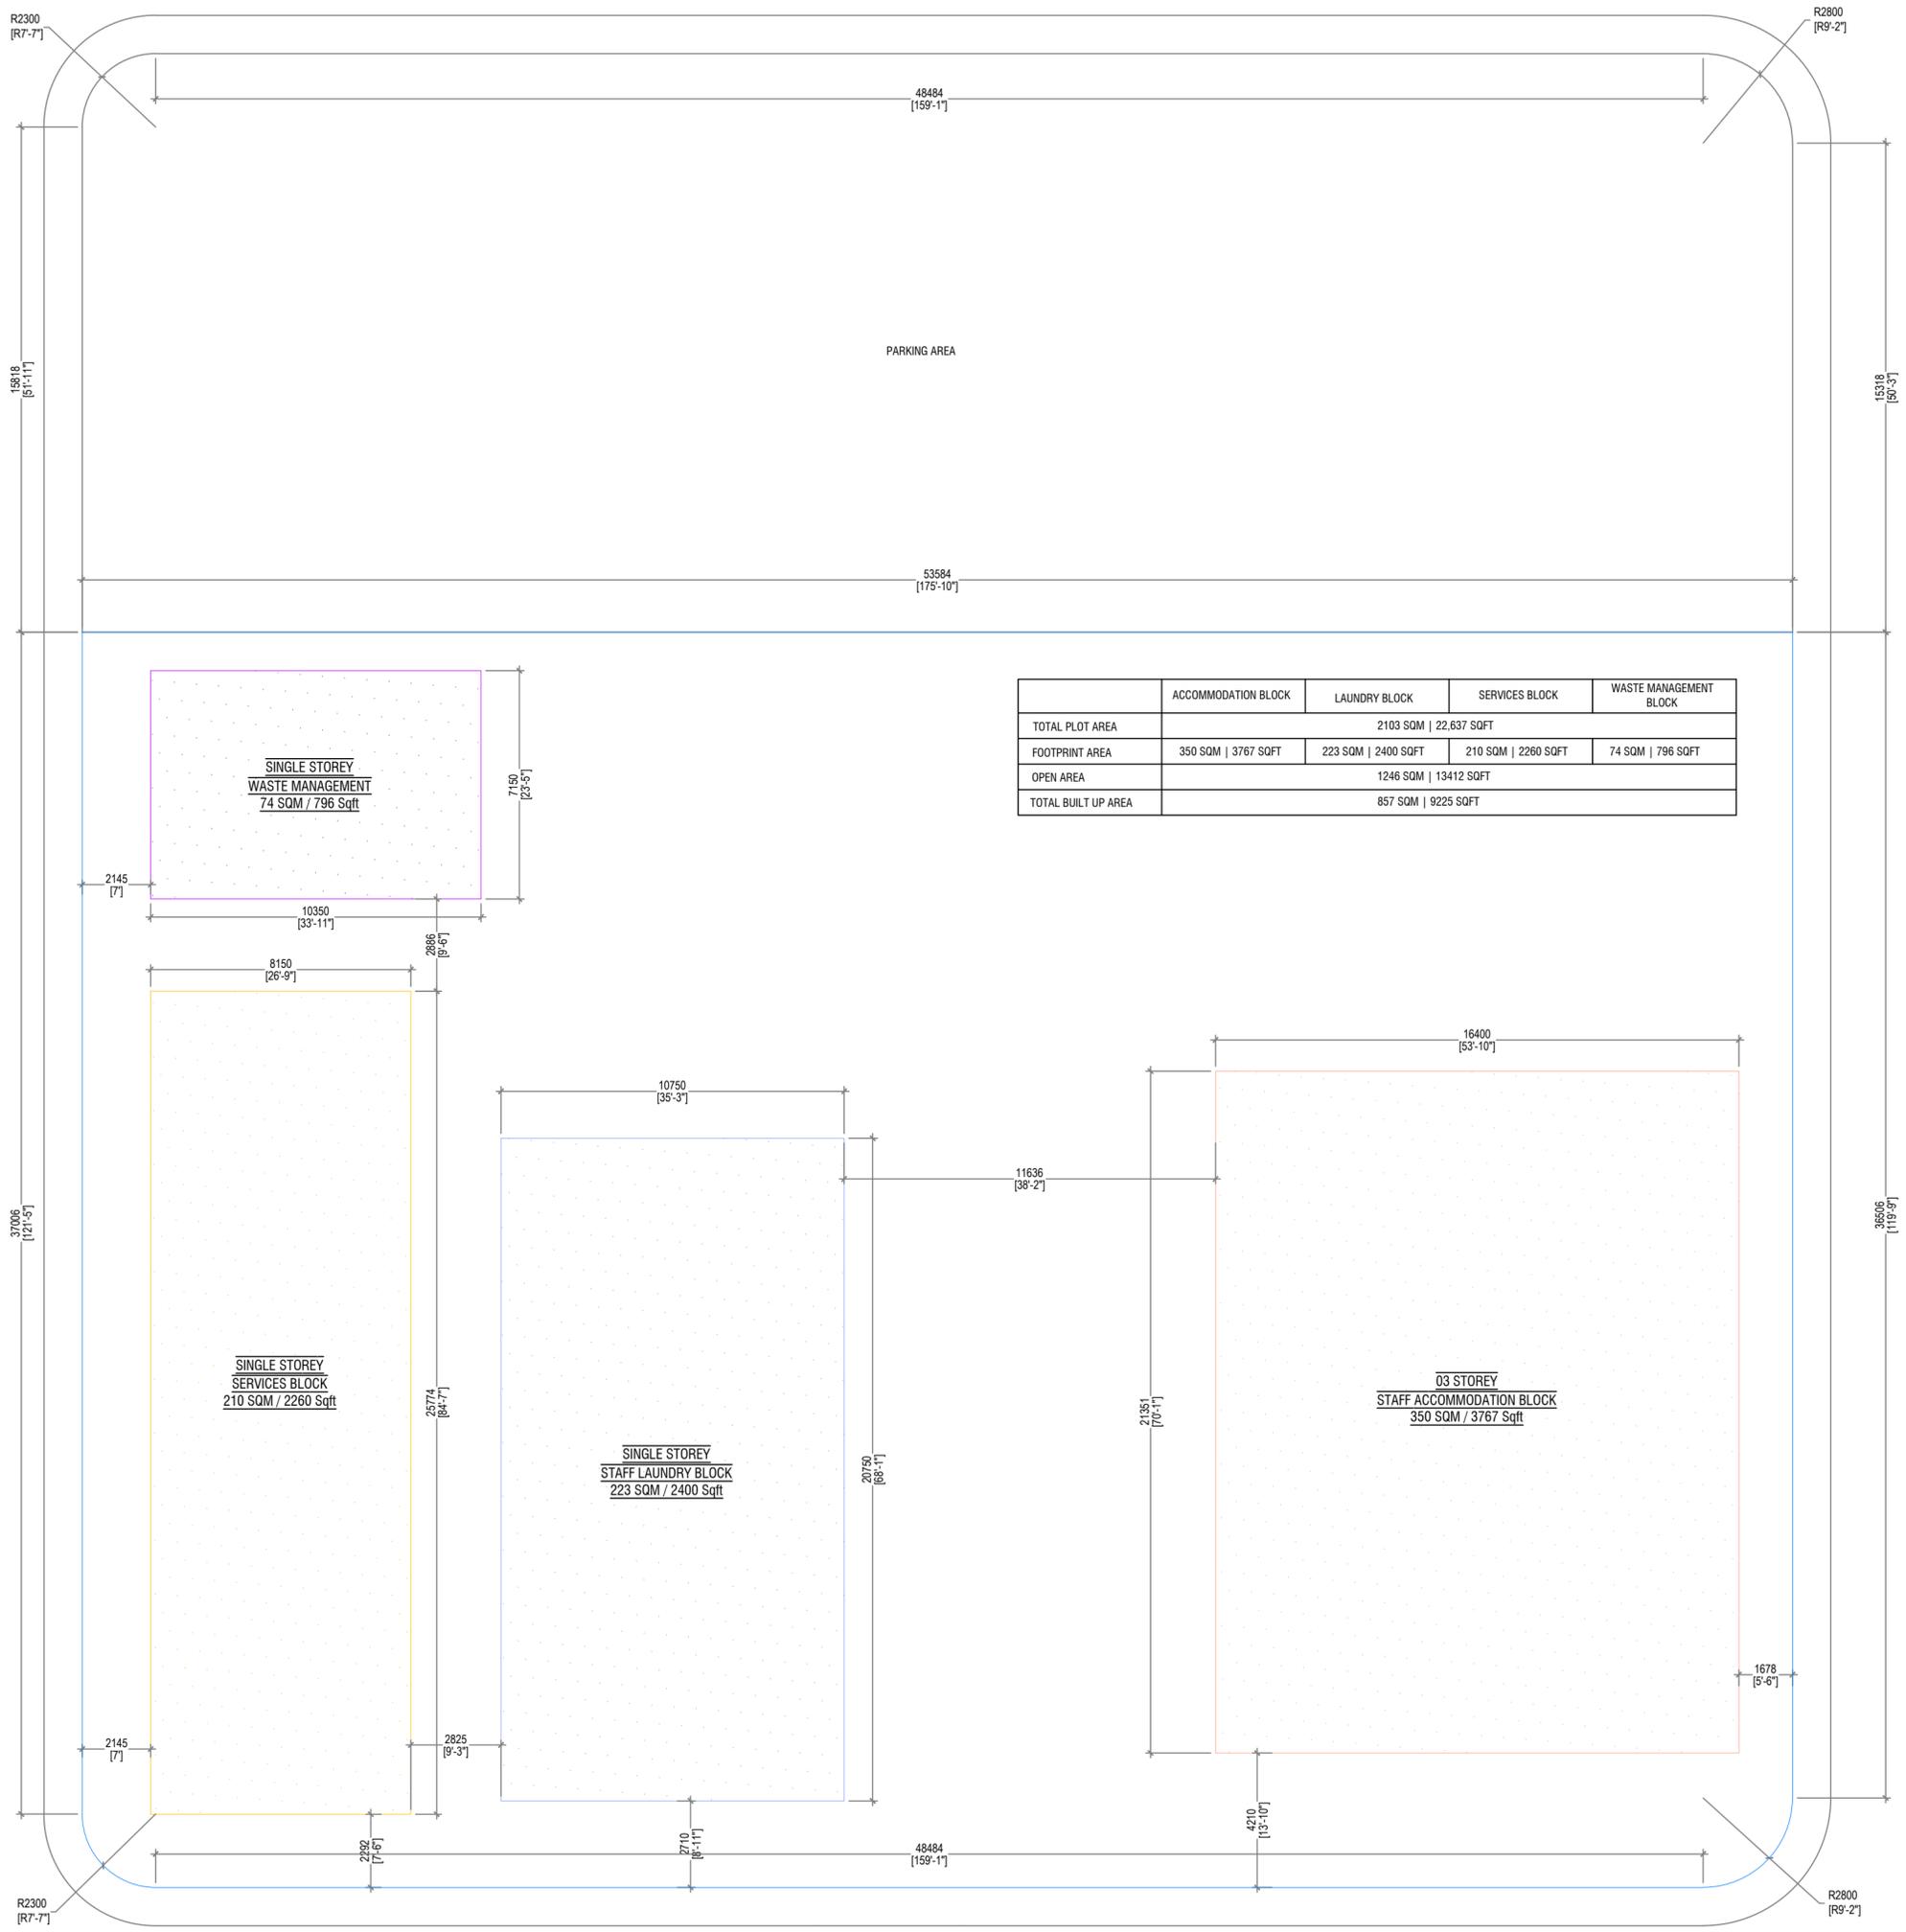
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Title: Key Plan

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5 M W I D E R O A D



	ACCOMMODATION BLOCK	LAUNDRY BLOCK	SERVICES BLOCK	WASTE MANAGEMENT BLOCK
TOTAL PLOT AREA	2103 SQM 22,637 SQFT			
FOOTPRINT AREA	350 SQM 3767 SQFT	223 SQM 2400 SQFT	210 SQM 2260 SQFT	74 SQM 796 SQFT
OPEN AREA	1246 SQM 13412 SQFT			
TOTAL BUILT UP AREA	857 SQM 9225 SQFT			

- LEGEND**
- Proposed Hospital Plots
 - Proposed Main Hospital Building
 - Proposed Accommodation Block
 - Proposed Laundry Block
 - Proposed Services Block
 - Proposed Services Block

LOCATION PLAN
SCALE 1:150

B. Eydhafushi Hospital - Waste Management Block
Client: Ministry of Health

Project Number: A271/DW/CH/BE
Architect: Maryam Inaba Shameel
Engineer: Zainal Abideen Ali Rasheed
Drawn by: Zunabath Abdul Majid
Checked by: _____
Inchored by: _____



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5 M W I D E R O A D

5 M W I D E R O A D

7 M W I D E R O A D



5 M W I D E R O A D

N

SERVICES PLOT
SITE PLAN
 SCALE 1:150
 0 25 1

B. Eydhafushi Hospital - Waste Management Block

Client: Ministry of Health

Project Number: A2710404-BE
 Architect: Muzayim Ibrahim Shamsi
 Engineer: Zainal Abideen Ali Raheed
 Drawn by: Zunabath Abdul Majid
 Interior:

Rev. no	Date



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Title: Site Plan


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**WASTE MANAGEMENT BLOCK
GROUND FLOOR PLAN**

SCALE 1:100



NOTES:

- 150mm THICK SOLID BLOCK MASONRY WALL WITH 16mm PLASTERING WATER-PROOF WITH PLASTOCRETE, GROUND SMOOTH IN MATTE EMULSION WHITE PAINT FINISH UPTO BEAM/SLAB
- 150mm THICK 1000mm HIGH SOLID BLOCK MASONRY WALL WITH 16mm PLASTERING WATER-PROOF WITH PLASTOCRETE, GROUND SMOOTH IN MATTE EMULSION WHITE PAINT FINISH

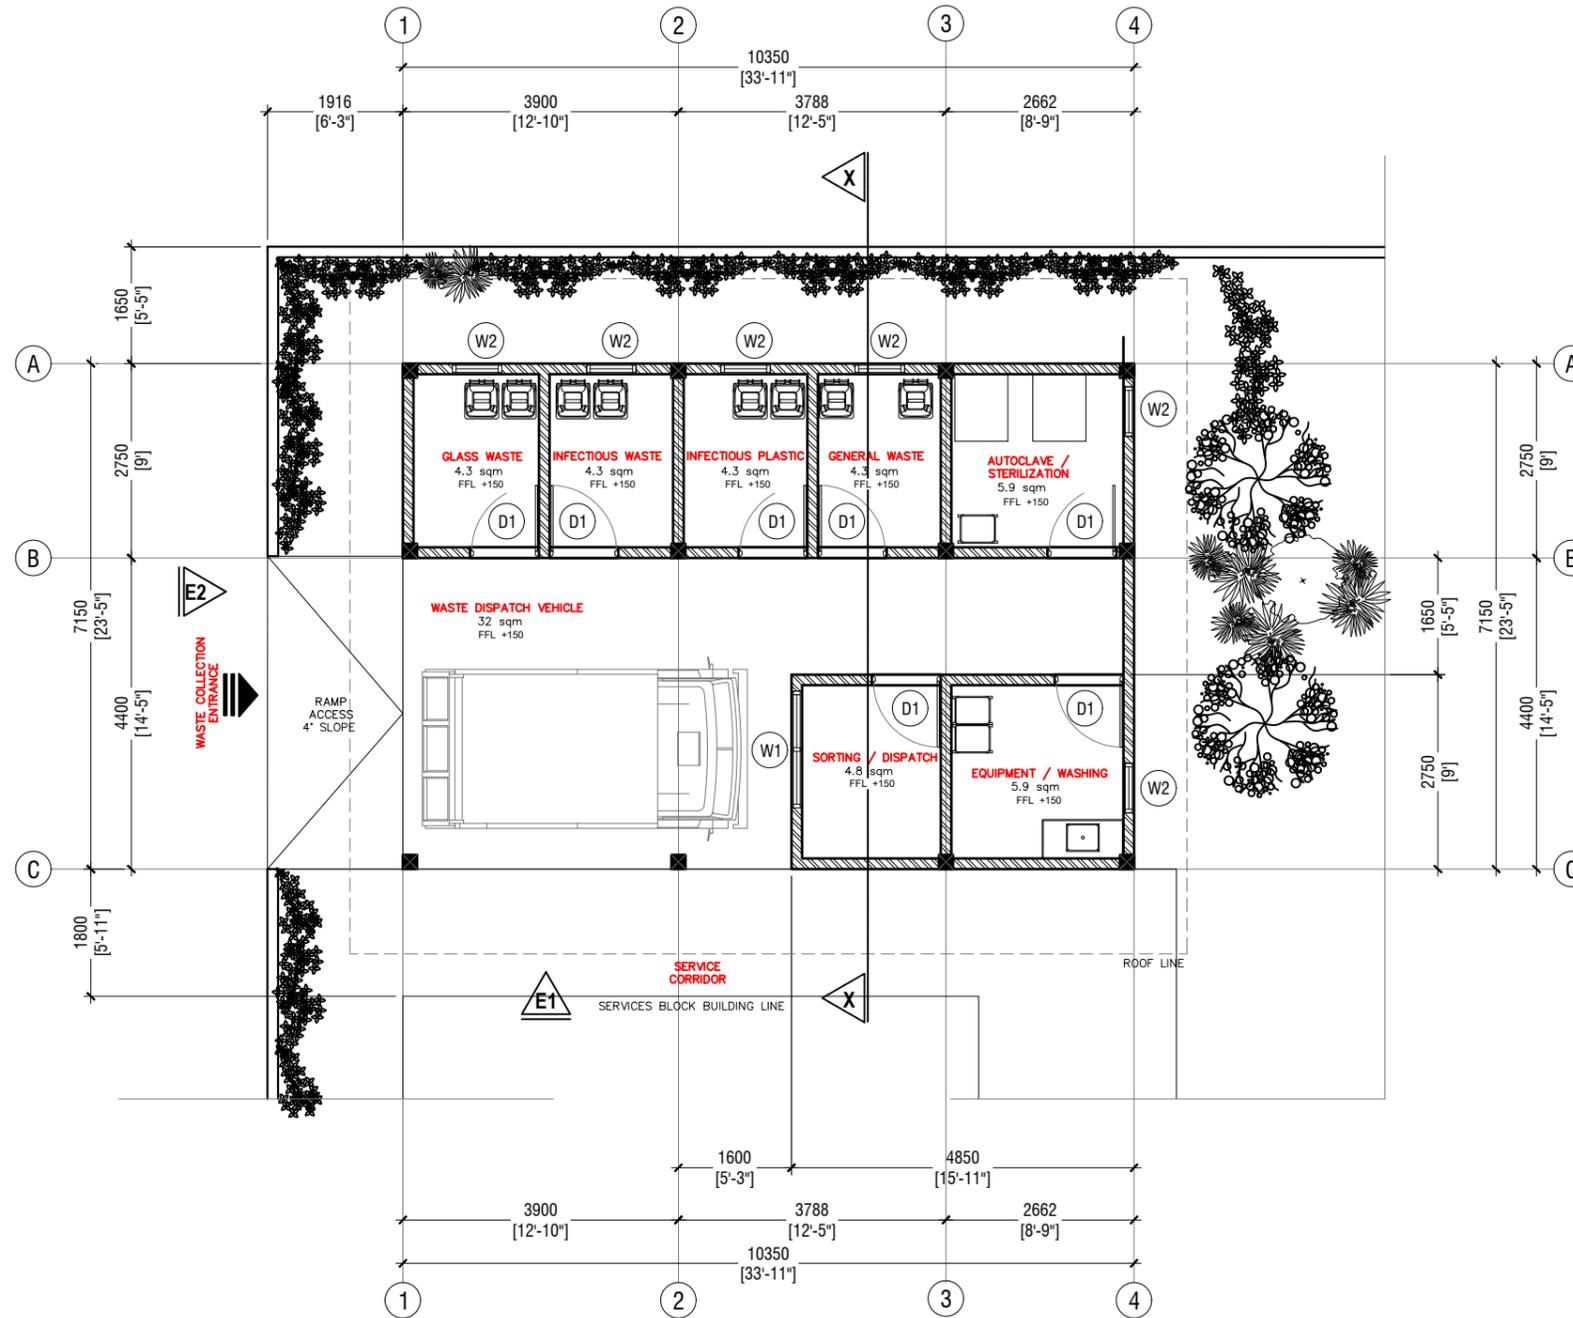**B.Eydhafushi Hospital - Waste Management Block
Client: Ministry of Health**

Rev no	Date

Project Number: R21110/MOH-BE
Date: June 2022
Architect: Mwanjama Inasha Shareef
Engineer: Zainal Abideen Ali Rasheed
Drawn by: Zainabath Abdul Majid
Interior: -



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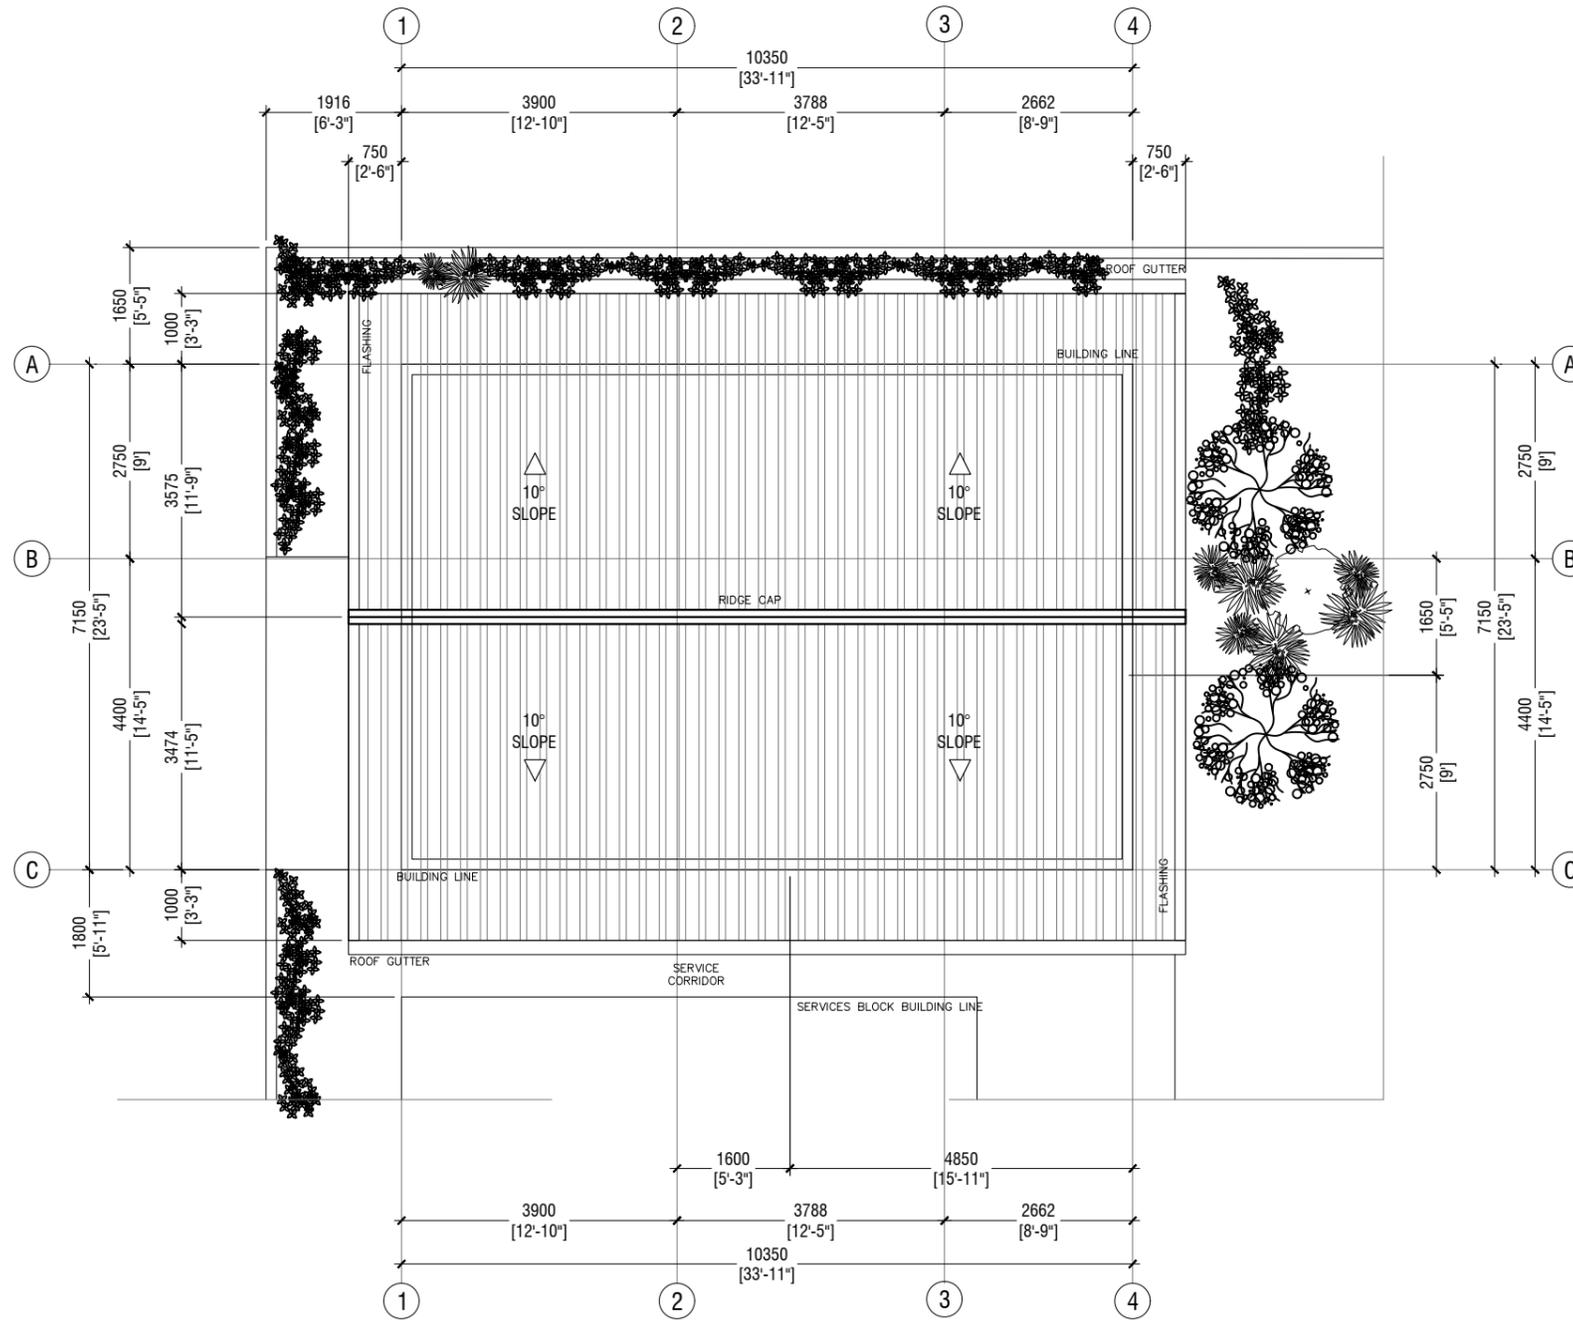
Title: Ground Floor Plan

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WASTE MANAGEMENT BLOCK ROOF PLAN

SCALE 1:100



NOTE:

ROOF SLOPE IS 10 DEGREES TO THE HORIZONTAL
ROOF FABRIC IS LYSAGHT ROOFING SHEETS
POLYCARBONATE ROOFING SHEET OVER SERVICE CORRIDOR

B.Eydhafushi Hospital - Waste Management Block
Client: Ministry of Health

Project Number: R27110/MOH-BE	Rev no	Date
Date: June 2022		
Architect: Manyam Inasha Shareef		
Engineer: Zainal Abideen Ali Rasheed		
Drawn by: Zainabath Abdul Majid		
Services: Interior		




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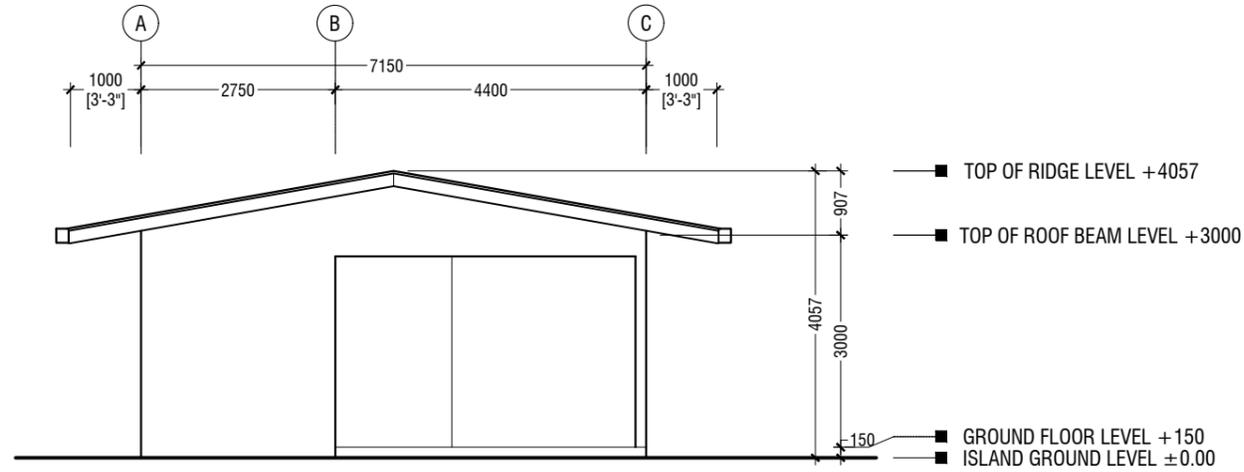
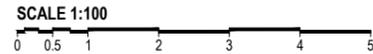
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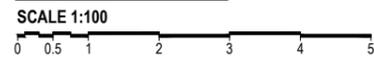
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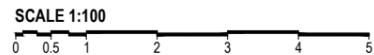
ELEVATION-E1



ELEVATION-E2



**WASTE MANAGEMENT BLOCK
ELEVATIONS**

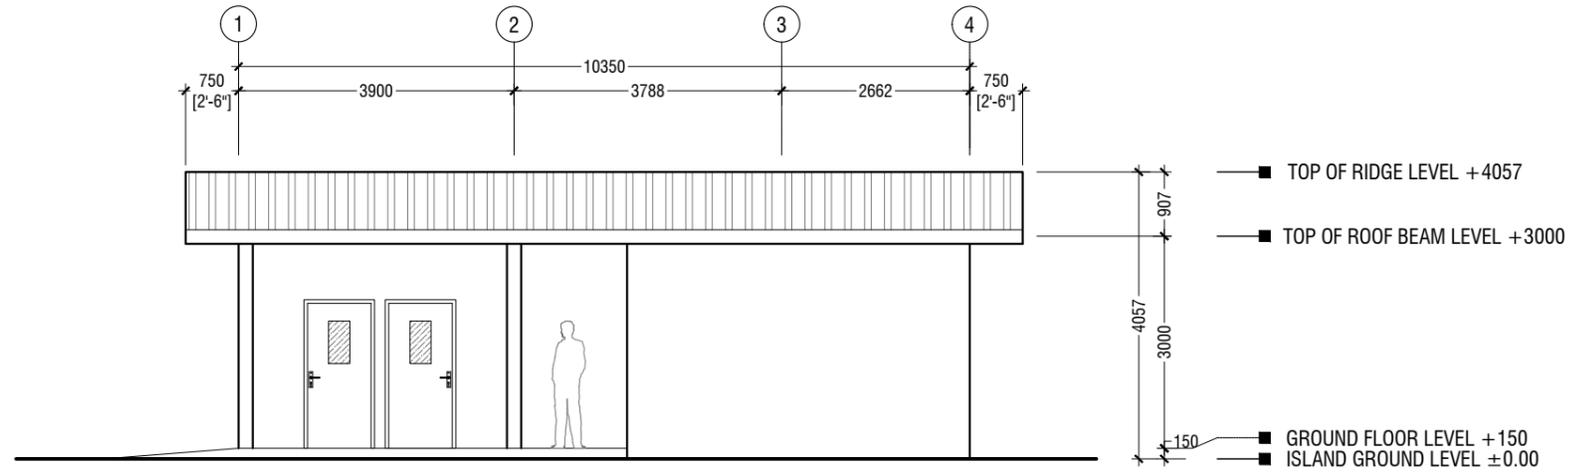

B.Eydhafushi Hospital - Waste Management Block
Client: Ministry of Health

Project Number: R271710/MOH-BE
 Date: June 2022
 Architect: Manyam Inasha Shareef
 Engineer: Zahal Abubteen Ali Rasheed
 Drawn by: Zuhairath Abdul Majid
 Services: Interior

Rev no	Date



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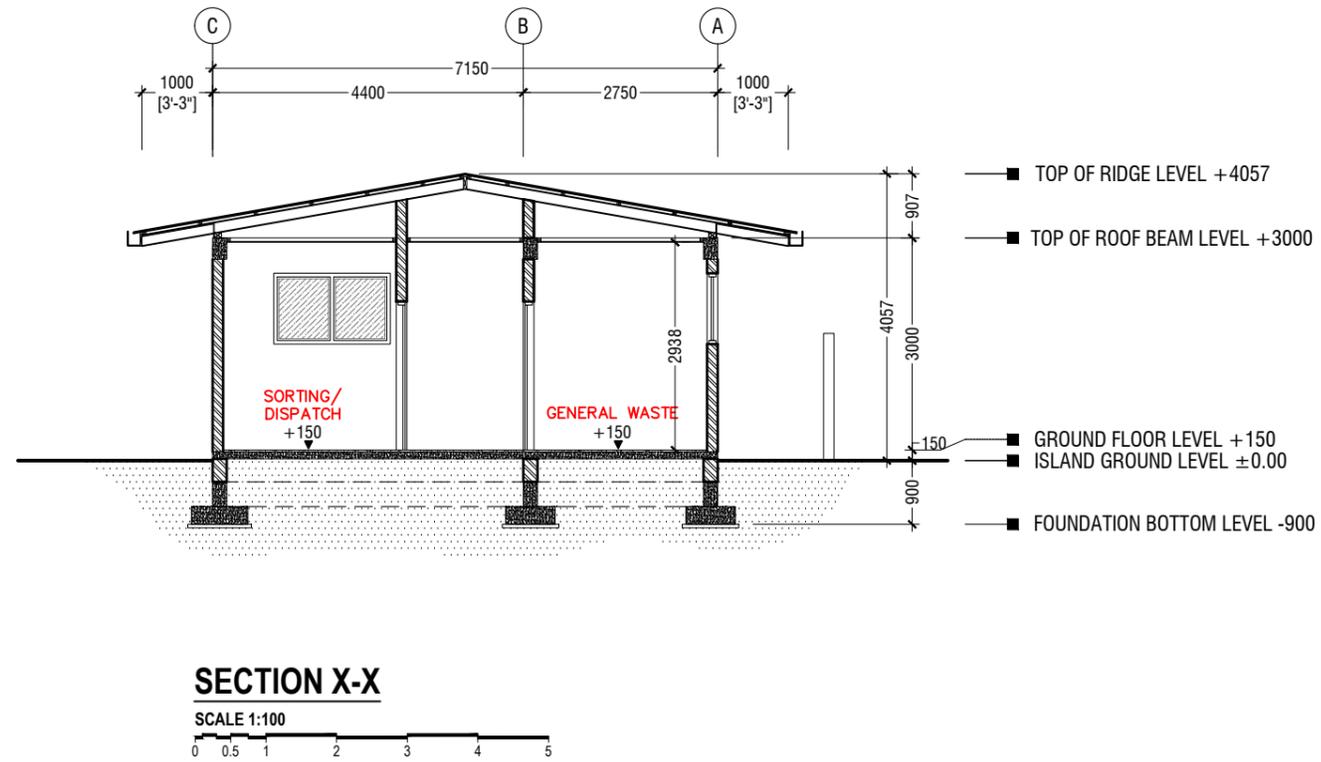
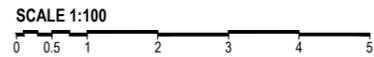
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Title: Elevations

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**WASTE MANAGEMENT BLOCK
SECTIONS**



B.Eydhafushi Hospital - Waste Management Block
Client: Ministry of Health

Project Number: R21110/MOH-BE	Rev no	Date
Date: June 2022		
Architect: Mamyam Inasha Shareef		
Engineer: Zahar Abubteen Ali Rasheed		
Drawn by: Zainabath Abdul Majid		
Services: Interior		





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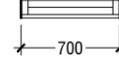
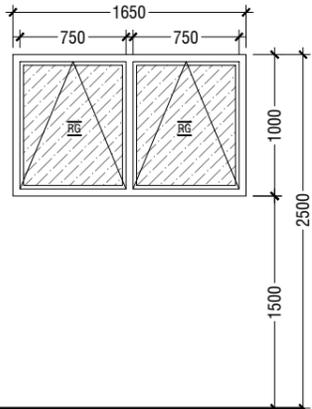
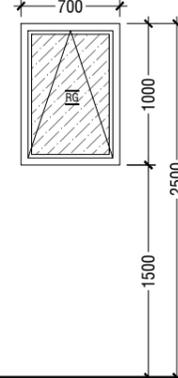
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Title: Section

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ELEMENT ID	D1 - SOLID TIMBER DOOR WITH VIEW PANEL (SINGLE SWING)
QUANTITY	07
W x H SIZE	1000 x 2100
SILL HEIGHT	00
LINTEL HEIGHT	2100
2D SYMBOL	
ELEVATION	
FIRE RESISTANCE RATING	20 MINUTES
LOCATION	WASTE MANAGEMENT BLOCK
AREA	1.845 SQM
REMARKS	FRAME: TIMBER FRAME DEPTH TO BE WIDTH OF THE WALL PANEL: 32mm THICK SOLID TIMBER DOOR PANEL WITH PVC VENEER SHEET FACING. 6mm THICK TEMPERED CLEAR GLASS VIEW PANEL.
HARDWARE	HINGE : 4"x3"x3mm THK. BUTT HINGE, SS FINISH (8pcs) LOCKSET : EURO PROFILE DEAD LOCK WITH TURN & KEY CYLINDER & ESCUTCHEON, DOOR HANDLE LEVER TYPE. DOOR CLOSER FOR BIGGER PANEL, DOOR STOPPER.

ELEMENT ID	W1 - TOP HUNG WINDOW	W2 - TOP HUNG WINDOW
QUANTITY	01	06
W x H SIZE	1650 x 1000	1000 x 1000
SILL HEIGHT	1500	1500
LINTEL HEIGHT	2500	2500
2D SYMBOL		
ELEVATION		
FIRE RESISTANCE RATING	20 MINUTES	20 MINUTES
LOCATION	WASTE MANAGEMENT BLOCK	WASTE MANAGEMENT BLOCK
AREA	1.35 SQM	0.54 SQM
REMARKS	POWDER COATED (60 MICRONS) ALUMINUM FRAMED WITH 6mm THICK REFLECTIVE GLASS	POWDER COATED (60 MICRONS) ALUMINUM FRAMED WITH 6mm THICK REFLECTIVE GLASS
HARDWARE	FLUSH HANDLE	FLUSH HANDLE

LEGEND:
MP - MARINE PLYWOOD
P - PLYWOOD
ST - SOLID TIMBER
LST - LEAD LINED SOLID TIMBER
SS - STAINLESS STEEL
AL - ALUMINIUM
TG - TEMPERED GLASS
CG - CLEAR GLASS
RG - REFLECTED GLASS
FG - FROSTED GLASS
PVC - POLYVINYL CHLORIDE
LV - ALUMINIUM LOUVERS

NOTE:-
- ALL DOORS & WINDOWS TO BE CHECKED ON SITE BEFORE FABRICATION.
- ALL DOOR & WINDOWS VIEWED FROM EXTERIOR, FOR DOOR SWING, REFER TO FLOOR PLANS.
- THE DOORS / WINDOWS WHICH DO NOT TOUCH THE BEAM SHALL HAVE A LINTEL BEAM (LB) ABOVE THE DOOR / WINDOW.
- FOR ALL THE WINDOWS PUT A SILL BEAM BELOW THE WINDOW (SB)
- FOR SAFETY PURPOSES REFER TO TECHNICAL SPECIFICATIONS FOR GLASS THICKNESS.
- FOR ALL DOOR & WINDOWS ON EXTERIOR FACADE SHALL BE DOUBLE GLAZED.

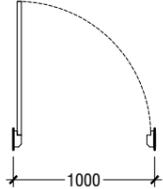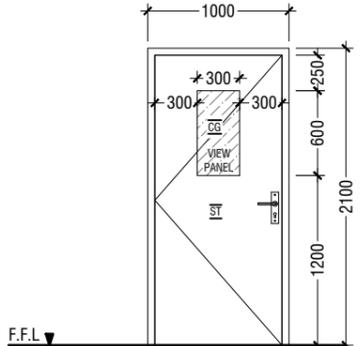WASTE MANAGEMENT BLOCK DOOR & WINDOW SCHEDULE

SCALE 1:50


B.Eydhafushi Hospital - Waste Management Block
Client: Ministry of Health

Project Number: R2110/MOH-BE	Rev no	Date
Date: June 2022		
Architect: Manyam Inasha Shareef		
Engineer: Zahar Abubteen Ali Rasheed		
Drawn by: Zuhairath Abdul Majid		
Services: Interior		



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Title: Door/Window Schedule

Page: A-08/08

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GENERAL NOTES

THE GENERAL NOTES SHALL BE READ IN CONJUNCTION WITH THE CONTRACT SPECIFICATIONS AND DRAWINGS. REGARDLESS OF WHETHER OR NOT SHOWN IN DRAWINGS OR OTHER TENDER DOCUMENTS, THE STANDARD PROVISIONS SPECIFIED HEREUNDER FOR COMPLIANCE BY THE CONTRACTOR SHALL APPLY TO ALL RELEVANT PORTIONS OF THE STRUCTURAL WORKS AND SHALL FORM PART OF THIS CONTRACT.

1.0 VERIFICATION OF DIMENSIONS AND LEVELS

- THE CONTRACTOR SHALL VERIFY ALL DIMENSIONS AND LEVELS ON SITE, AND RESOLVE ALL DISCREPANCIES WITH THE ARCHITECT OR ENGINEER PRIOR TO COMMENCEMENT OF WORK.
- DRAWING INDICATES GENERAL & TYPICAL DETAILS OF CONSTRUCTION. WHERE CONDITIONS ARE OF SIMILAR CHARACTER TO DETAILS SHOWN AND ALTHOUGH NOT SPECIFICALLY INDICATED, SIMILAR DETAILS OF CONSTRUCTION SHALL BE USED SUBJECT TO REVIEW BY THE ENGINEER.
- PRIOR TO COMMENCEMENT OF WORKS, THE CONTRACTOR SHALL VERIFY ALL DIMENSIONS AND LEVELS IN THE CONTRACT DRAWINGS.
- DISCREPANCIES IN DRAWINGS ARISING FROM SUCH VERIFICATION WORKS SHALL BE BROUGHT TO THE ATTENTION OF THE ARCHITECT/ENGINEER.

2.0 SHOP DRAWINGS

- THE CONTRACTOR SHALL BE SOLELY RESPONSIBLE FOR ENSURING TOTAL COORDINATION OF ALL WORKS AND SHALL TAKE SITE MEASUREMENTS PRIOR TO THE PREPARATION OF ANY SHOP DRAWINGS OR BEFORE COMMENCING FABRICATION.
- THE CONTRACTOR SHALL SUBMIT SHOP DRAWINGS FOR ALL SPECIALIST TRADES, SUCH AS PRESTRESSING, CURTAIN WALLING, ETC. FOR REVIEWS AND COMMENTS BY THE ARCHITECT/ENGINEER PRIOR TO COMMENCEMENT OF WORK. SUCH SHOP DRAWINGS SUBMITTED SHALL INCORPORATE ALL NECESSARY CONNECTION DETAILS TO THE STRUCTURAL MEMBERS SUCH AS CAST-IN INSERTS, EMBEDDED PLATES, ETC.

3.0 INCORPORATION OF M&E REQUIREMENTS IN THE STRUCTURE

- THE CONTRACTOR SHALL BE SOLELY RESPONSIBLE FOR ENSURING TOTAL COORDINATION OF STRUCTURAL, M & E PENETRATION DRAWINGS OF SERVICES AND SUBMIT SUCH SHOP DRAWINGS TO THE ARCHITECT/ENGINEER FOR REVIEWS AND APPROVAL PRIOR TO COMMENCEMENT OF WORK.
- THESE SHOP DRAWINGS SHALL INCORPORATE ALL MECHANICAL, ELECTRICAL AND SANITARY WORKS TO BE EMBEDDED IN CONCRETE AND ALL OPENINGS FOR ALL PIPE OR DUCT WORKS, BASED ON THE REQUIREMENTS OF M & E DRAWINGS IN HIS POSSESSION.
- HE SHALL CHECK AND RESOLVE ALL DISCREPANCIES WITH THE RESPECTIVE ENGINEER PRIOR TO PLACEMENT OF CONCRETE.

4.0 LEAN CONCRETE FOR SUSPENDED STRUCTURES

- UNLESS OTHERWISE STATED, 50 MM THICK LEAN CONCRETE WITH A MINIMUM 28-DAY CUBE STRENGTH OF 15N/MM² SHALL BE PROVIDED ON ALL SOIL SURFACES FORMING THE UNDERSIDE OF STRUCTURAL CONCRETE MEMBERS.

5.0 STRUCTURAL ELEMENTS ON GRADE

- UNLESS OTHERWISE STATED, A SINGLE LAYER OF 0.25 MM (HEAVY DUTY) POLYTHENE SHEET, OR EQUIVALENT THERMOPLASTIC MATERIAL, LAID OVER A COMPACTED 60 MM THICK LAYER OF HARD CORE BLINDED WITH SAND TO PREVENT GROUT LOSS FROM SEEPAGE INTO THE GROUND SHALL BE PROVIDED ON ALL SOIL SURFACES FORMING THE UNDERSIDE OF THE NON-SUSPENDED SLABS.

6.0 SUBGRADE UNDER STRUCTURAL ELEMENTS

- WHERE THE CONTRACTOR REQUIRES REMOVAL AND SUBSEQUENT BACKFILL OF SUBGRADE PRIOR TO CASTING OF PILECAP/WALL/BEAM/SLAB, HE SHALL ENSURE THAT THE BACKFILL IS OF APPROVED MATERIAL AND THAT THE BACKFILL SHALL BE REASONABLY COMPACTED TO ENSURE THAT THE COMPACTED SOIL IS ABLE TO WITHSTAND THE WEIGHT OF THE WET CONCRETE. THE CONTRACTOR SHALL EXERCISE PROPER SKILL AND CARE TO AVOID DAMAGE TO ADJACENT INSTALLED STRUCTURES ARISING FROM HIS CONSTRUCTION SEQUENCE.

7.0 WATERPROOFING FOR STRUCTURES

- THE CONTRACTOR SHALL SUBMIT SHOP DRAWINGS AND METHOD STATEMENTS FOR THE ENGINEER'S APPROVAL PRIOR TO COMMENCEMENT OF WORK. REQUIRED SHOP DRAWING DETAILS INCLUDE BUT ARE NOT LIMITED TO TREATMENT OF FLASHINGS, WATERSTOP AT CONSTRUCTION JOINTS, WALL AND SLAB PENETRATIONS.
- ALL PENETRATIONS THROUGH STRUCTURAL ELEMENTS SHALL BE CAST-IN, SLEEVED AND PROVIDED WITH APPROVED PUDDLE FLANGE DETAIL. IF FOR ANY REASON THE CONTRACTOR IS UNABLE TO LAY WATERSTOP AT CONSTRUCTION JOINTS AS INDICATED IN THE DRAWINGS, HE SHALL AT HIS OWN EXPENSES PROVIDE ADEQUATE GROUT TUBES FOR WATERPROOF PRESSURE GROUTING TO ENSURE WATERTIGHTNESS OF THE JOINT.
- ALL GROUT TUBES SHALL BE MARKED AND PROTECTED FROM BLOCKAGE.
- BACKFILLING OPERATIONS AGAINST VERTICAL SURFACE SHALL BE CARRIED OUT AS SOON AS THE WATERPROOFING BARRIER IS INSTALLED TO THE SATISFACTION OF THE ENGINEER.

8.0 CASTING LAYERS

- INCLINED CASTING LAYERS AND INCLINED CONSTRUCTION JOINTS SHALL BE AVOIDED.
- HORIZONTAL CASTING LAYERS SHALL NOT IN GENERAL EXCEED 0.6 M THICKNESS UNLESS OTHERWISE APPROVED BY THE ENGINEER.

9.0 FOUNDATIONS

- ALL FOUNDATIONS HAS BEEN DESIGNED FOR SAFE GROUND PRESSURE OF 120 KN/M.
- ALL BACKFILL SHOULD BE DONE WITH MATERIALS APPROVED BY THE CONSULTANT AND SOURCE. ALL BACKFILL SHOULD BE STRUCTURAL FILL, COMPACTED IN LAYERS AS SPECIFIED.
- WEAK POCKETS FOUND BELOW THE ASSUMED FOUNDATION LEVELS SHALL BE REMOVED AND REPLACED BY PLAIN CONCRETE.
- IN CASE OF EXCAVATIONS BELOW THE ASSUMED LEVEL OF THE FOUNDATION, THE SOIL SHALL BE REPLACED BY PLAIN CONCRETE.
- IN CASE GROUND WATER IS PRESENT ABOVE FOUNDATION LEVEL, THE CONTRACTOR SHALL BE RESPONSIBLE FOR DEWATERING THE BELOW LEVEL OF FOUNDATIONS.
- THE CONTRACTOR SHALL MAINTAIN DRY WORKING CONDITIONS THROUGH OUT THE CONSTRUCTION PERIOD. RESTORING WATER TABLE CAN BE DONE AFTER BACKFILLING AND COMPACTION UP TO THE SLAB ON GRADE LEVEL, OR AS DIRECTED BY THE ENGINEER.
- NO BACK FILLING SHALL BE PLACED AGAINST WALLS RETAINING EARTH, UNLESS THE WALLS ACHIEVE SUFFICIENT STRENGTH TO PREVENT MOVEMENT OR STRUCTURAL DAMAGE.

10.0 CONSTRUCTION LOAD AND SHORING

- CONSTRUCTION LIVE LOAD IMPOSED ON ANY SINGLE FLOOR SHALL NOT EXCEED 1.5 KN/M². UNLESS OTHERWISE APPROVED BY THE ENGINEER, DEAD LOAD OF THE TOP CONSTRUCTION FLOOR SHALL BE SUPPORTED BY TWO COMPLETED FLOORS DIRECTLY BELOW IT.
- PROPS TO BEAMS AND SLABS AT ANY FLOORS SHALL NOT BE REMOVED UNTIL THE TWO IMMEDIATE FLOORS ABOVE THAT LEVEL ARE CAPABLE OF SUPPORTING THEMSELVES AS WELL AS ANY LOADS IMPOSED DURING CONSTRUCTION. CONSIDERATIONS GOVERNING REMOVAL OF PROPS INCLUDE BUT ARE NOT LIMITED TO THE ATTAINMENT OF 28-DAY STRENGTH FOR THE CONCRETE, DESIGN LOAD CAPACITY OF THE FLOOR UNDER REVIEW AND THE COMPLETION OF PRESTRESSING AND GROUTING OPERATIONS IN THE CASE OF A PRESTRESSED STRUCTURAL FLOOR SYSTEM.
- PROPS SHALL BE LEFT IN PLACE FOR SUPPORTING THE CONSTRUCTION LOADS APPROVED BY THE ENGINEER.
- NO ALLOWANCE HAS BEEN MADE IN THE DESIGN OF THE PERIMETER BEAMS/WALLS FOR THE SUPPORT OF TEMPORARY SCAFFOLDINGS.
- THE CONTRACTOR SHALL ENGAGE HIS OWN PROFESSIONAL ENGINEER TO DESIGN AND STRENGTHEN THE BEAMS/WALLS.
- THE CONTRACTOR SHALL ENGAGE HIS OWN PROFESSIONAL ENGINEER CHECK THE ADEQUACY OF SHORING DETAIL PROVIDED PROCEEDING THE WORK, AS SHORING WAS DESIGNED, CONSIDERING THE STATUS OF THE BUILDING AT THE TIME OF DESIGN.

11.0 CONCRETE COVER

- MINIMUM COVER TO OUTERMOST REINFORCEMENT INCLUDING LINKS SHALL BE AS FOLLOWS.

STRUCTURAL ELEMENT	COVER (mm)
FOOTINGS	50
TIE BEAMS	50
COLUMN	40
BEAM	35
SLAB	30
INTERNAL WALL	30
EXTERNAL WALL	40

- NOTE: EARTH FACE COVER OF BEAMS, COLUMNS & WALLS SHOULD BE 50mm

12.0 MATERIAL STRENGTHS

12.1 CONCRETE

- UNLESS OTHERWISE STATED, ORDINARY PORTLAND CEMENT CONFORMING TO BS 12, TO BE USED FOR ALL THE RC STRUCTURAL ELEMENTS.
- THE MINIMUM 28-DAY COMPRESSIVE CUBE STRENGTH OF CONCRETE FOR SPECIFIED STRUCTURAL ELEMENTS SHALL BE AS FOLLOWS UNLESS OTHERWISE STATED:

MAIN BUILDING	
LEAN CONCRETE	15 N/mm ²
MASS CONCRETE	25 N/mm ²
COLUMN, BEAM AND SLAB	25 N/mm ²
EXTERNAL WORK	
PAVEMENTS	25 N/mm ²
ALL OTHERS (CULVERT, DRAINS, MANHOLE, ETC)	25 N/mm ²
FOUNDATION	
PILECAP, FOOTING, RAFT TIE-BEAM, CAPPING BEAM	25 N/mm ²

- CEMENT SHALL BE ORDINARY PORTLAND CEMENT TO BS 12.

12.2 REINFORCEMENT

- UNLESS OTHERWISE STATED, BAR SIZE 10MM DIAMETER OR LARGER SHALL BE HIGH TENSILE TYPE II DEFORMED BARS. THE MINIMUM YIELD STRENGTH OF STEEL BAR REINFORCEMENT SHALL BE AS FOLLOWS:

MILD STEEL PLAIN BAR	250 N/mm ²
HIGH TENSILE TYPE II DEFORMED BAR	460 N/mm ²

12.25 REINFORCEMENT ANCHORAGE OR LAPPING IS AS FOLLOWS U.N.O.

	BAR GRADE 415
TENSION	450
COMPRESSION	450

Ø IS DIAMETER OF THE SMALLER SIZED LAPPED BAR.

- NO SPLICE SHALL BE MADE AT POINT OF MAXIMUM STRESS, EG IN BEAMS AND SLABS, THERE SHALL BE NO SPLICING OF TOP BARS OVER SUPPORTS NOR BOTTOM BARS AT MID-SPANS. SPLICES SHALL BE STAGGERED WHEREVER POSSIBLE. LAP LENGTH FOR UNEQUAL SIZE BARS (OR WIRES IN FABRIC) MAY BE BASED UPON THE SMALLER BAR. FOR BUNDLED BARS, THE EQUIVALENT DIAMETER SHALL BE USED. CRANKING OF BARS SHALL NOT EXCEED A SLOPE OF 1:10.
- FOR LAP LENGTH, WHERE SYMBOLS ARE NOT INDICATED, THE TENSION LAP LENGTH SHALL BE FOLLOWED.

13.0 STIRRUPS, LINKS AND TIES

- ALL STIRRUPS, LINKS AND TIES IN BEAMS, COLUMNS AND WALLS RESPECTIVELY SHALL TERMINATE NOT MORE THAN 75mm FROM THE FACE OF ANY ADJACENT STRUCTURAL MEMBERS.

14.0 SLAB DISTRIBUTION BARS

- REGARDLESS OF WHETHER OR NOT SHOWN ON PLAN, ALL DISTRIBUTION BARS FOR SLAB SHALL COMPRISE TYPICALLY ONE OF THE FOLLOWING COMBINATIONS, UNLESS OTHERWISE STATED IN THE RELEVANT DRAWINGS :



SLAB THICKNESS (mm)	MIN. DISTRIBUTION BAR
250 OR LESS	T10-300
GREATER THAN 250 BUT LESS THAN OR EQUAL TO 300	T10-200
GREATER THAN 300 BUT LESS THAN OR EQUAL TO 400	T10-150

15.0 FLOOR RENDERING

- THICKNESS OF SCREED RENDERING/MASS CONCRETE TOPPING EXCEEDING 60 OR MORE SHALL BE REINFORCED WITH ONE LAYER OF R6.

16.0 SHRINKAGE CRACKS

- THE SURFACE OF CONCRETE SHALL BE ADEQUATELY AND CONTINUOUSLY CURED TO SPECIFICATION TO PREVENT FORMATION OF SHRINKAGE CRACKS. THOUGH SHRINKAGE CRACKS HAVE NO EFFECT ON THE STRENGTH AND INTEGRITY OF THE STRUCTURE, THEY SHOULD BE SEALED BY EPOXY PRESSURE GROUTING. ALL COST INCURRED FOR THE NECESSARY SEALING UP OF SHRINKAGE CRACKS BY EPOXY PRESSURE GROUTING SHALL BE DEEMED TO BE INCLUDED IN THE CONCRETE WORK AS TENDERED.

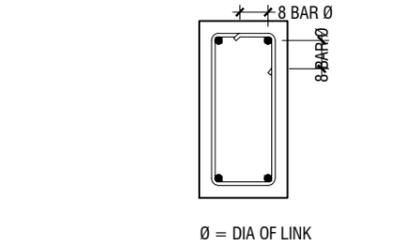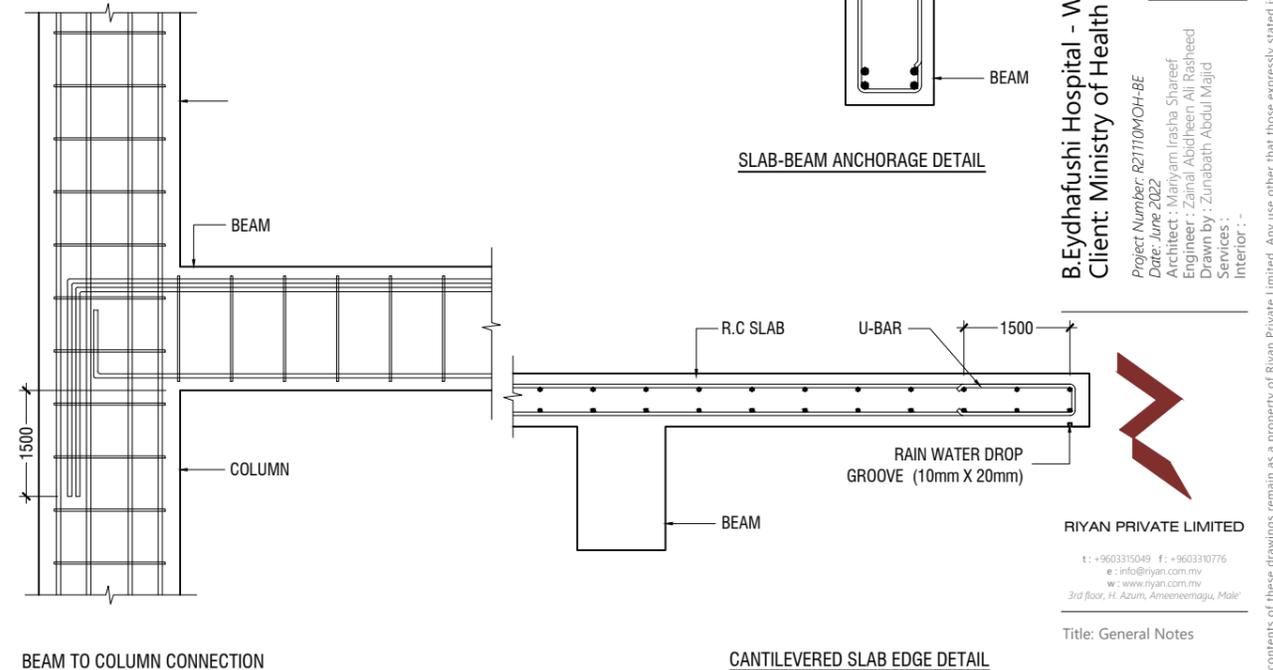

SLAB-BEAM ANCHORAGE DETAIL

B.Eydhafushi Hospital - Waste Management Block
Client: Ministry of Health

Project Number: R2110M0H-0E
 Date: June 2022
 Architect: Maryam Iracha Shareef
 Engineer: Zainal Abidheem Ali Rasheed
 Drawn by: Zunabath Abdul Mojid
 Services: Interior
 Rev no: _____ Date: _____

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Title: General Notes

Page: S-01 / 09

19.0 STRUCTURAL TIMBER SPECIFICATION

19.1 THE CONTRACT STRUCTURAL DRAWINGS AND SPECIFICATIONS REPRESENT THE COMPLETED STRUCTURE, AND ARE NOT INTENDED TO INDICATE THE METHOD OR MEANS OF CONSTRUCTION. THE CONTRACTOR SHALL SUPERVISE AND DIRECT THE WORK AND SHALL BE SOLELY RESPONSIBLE FOR ALL CONSTRUCTION MEANS, METHODS, PROCEDURES, TECHNIQUES, SEQUENCES, AND FOR JOB SAFETY.


19.2 THE ENGINEER DOES NOT HAVE CONTROL OR CHARGE OF, AND SHALL NOT BE RESPONSIBLE FOR, CONSTRUCTION MEANS, METHODS, TECHNIQUES, SEQUENCES, OR PROCEDURES, FOR SAFETY PRECAUTIONS AND PROGRAMS IN CONNECTION WITH THE WORK, FOR THE ACTS OR OMISSIONS OF THE CONTRACTOR, SUBCONTRACTOR, OR ANY OTHER PERSONS PERFORMING ANY OF THE WORK, OR FOR THE FAILURE OF ANY OF THEM TO CARRY OUT THE WORK IN ACCORDANCE WITH THE CONTRACT DOCUMENTS.

19.3 ALL CONSTRUCTION IS IN COMPLIANCE WITH THE CONSTRUCTION DOCUMENTS. THE GENERAL CONTRACTOR SHALL BE RESPONSIBLE FOR PERFORMING ALL WORK IN COMPLIANCE WITH THE CONSTRUCTION DOCUMENTS.

19.4 ALL TIMBER FOR STRUCTURAL USE SHALL BE HARDWOOD OR SOFTWOOD OF VISUAL GRADE C/D IN ACCORDANCE WITH BS 5756 WITH THE FOLLOWING MINIMUM GRADE STRESSES:

19.5 CONNECTIONS
 PLATES - STAINLESS STEEL GRADE 316 OF STATED THICKNESS
 BOLTS - SS GRADE 316

19.6 TIMBER TREATMENT
 MOISTURE - PRESSURE IMPREGNATION OF CCA
 INSECTS - TERMITE TREATMENT FOR TIMBER IN / NEAR GROUND

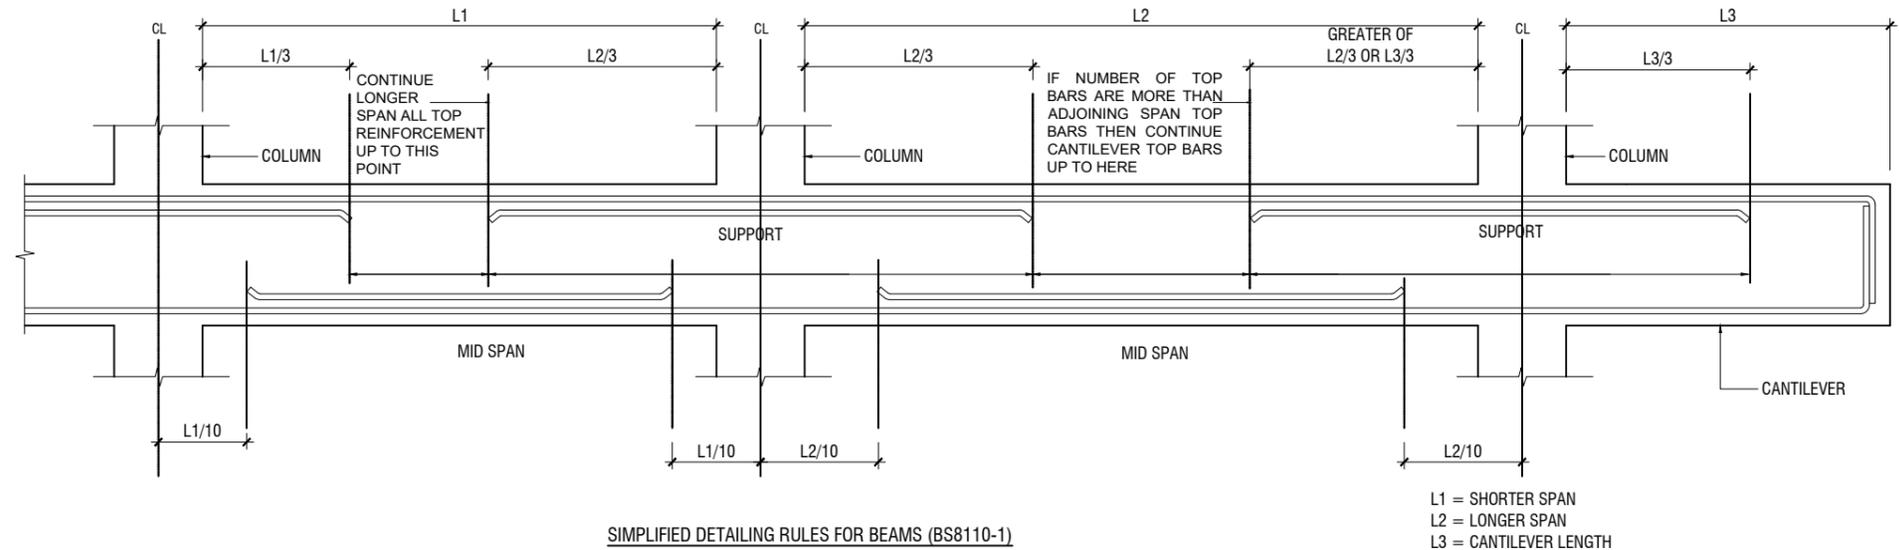



20.0 STRUCTURAL STEEL SPECIFICATION

1. SEE 21.0 ON PRIMARY CODES AND SPECIFICATIONS.

2. MATERIALS:

- W-SHAPES & WT-SHAPES..... ASTM A992
- S-SHAPES, M-SHAPES, HP-SHAPES..... ASTM A36
- ST-SHAPES & MT-SHAPES..... ASTM A36
- C-SHAPES & MC-SHAPES..... ASTM A36
- ANGLES & PLATES..... ASTM A36
- HSS SHAPES..... ASTM A500, GRADE B
- STEEL PIPE..... ASTM A53 (TYPE E OR S), GRADE B
- HIGH STRENGTH BOLTS..... ASTM A325
- MACHINE BOLTS..... ASTM A307
- ANCHOR RODS..... ASTM F1554, GRADE 55 TYPE S1 (UNO)
- WELDED HEADED STUDS..... ASTM A108
- DEFORMED BAR ANCHORS..... ASTM A496
- WELDING ELECTRODES..... AWS D1.1, E70 SERIES

3. NON-SHRINK, NON-METALLIC GROUT WITH A 28 DAY STRENGTH OF 35MPa SHALL BE USED UNDER BASE PLATES AND SHALL CONFORM TO BS EN 12390-3 AND EN 196-1. MASTERFLOW 542 OR EQUIVALENT MAYBE USED.

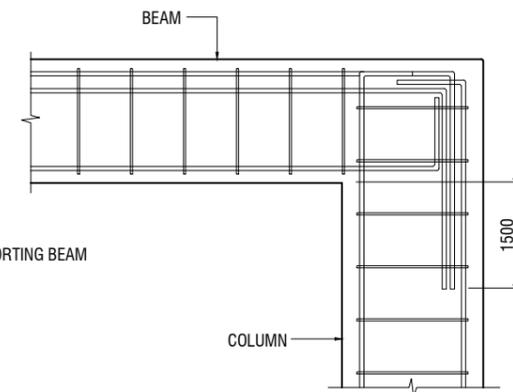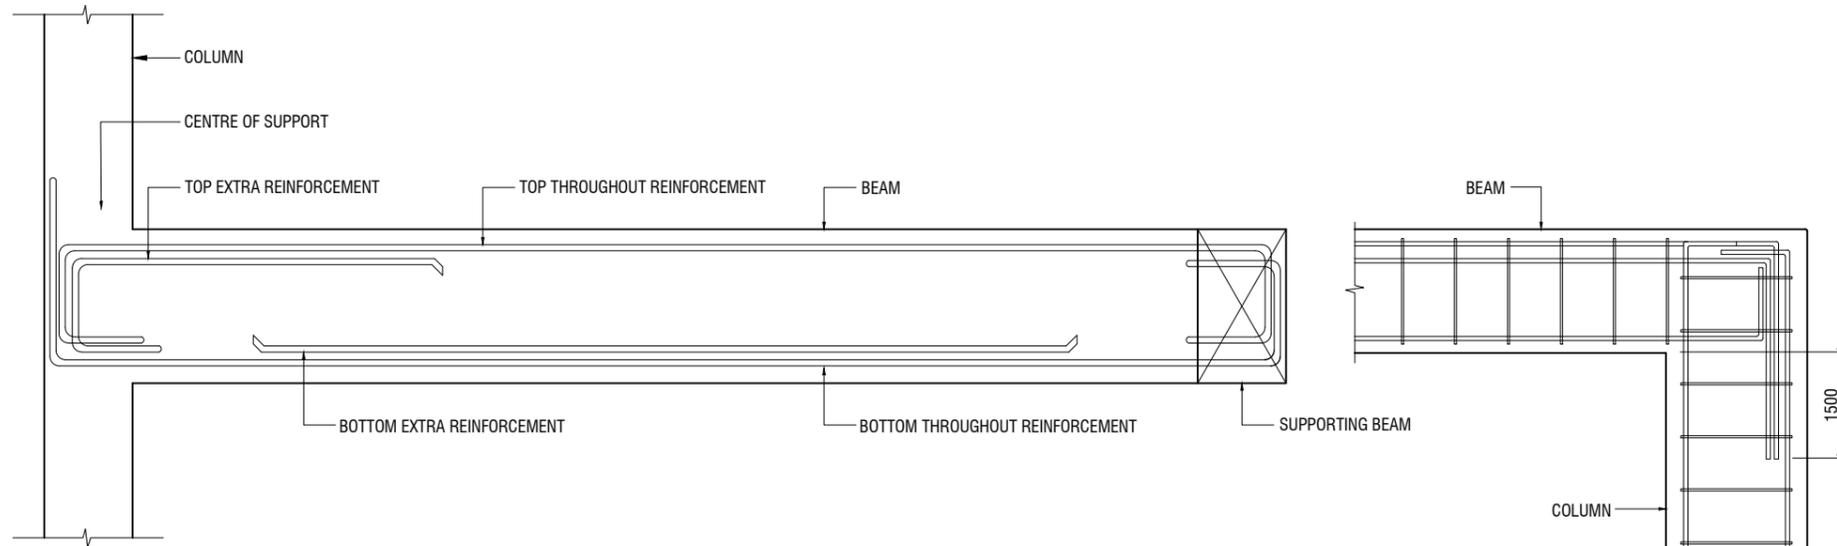

NOTE:
 STANDARD DETAILS GIVEN HERE ALSO APPLIES TO FOUNDATION MEMBERS
 OTHER DETAILS NOT FOUND HERE SHALL BE REFERRED TO IN RELEVANT BS
 CODES OR SHALL BE APPROVED BY CLIENT'S ENGINEER

23.0 POST-INSTALLED ANCHORS

1. POST-INSTALLED ANCHORS SHALL ONLY BE USED WHERE SPECIFIED ON THE DRAWINGS. CONTRACTOR SHALL OBTAIN APPROVAL FROM ENGINEER OF RECORD (EOR) PRIOR TO USING POST-INSTALLED ANCHORS FOR MISSINGS OR MISPLACED ANCHORS.

2. CARE SHALL BE GIVEN TO AVOID CONFLICTS WITH EXISTING REINFORCING WHEN DRILLING HOLES. HOLES SHALL BE DRILLED AND CLEANED PER THE MANUFACTURER'S INSTRUCTIONS. ANCHORS SHALL BE INSTALLED PER THE MANUFACTURER'S INSTALLATION INSTRUCTIONS AT NOT LESS THAN MINIMUM EDGE DISTANCES AND/OR SPACINGS INDICATED IN THE MANUFACTURER'S LITERATURE.

3. SPECIAL INSPECTION SHALL BE PROVIDED FOR ALL ADHESIVE AND MECHANICAL ANCHOR INSTALLATIONS AS REQUIRED BY THE EOR. INDEPENDENT ON-SITE PROOF LOAD TESTING SHALL BE PERFORMED AS REQUIRED BY THE EOR. CONTACT EOR FOR NUMBER OF ANCHORS REQUIRED TO BE TESTED AND REQUIRED PROOF LOAD MAGNITUDE.

B.Eydhafushi Hospital - Waste Management Block
Client: Ministry of Health

Project Number: R2110M0H-BE	Rev no	Date
Date: June 2022		
Architect: Maryam Irachha Shareef		
Engineer: Zainal Abidheem Ali Rasheed		
Drawn by: Zunabath Abdul Mujid		
Services: Interior		




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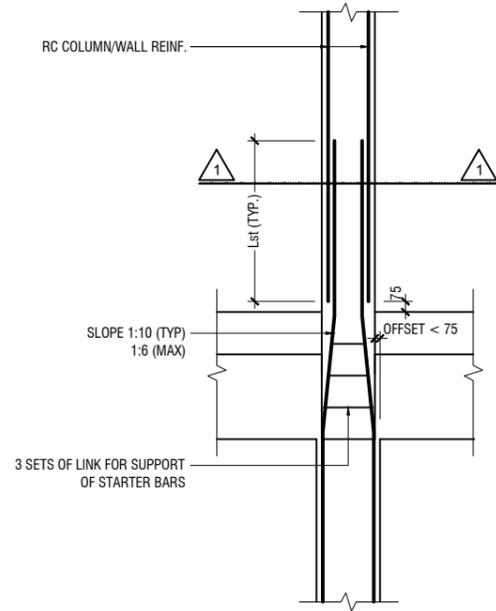
Title: General Notes

Page: S-02 / 09

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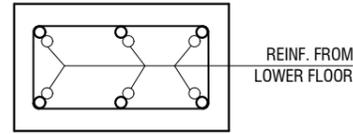


A) FOR COLUMN OFFSET > 75mm
TO BE VERIFIED BY THE CONSULTING ENGINEER

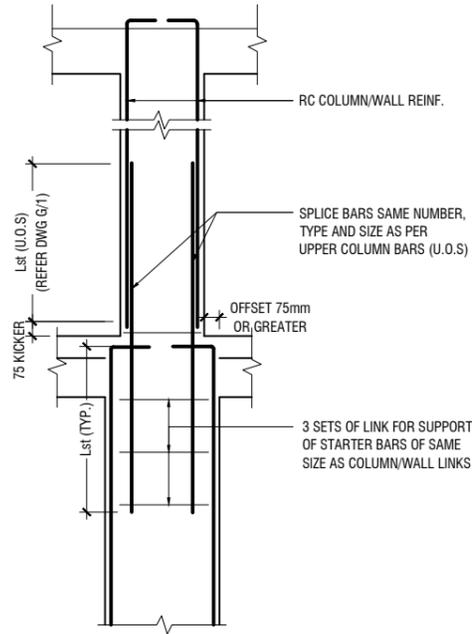


B) FOR COLUMN OFFSET < 75mm


COLUMN/WALL REINF. LAPPING DETAIL AT FLOOR LEVEL



SECTION-1-1

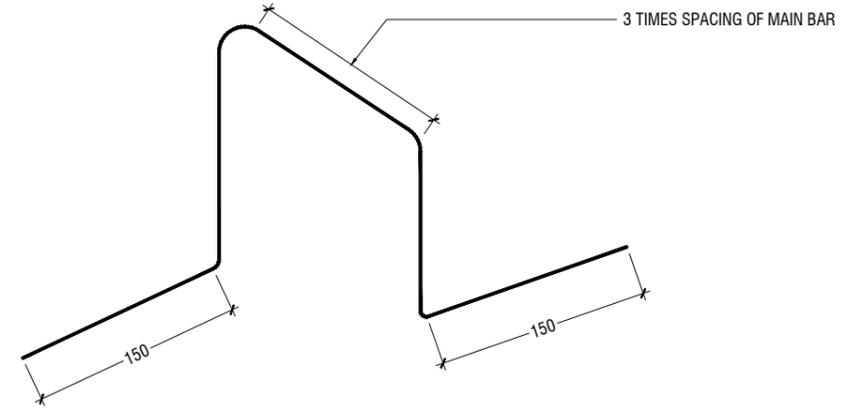

TYPICAL CHAIR DETAIL

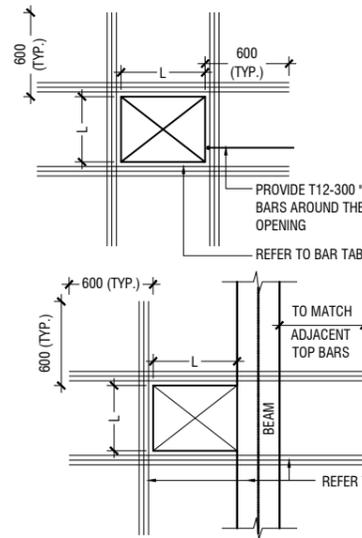


FLOOR OPENING (L)	ADD BARS
LESS THAN 250	3T12 T & B
L = > 250 < 500	3T16 T & B
L = ≥ 500 < 1000	3T16 T & B


NOTE:-

1. FOR OPENINGS LESS THAN 200x200. SLAB REBARS TO BE ADJUSTED AROUND OPENING.
2. FOR OPENINGS GREATER THAN 250x250 TO BE APPROVED BY THE ENGINEER.
3. ALL SLAB OPENINGS LOCATION TO BE APPROVED BY THE ENGINEER.
4. EQUIVALENT OPENING AREA SHALL APPLY THE DETAILS SHOWN ABOVE.
5. EQUIVALENT OPENING AREA SHALL INCLUDE RECTANGLE, TRIANGLE AND ANY POLYGON SHAPE.
6. EXCEPT HACKING, NO SLAB CORING ARE ADVISABLE FOR POST-TENSIONED SLAB.


TYPICAL TRIMMER BARS DETAILS FOR OPENING IN SLABS

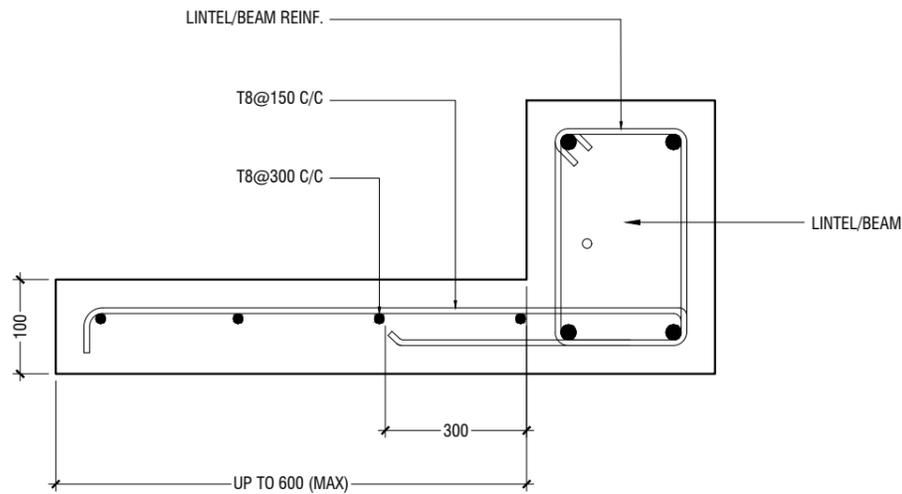

TYPICAL CANTILEVER DETAILS

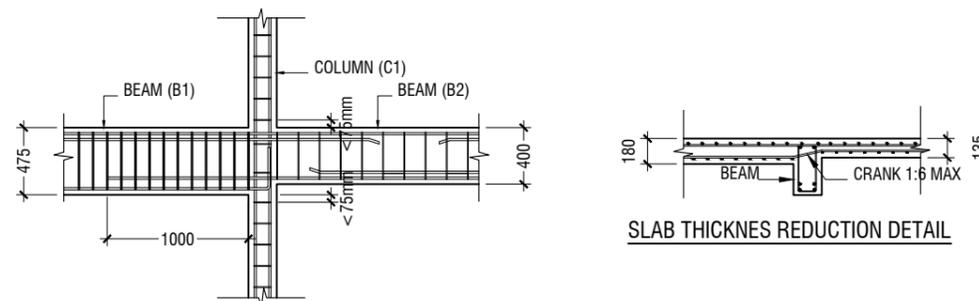

B1 TO B2 CONNECTION DETAILS

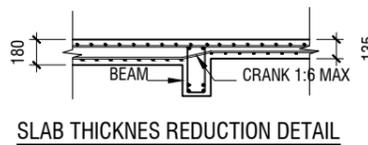

SLAB THICKNES REDUCTION DETAIL

B.Eydhafushi Hospital - Waste Management Block
Client: Ministry of Health

Project Number: R2110M04-BE	Rev no	Date
Date: June 2022	1	
Architect: Maryam Iracha Shareef	2	
Engineer: Zainal Abidin Ali Rasheed	3	
Drawn by: Zunabath Abdul Majid	4	
Services: Interior	5	




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Title: General Notes

Page: S-03 / 09

**WASTE MANAGEMENT BLOCK
COLUMN LAYOUT PLAN**

SCALE 1:100

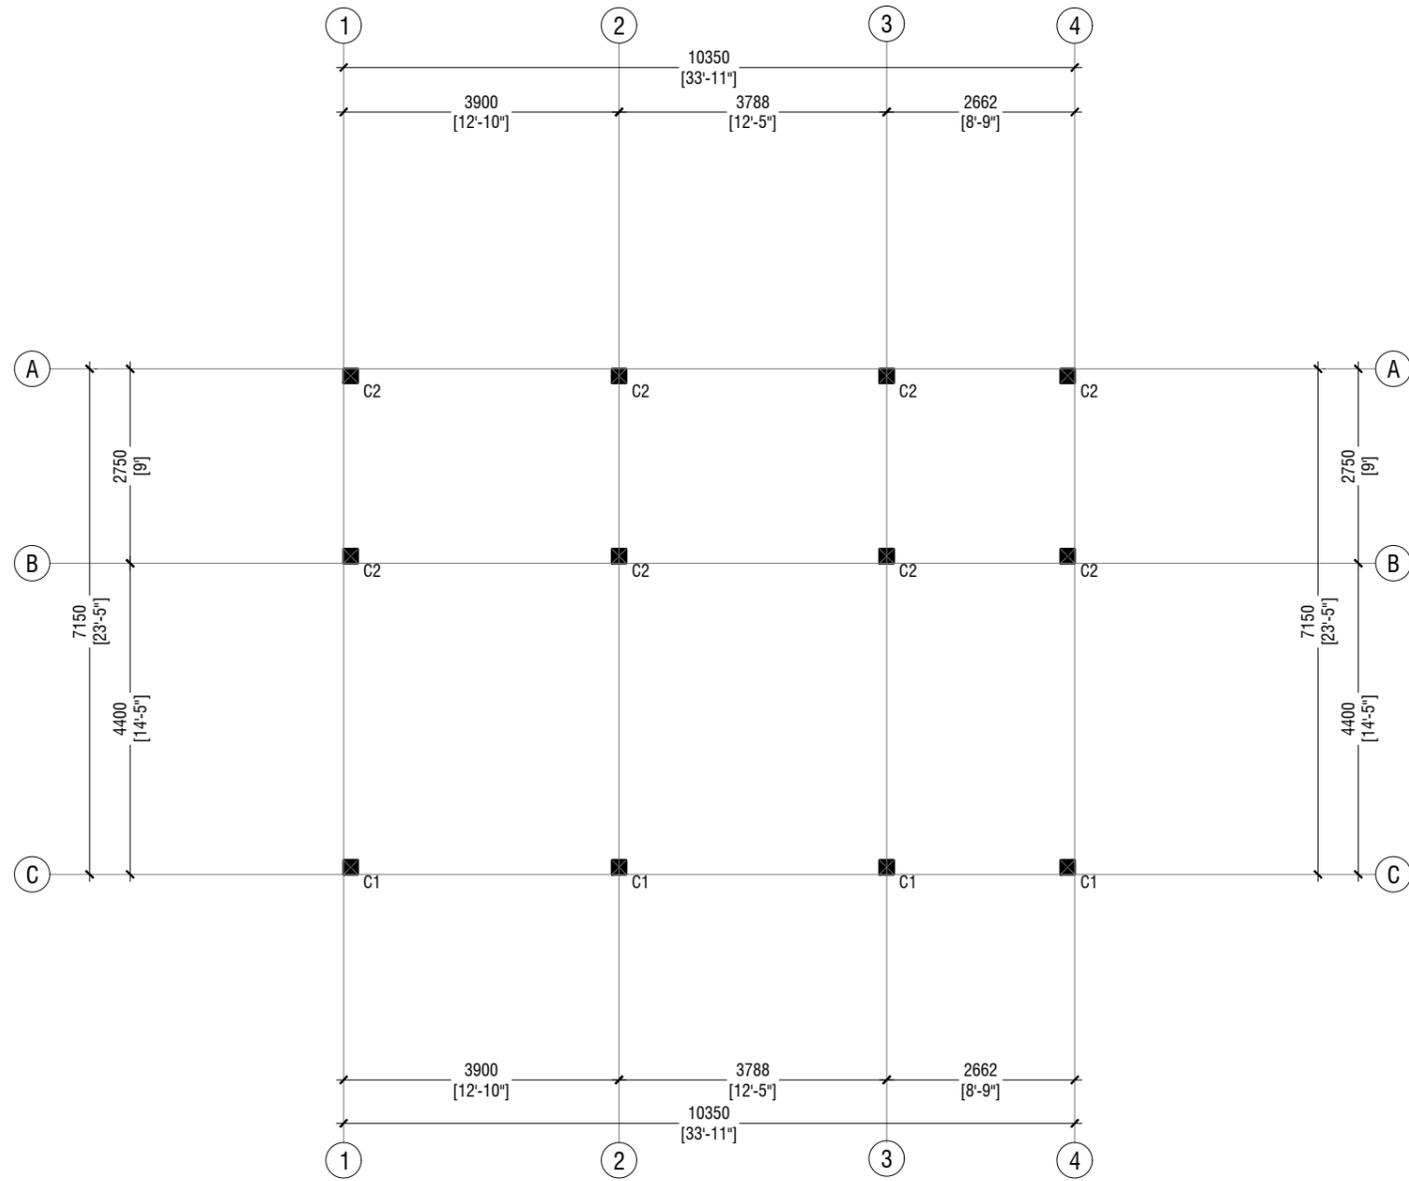

NOTE:

COLUMN SIZES

- C1 : 200 x 200 mm
- C2 : 200 x 200 mm
- COVER : 40mm

B.Eydhafushi Hospital - Waste Management Block
Client: Ministry of Health

Rev no	Date

Project Number: R2110MOH-BE
 Date: June 2022
 Architect: Mariyam Irasha Shareef
 Engineer: Zainal Abidheen Ali Rasheed
 Drawn by: Zunabath Abdul Majid
 Services: Interior



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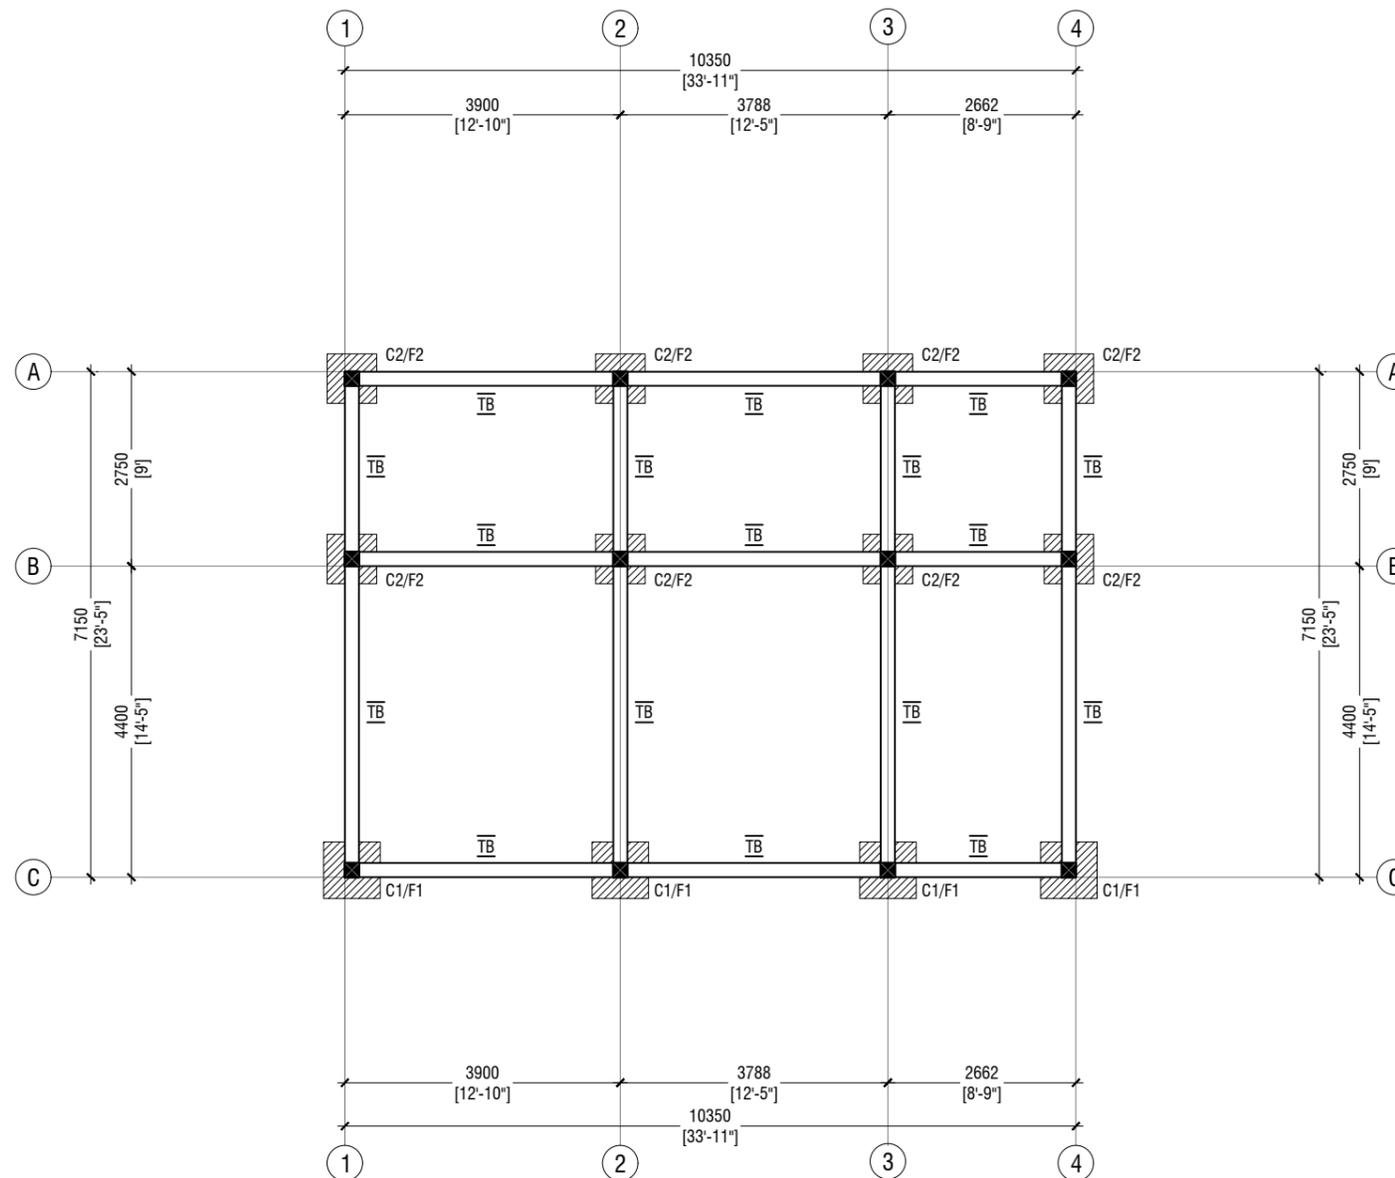
Title: Column Layout
 Plan

Page: S-04 / 09

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**WASTE MANAGEMENT BLOCK
FOUNDATION LAYOUT PLAN**

SCALE 1:100



NOTE:

COLUMN SIZES

C1	: 200 x 200 mm
C2	: 200 x 200 mm
COVER	: 40mm

FOUNDATION PAD SIZES

	DIMENSION	REINFORCEMENT
F1	800 x 800 x 250	T12@150 C/C BW (BOTTOM ONLY)
F2	700 x 700 x 250	T12@150 C/C BW (BOTTOM ONLY)

CONCRETE COVER

COLUMN	: 40mm
SLAB	: 30mm
BEAM	: 35mm
FOOTING	: 50mm
TIE BEAM	: 50mm

LAP LENGTH FOR BARS

25MM	: 1125 mm
20MM	: 900 mm
16MM	: 720 mm
12MM	: 550 mm
10MM	: 450 mm

CONCRETE GRADE = M25

SAFE BEARING CAPACITY = 150KPa

HOOK LENGTH AND OTHER DETAILS ARE PROVIDED IN GENERAL NOTES

FOUNDATION DEPTH : 900mm BELOW GROUND LEVEL

ALL FOOTINGS ARE TO BE LAID ON TOP OF 50mm THICK LEAN CONCRETE

TIE BEAM SIZES

TB	: 200 x 350 mm
COVER	: 50mm

GROUND SLAB : 100mm THK RC SLAB ON FILL
REINFORCED WITH R6@150 C/C BW
SINGLE LAYER

B.Eydhafushi Hospital - Waste Management Block
Client: Ministry of Health

Project Number: R2110M0H-BE	Rev no	Date
Date: June 2022	1	
Architect: Maryam Irasha Shareef	2	
Engineer: Zainal Abidin Ali Rasheed	3	
Drawn by: Zunabath AbdulMajid	4	
Services: Interior	5	



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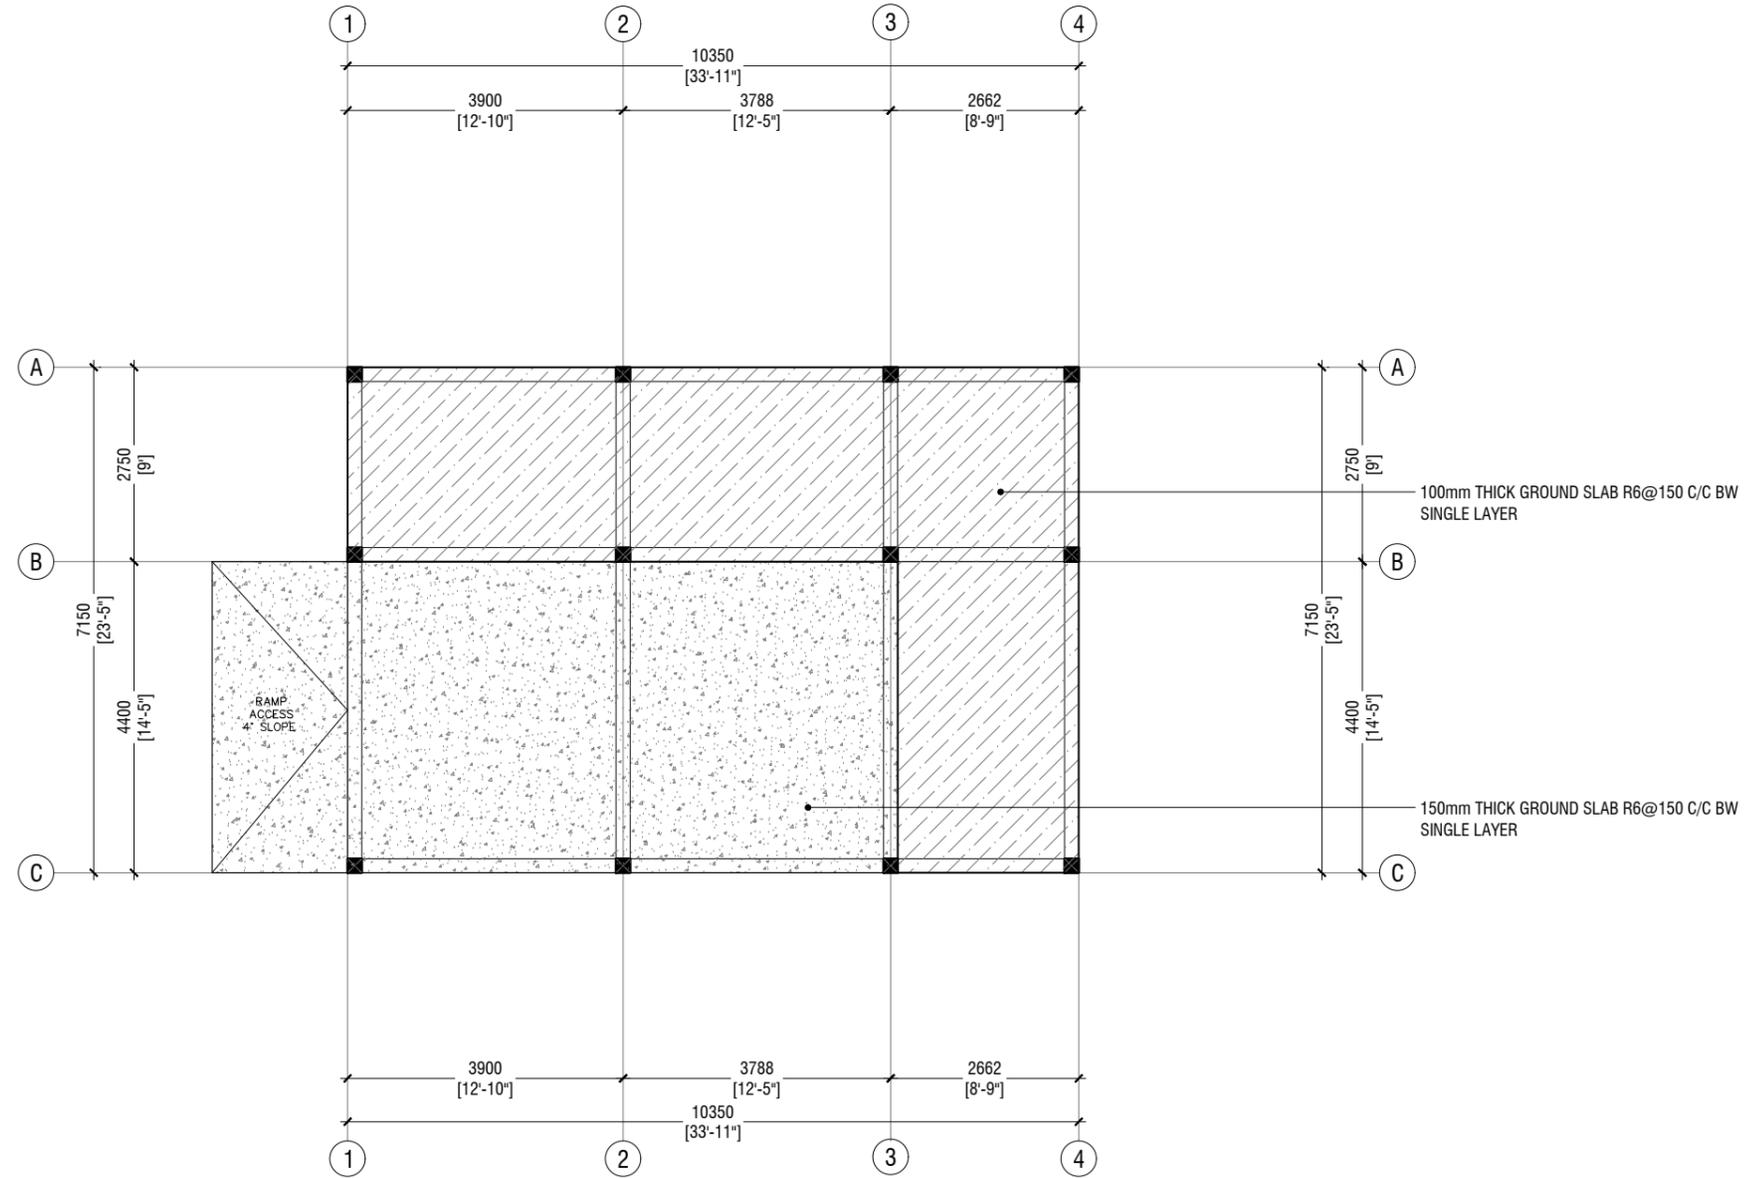
Title: Foundation Plan

Page: S-05 / 09



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**WASTE MANAGEMENT BLOCK
GROUND SLAB PLAN**

SCALE 1:100



NOTES

-  100mm THICK GROUND SLAB R6@150 C/C BW SINGLE LAYER
-  150mm THICK GROUND SLAB R6@150 C/C BW SINGLE LAYER

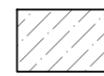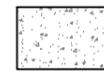B.Eydhafushi Hospital - Waste Management Block
Client: Ministry of Health

Rev no	Date
1	
2	
3	
4	

Project Number: R2110M0H-BE
 Date: June 2022
 Architect: Maryam Irasha Shareef
 Engineer: Zainal Abidheen Ali Rasheed
 Drawn by: Zunabath Abdul Majid
 Services: Interior



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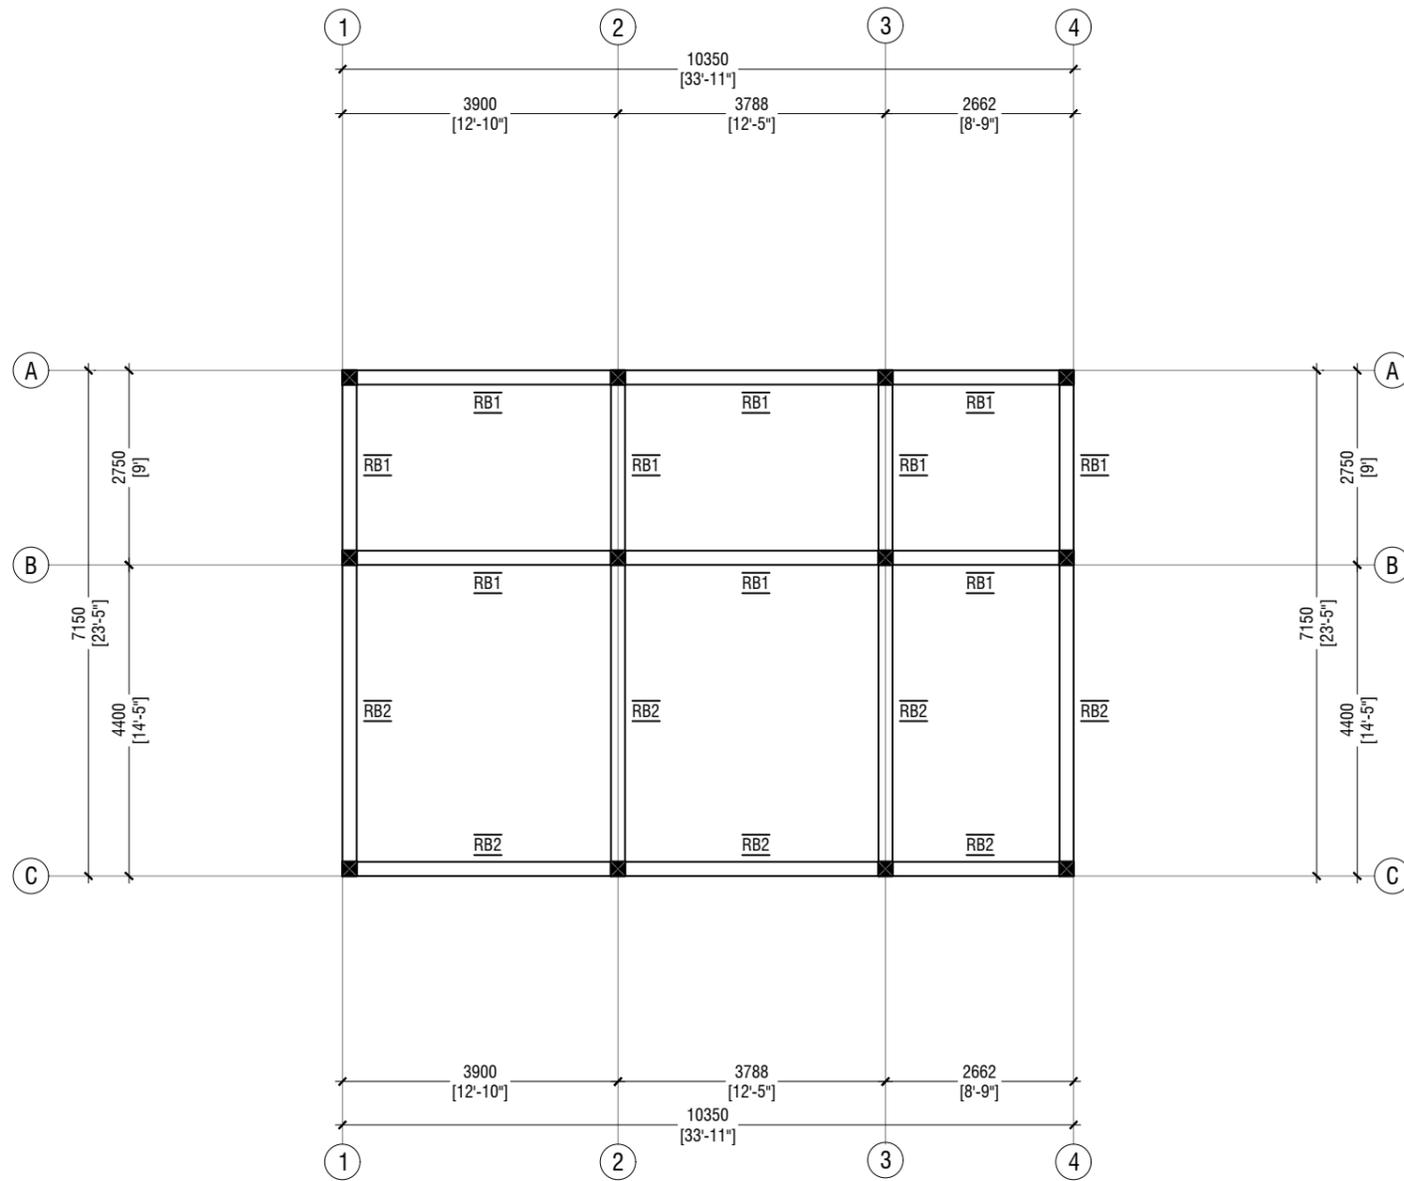
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Title: Ground Slab Plan

Page: S-06 / 09

**WASTE MANAGEMENT BLOCK
ROOF BEAM PLAN**

SCALE 1:100



NOTE:

BEAM SIZES

- RB1 : 200x200 mm
- RB2 : 200x200 mm
- COVER : 35mm

B.Eydhafushi Hospital - Waste Management Block
Client: Ministry of Health

Rev no	Date

Project Number: R2110M0H-BE
Date: June 2022
Architect: Maryam Irasha Shareef
Engineer: Zainal Abidheen Ali Rasheed
Drawn by: Zunabath AbdulMajid
Services: Interior



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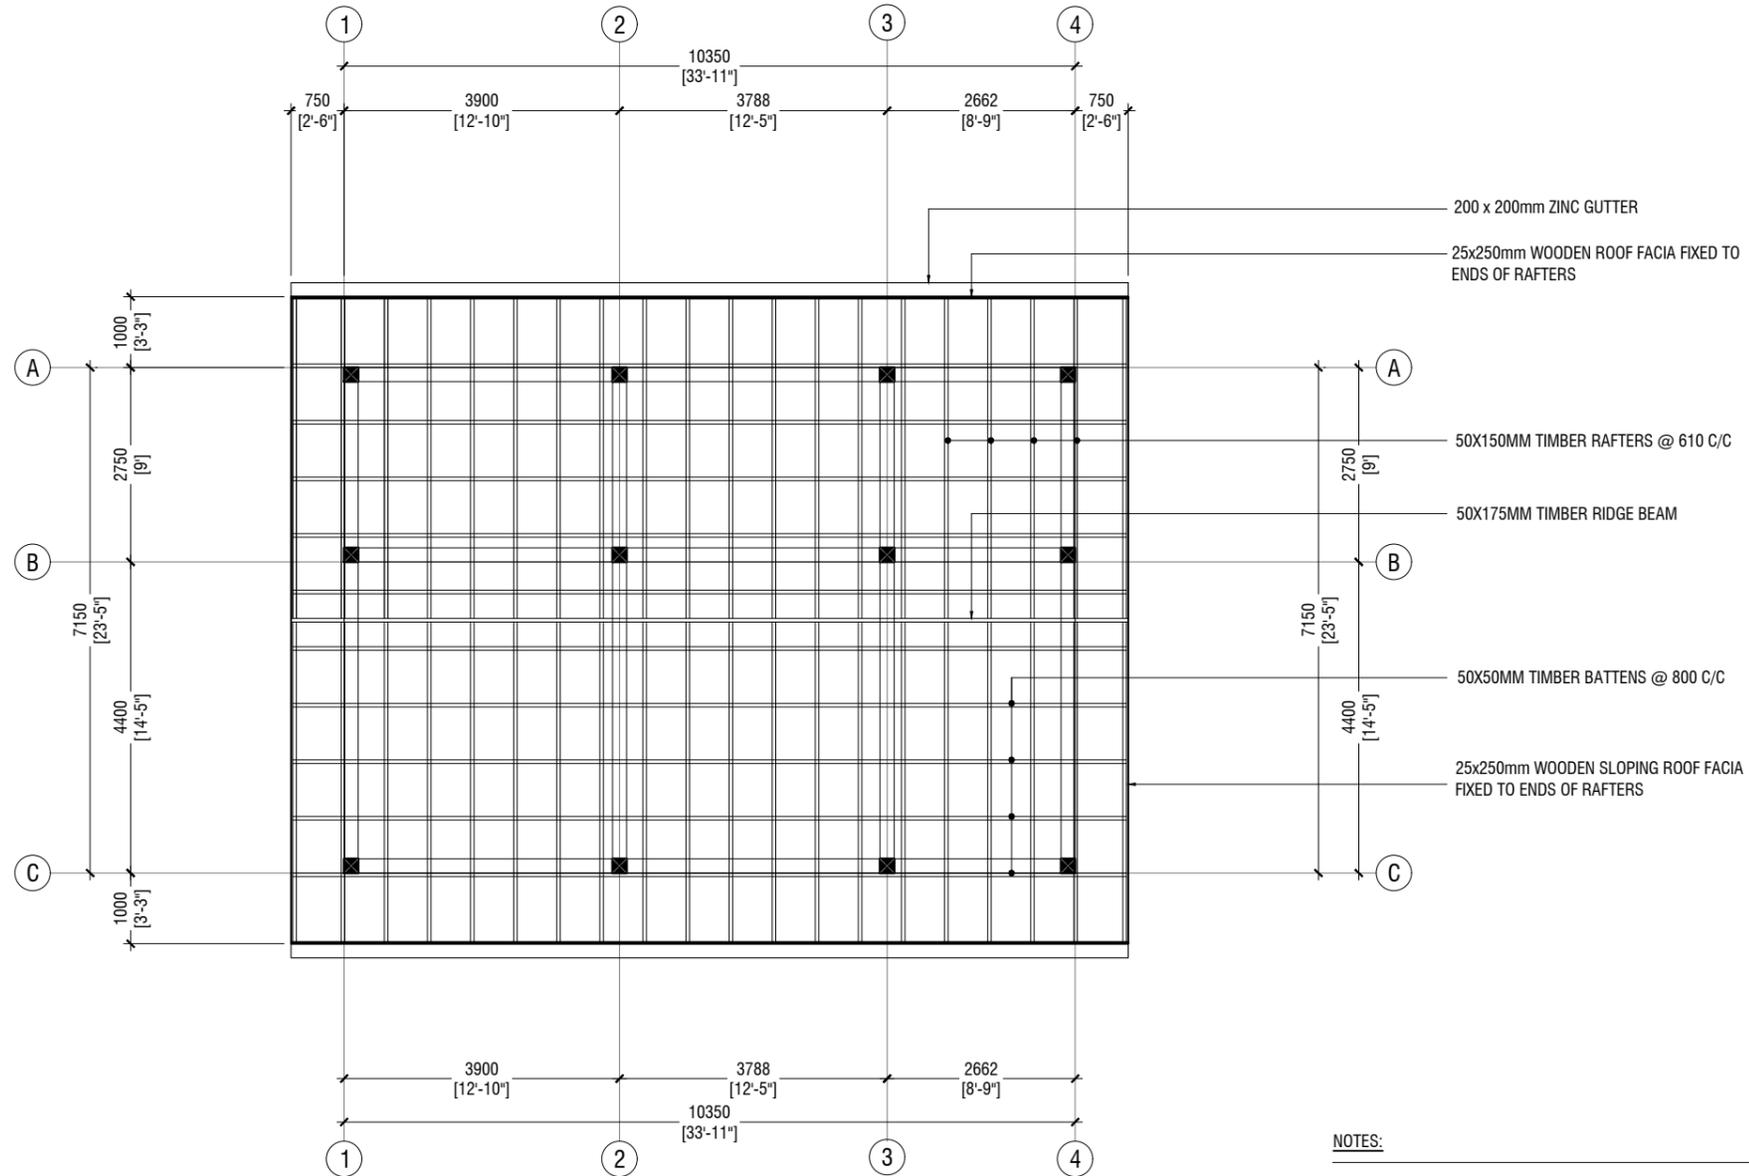
Title: Roof Beam Plan

Page: S-07 / 09

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**WASTE MANAGEMENT BLOCK
ROOF FRAMING PLAN**

SCALE 1:100



NOTES:

ROOF SLOPE IS 10 DEGREES TO THE HORIZONTAL
ROOF FABRIC IS LYSAGHT ROOFING SHEETS

ROOF STRUCTURE DETAILS :

- 50X175MM TIMBER RIDGE BEAM
- 50X150MM TIMBER RAFTERS @ 610 C/C
- 50X50MM TIMBER BATTENS @ 800 C/C
- 25x250mm WOODEN ROOF FACIA FIXED TO ENDS OF RAFTERS
- 70x100mm WOODEN WALL PLATE BOLTED TO RAFTERS & ROOF BEAM @ 600 CC

B.Eydhafushi Hospital - Waste Management Block
Client: Ministry of Health

Rev no	Date
1	
2	
3	
4	

Project Number: R2110M0H-BE
Date: June 2022
Architect: Maryam Irasha Shareef
Engineer: Zainal Abidheem Ali Rasheed
Drawn by: Zunabath AbdulMajid
Services: Interior



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Title: Roof Framing Plan

Page: S-08 / 09

FOUNDATION PAD SIZES


	DIMENSION (LXBXD)	REINFORCEMENT
F1	800 x 800 x 250	T12@150 C/C BW (BOTTOM ONLY)
F2	700 x 700 x 250	T12@150 C/C BW (BOTTOM ONLY)

FOUNDATION DEPTH = 900mm

NOTE:-
 COVER TO FOUNDATION = 50mm
 COVER TO COLUMNS = 40mm
 COVER TO BEAMS = 35mm
 LAPS = Ø OF BAR x 45
 BEAMS @END SUPPORT = Ø OF BAR x 12



CONCRETE GRADE = M25

FOUNDATION PADS

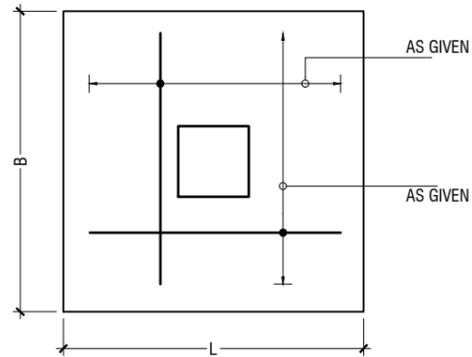


PLAN


**WASTE MANAGEMENT BLOCK
STRUCTURAL DETAILS**

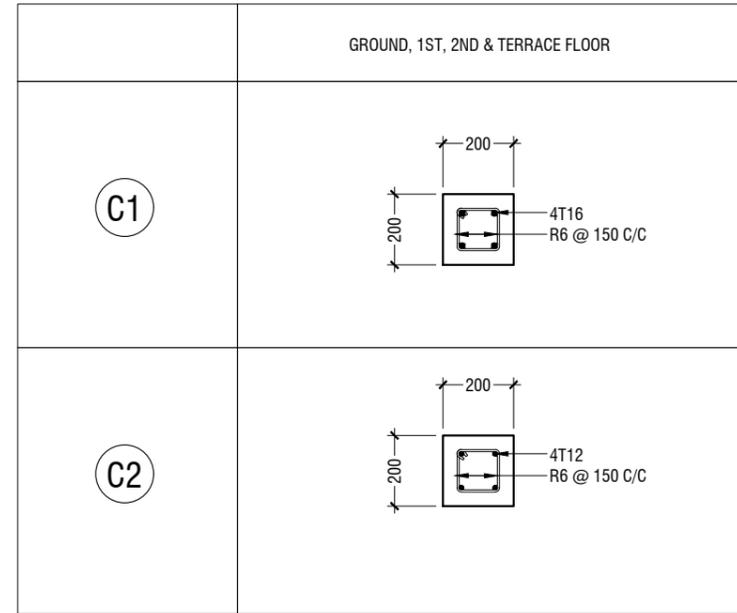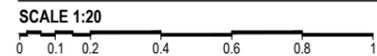


COLUMN DETAILS

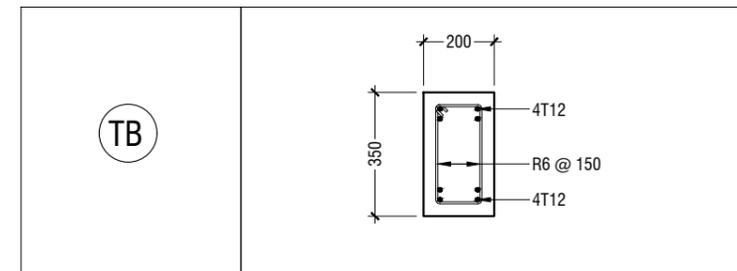

FOUNDATION DETAILS

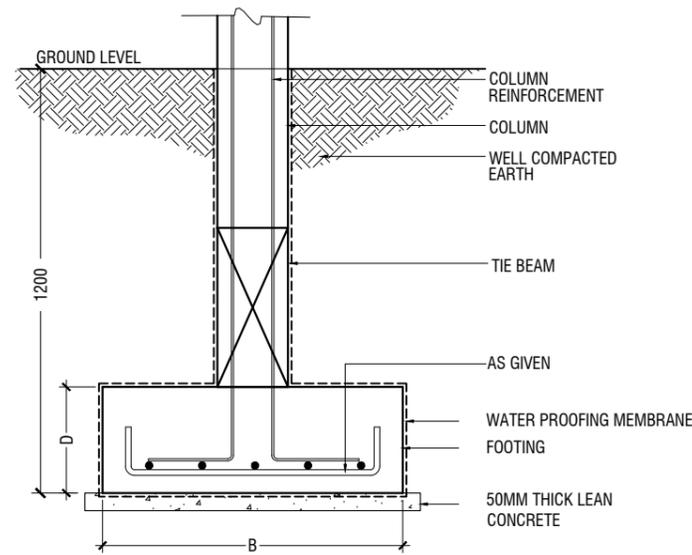

TYPICAL FOOTING SECTION

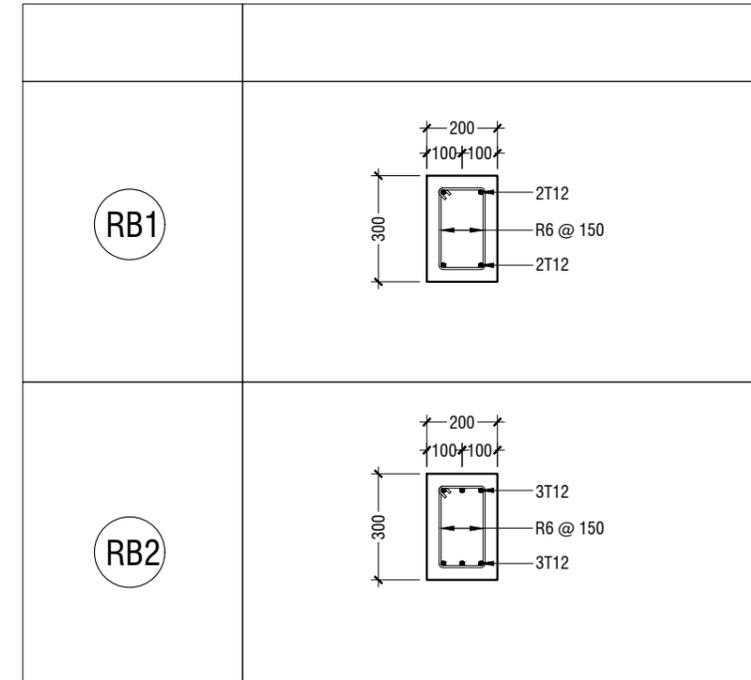

BEAM DETAIL

B.Eydhafushi Hospital - Waste Management Block
Client: Ministry of Health

Rev no	Date
1	
2	
3	
4	

Project Number: R2110M0H-BE
 Date: June 2022
 Architect: Maryam Irasha Shareef
 Engineer: Zainal Abidin Ali Rasheed
 Drawn by: Zunabath Abdul Majid
 Services: Interior



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Title: Structural Details

Page: S-09 / 09

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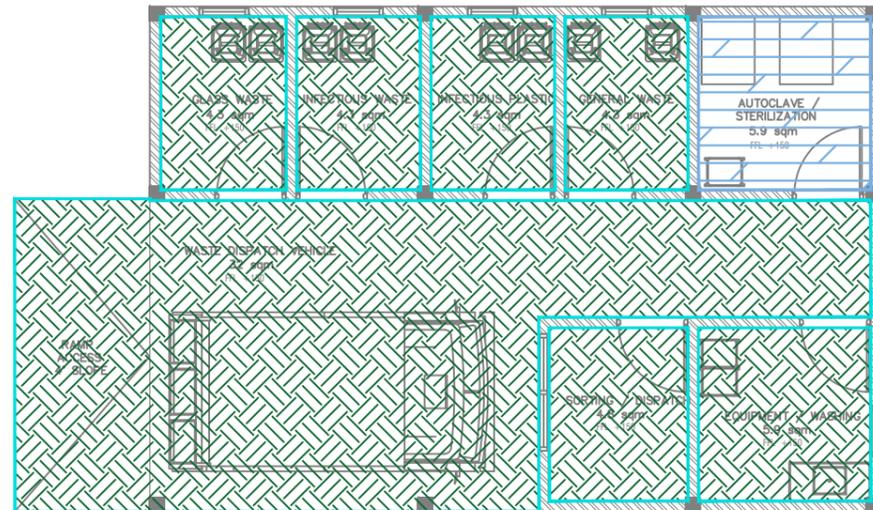
B.EYDHAFUSHI HOSPITAL
SERVICES PLOT _ WASTE MANAGEMENT BLOCK
CLIENT: MINISTRY OF HEALTH

FINISHES LAYOUT




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LEGEND:

Code	Description
FF01	 1200mmX1200mm Polished Porcelain Floor Tile
FF02	 1200mmX1200mm Semi Polished Porcelain Floor Tile
FF03	 800mmX800mm Semi Polished Porcelain Floor Tile
FF04	 600mmX600mm Matte Ceramic Floor Tile
FF05	 600mmX600mm Matte Ceramic Outdoor Floor Tile
FF06	 600mmX600mm Matte Ceramic Floor Tile
FF07	 300mmX1200mm Matte Ceramic Staircase Floor Tile with grooves
FF08	 Homogeneous Vinyl Flooring For Sterile Area - Supplier Should recommend Technical Specification
FF09	 Permanently Static Dissipative Pressed Homogeneous Vinyl Flooring For Sterile Area - Supplier Should recommend Technical Specification
FF10	 Paver Block
FF11	 Gray Epoxy Paint finish over leveling Screed

**WASTE MANAGEMENT BLOCK
FLOOR FINISHES LAYOUT**

SCALE 1:100

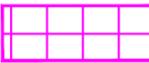


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B.Eydhafushi Hospital - Waste Management Block
Client: Ministry of Health

Project Number: R21110MOH-BE
Date: June 2022
Architect : Mariyam Irasha Shareef
Engineer : Zainal Abidheen Ali Rasheed
Drawn by : Zunabath Abdul Majid
Services :
Interior : -

Rev no	Date	Title
--	-----	Title: Ground Floor, Floor Finishes Layout
--	-----	Page: F-01 / 03



LEGEND:

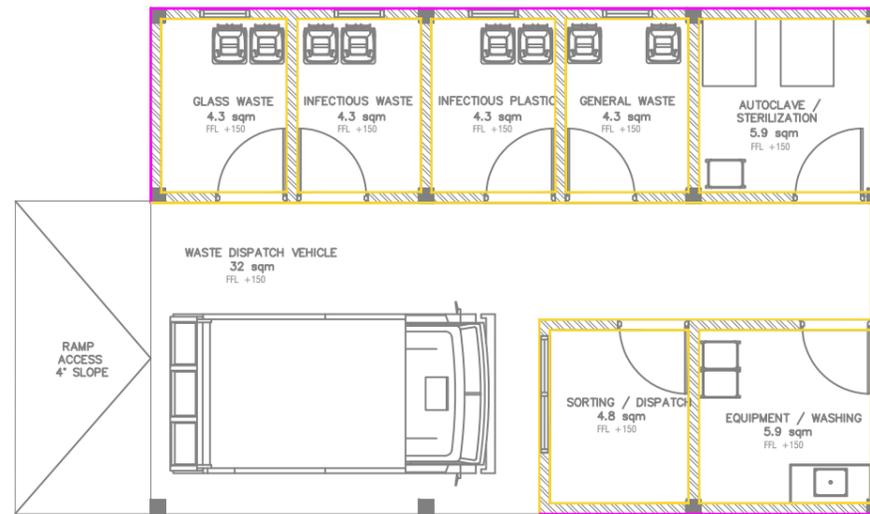Code	Description	
WF01		Exterior Grade Paint Finish
WF02		Vinyl Wall Covering to 2100mm height with Washable Paint Finish above
WF03		300mmX600mm Matte Homogenous Wall Tile upto ceiling
WF04		Wash and Wear Low Sheen Emulsion Paint
WF05		PVC Hygienic Protective Cladding

**WASTE MANAGEMENT BLOCK
WALL FINISHES LAYOUT**

SCALE 1:100



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w: www.riyan.com.mv
3rd floor, H. Azum, Ameenemogai, Male'

B.Eydhafushi Hospital - Waste Management Block
Client: Ministry of Health

Project Number: R21110MOH-BE

Date: June 2022

Architect: Mariyam Irasha Shareef

Engineer: Zainal Abidheen Ali Rasheed

Drawn by: Zunabath Abdul Majid

Services:

Interior: -

Rev no Date


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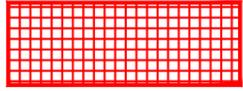
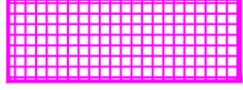
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Title: Ground Floor, Wall
Finishes Layout

Page: F-02 / 03



LEGEND:

Code	Description	
CF01	 FALSE FLAT CEILING WITH 12mm CALCIUM SILICATE BOARD UNDER 50x50mm CEILING JOIST WITH ANTI MICROBIAL PAINT COATINGS	
CF02	 FALSE FLAT CEILING WITH 12mm THICK GYPSUM BOARD UNDER 50x50mm CEILING JOIST WITH ANTI MICROBIAL PAINT COATING	
CF03	 FALSE SLOPING CEILING WITH 12mm THICK GYPSUM BOARD UNDER 50x50mm CEILING JOIST WITH ANTI MICROBIAL PAINT COATING	
CF04	 SMOOTH PUTTY UNDER RC SLAB/B EAM WITH SATIN WHITE PAINT FINISH	

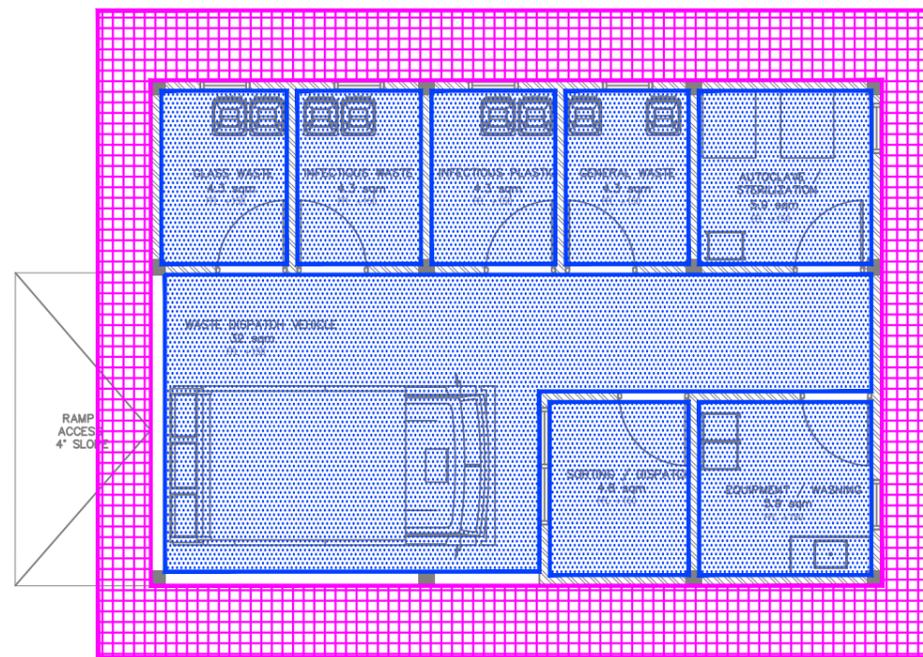**WASTE MANAGEMENT BLOCK
CEILING FINISHES LAYOUT**

SCALE 1:100



RIYAN PRIVATE LIMITED

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Title: Ground Floor, Ceiling
Finishes Layout

Page: F-03 / 03