

SECTION
BORE HOLE DETAIL
Scale - 1:20

NOTES :

PROJECT :
DESIGN & BUILD FOR
CONSTRUCTION OF WATER
SUPPLY & SEWERAGE FACILITIES

TITLE :
TYPICAL BOREHOLE DETAIL

CLIENT :
MINISTRY OF NATIONAL PLANNING,
HOUSING & INFRASTRUCTURE


SCALE :
AS GIVEN

DATE :
Nov-20

PROJECT NO :

ARCHITECT : -
ENGINEER : -
DRAWN BY : -
CHECKED BY : -
APPROVED BY : -

DWG NO :
A- /-

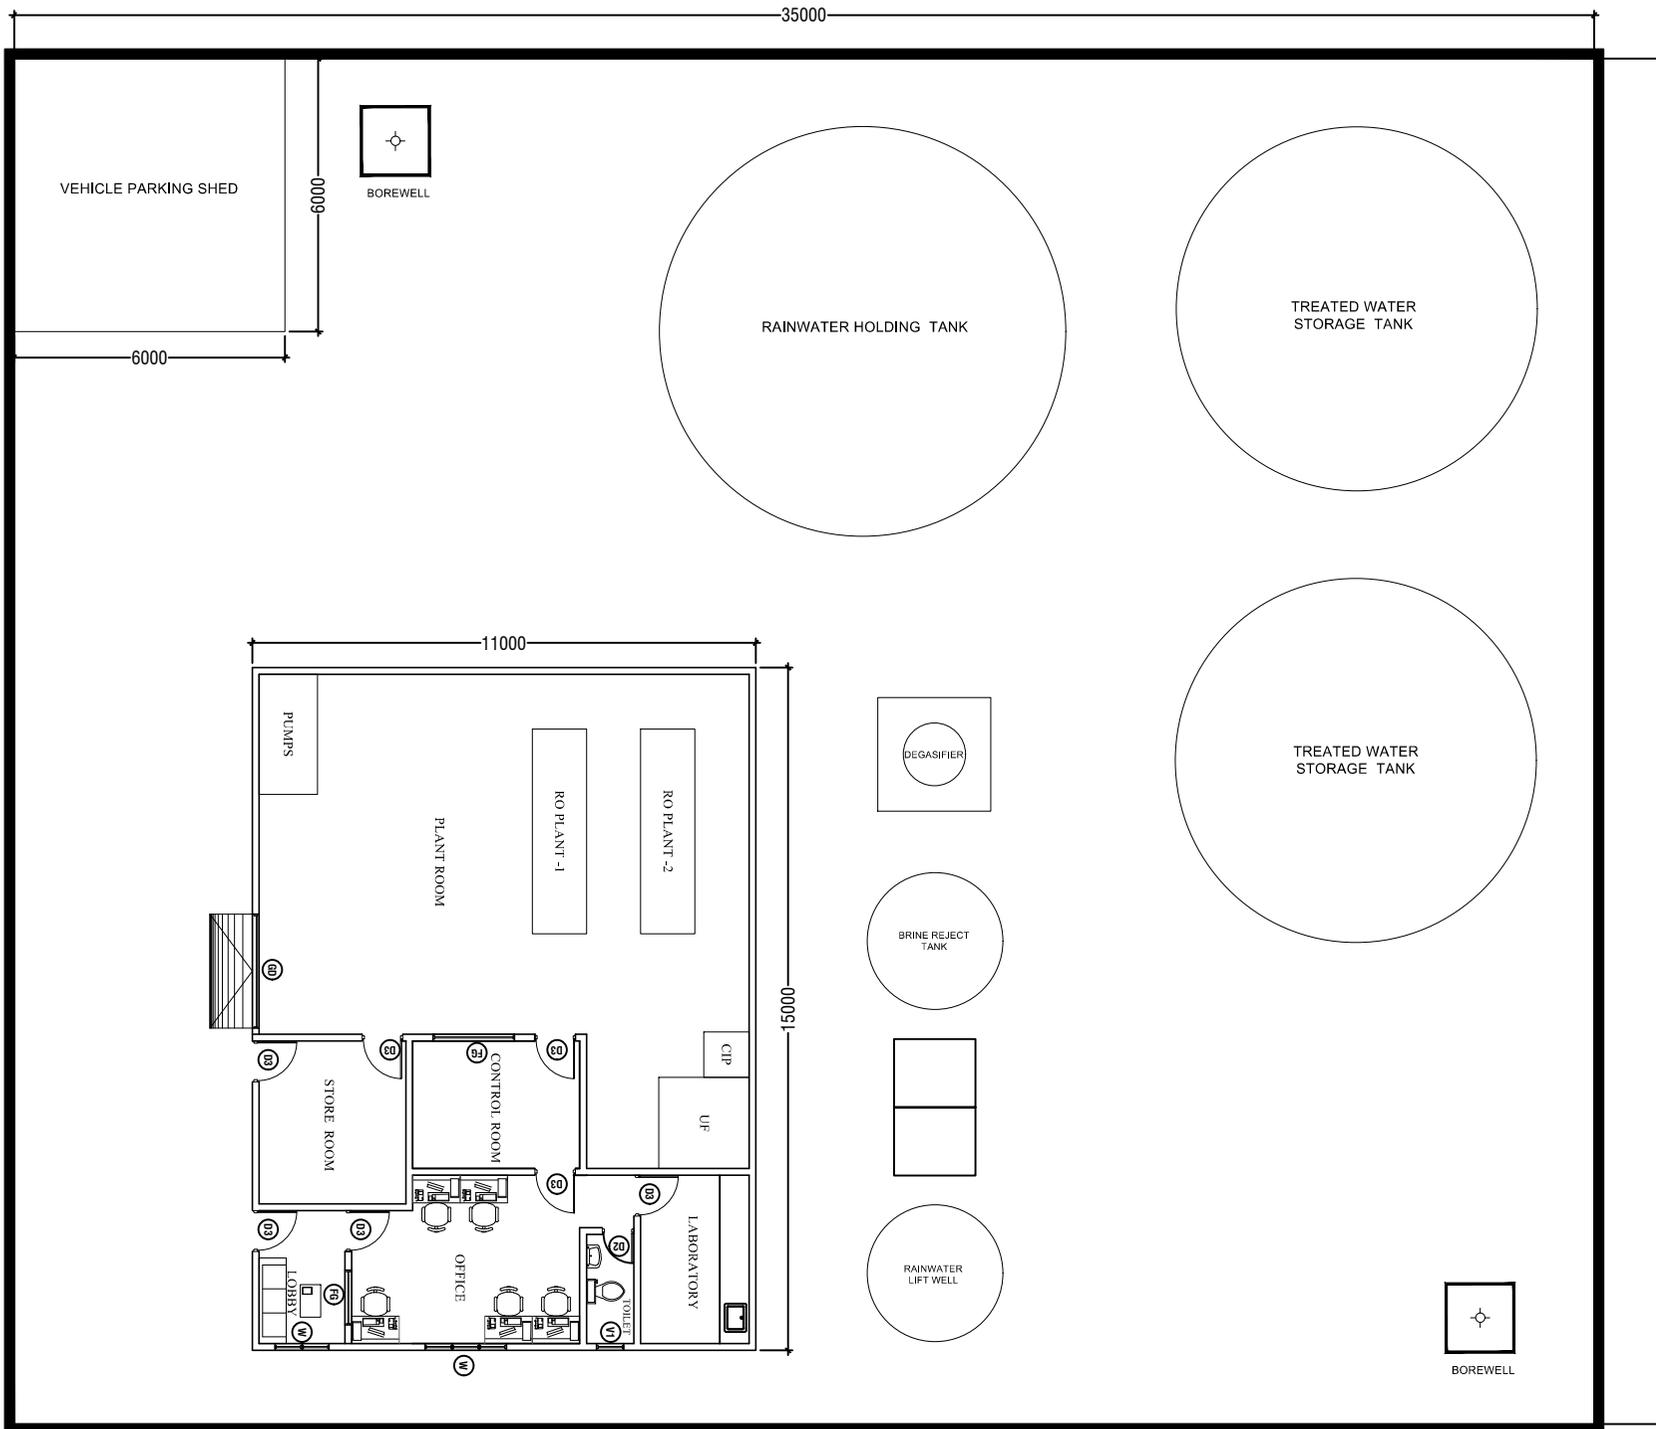

NOTES :

PROJECT :
DESIGN & BUILD FOR CONSTRUCTION OF WATER SUPPLY & SEWERAGE FACILITIES

TITLE :
 TYPICAL WTP LAYOUT

CLIENT :
 MINISTRY OF NATIONAL PLANNING, HOUSING & INFRASTRUCTURE


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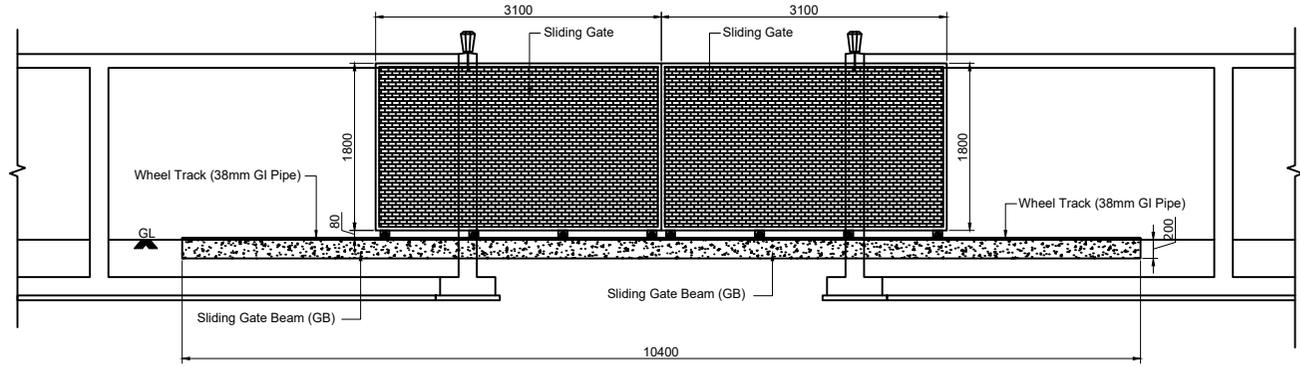
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 ENGINEER : -
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 APPROVED BY : -

DWG NO :
 A- -/-



Wall Elevation Details
(Scale: 1:40)

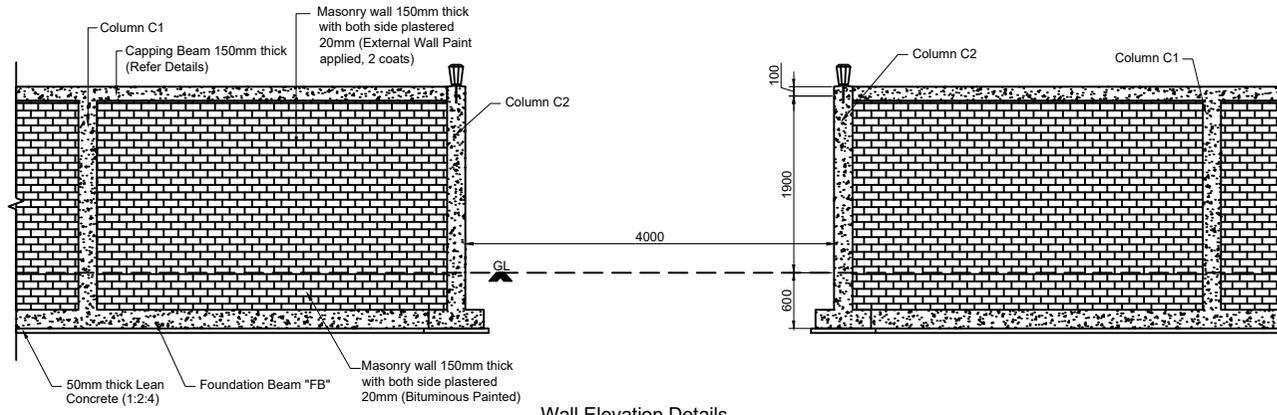

Gate Details
(Scale: 1:40)

NOTES :

PROJECT :
DESIGN & BUILD FOR CONSTRUCTION OF WATER SUPPLY & SEWERAGE FACILITIES

TITLE :
TYPICAL FACILITY BOUNDARY WALL

CLIENT :
MINISTRY OF NATIONAL PLANNING, HOUSING & INFRASTRUCTURE


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DWG NO :
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LEGEND	ABBREVIATION INDEX
	PI - PRESSURE INDICATOR
	PT - PRESSURE TRANSDUCER
	FS - FLOW METER
	CV - CHECK VALVE
	MC - MODULATING CONTROL
	PV - PRESSURE VESSEL
	VC - VERTICAL COUPLING
	U - UNION COUPLING
	SP - SAMPLE VALVE

NOTES :

PROJECT :
DESIGN & BUILD FOR CONSTRUCTION OF WATER SUPPLY & SEWERAGE FACILITIES

TITLE :
 TYPICAL P & ID DIAGRAM

CLIENT :
 MINISTRY OF NATIONAL PLANNING, HOUSING & INFRASTRUCTURE

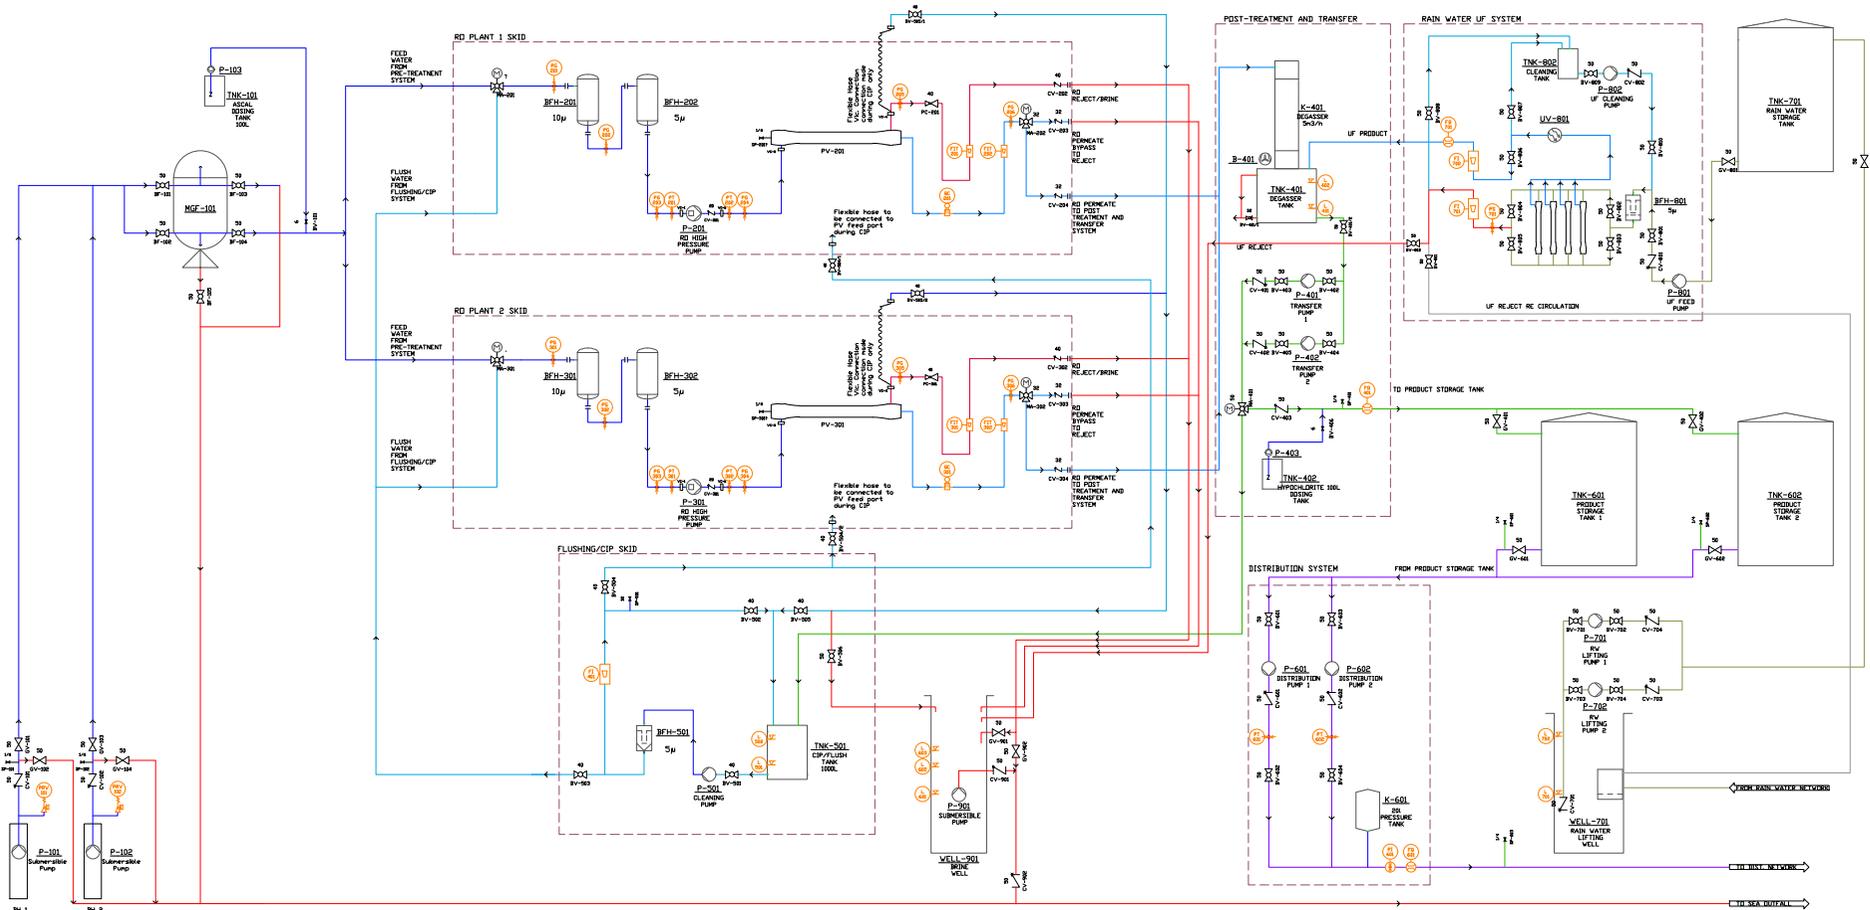SCALE :
 AS GIVEN



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 Nov-20

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ARCHITECT : -
 ENGINEER : -
 DRAWN BY : -
 CHECKED BY : -
 APPROVED BY : -

DWG NO :
A- /- /-



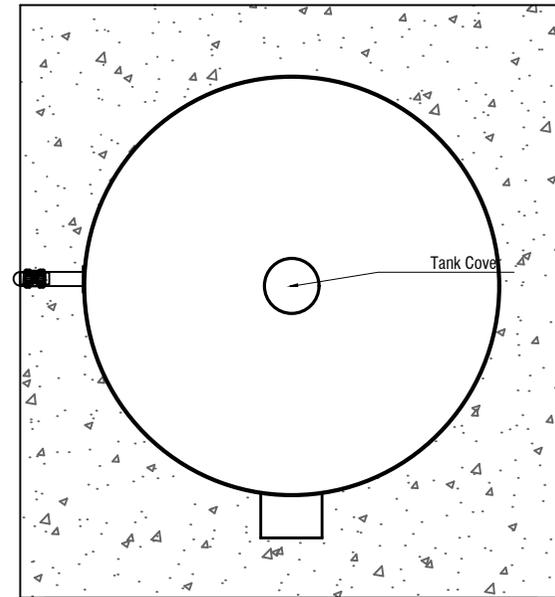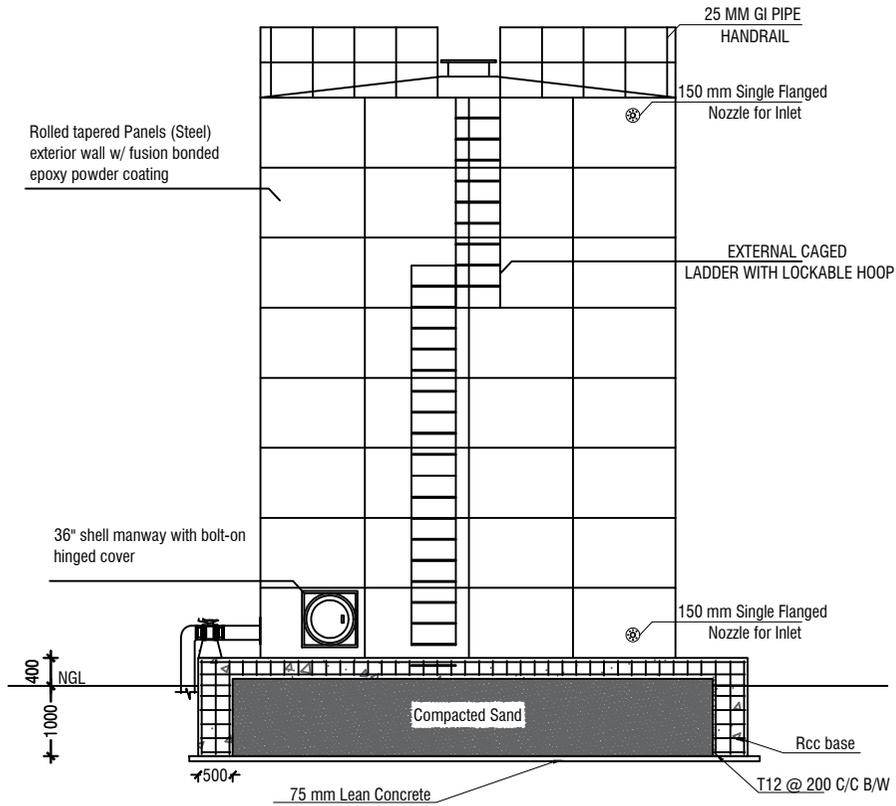

TREATED WATER/RAINWATER STORAGE TANK

NOTES :

PROJECT :
DESIGN & BUILD FOR CONSTRUCTION OF WATER SUPPLY & SEWERAGE FACIL

TITLE :
TYPICAL STORAGE TANK

CLIENT :
MINISTRY OF NATIONAL PLANNING, HOUSING & INFRASTRUCTURE


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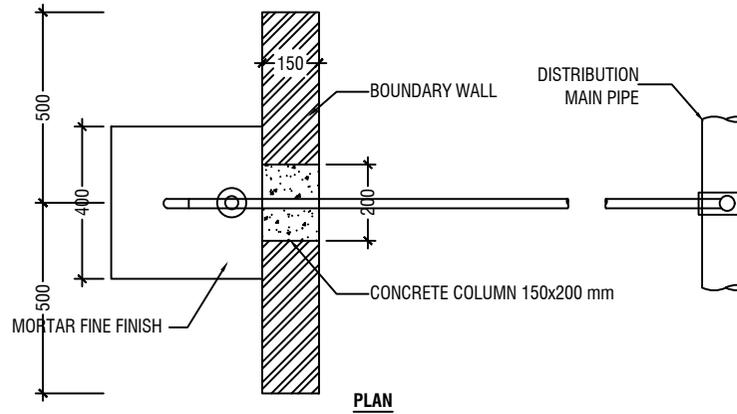
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ARCHITECT : -
 ENGINEER : -
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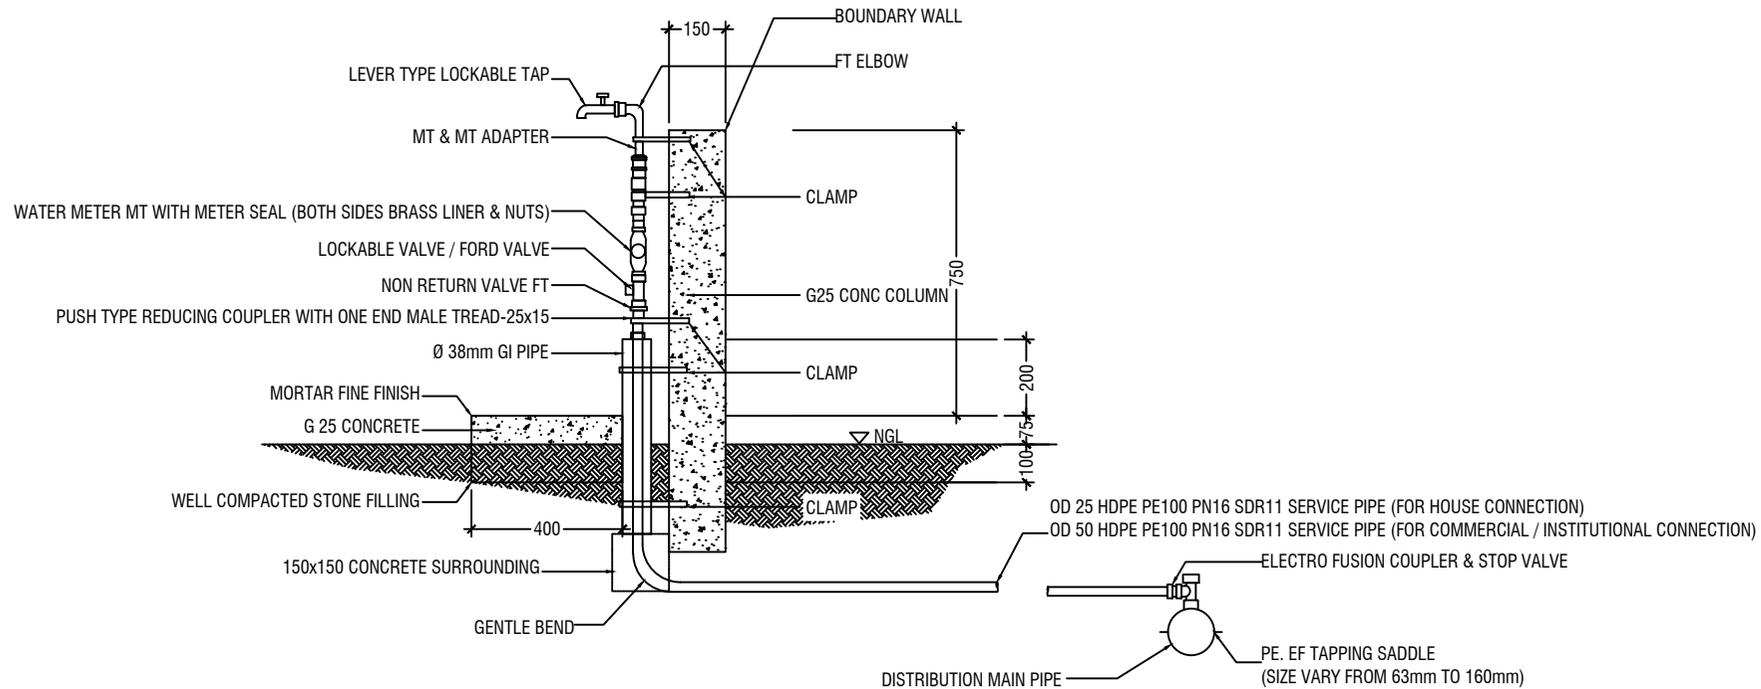
DWG NO :
A- -/-



TYPICAL PIPE TRENCH



HOUSE CONNECTION DETAIL

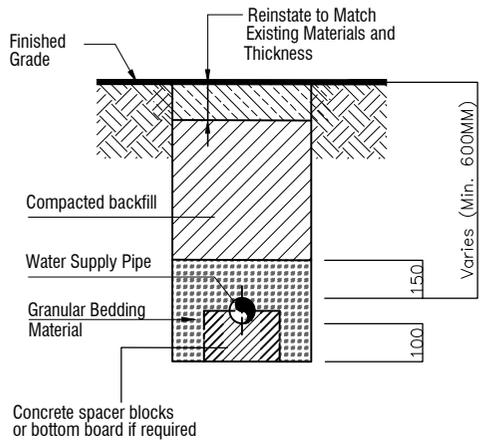

WATER SUPPLY HOUSE CONNECTION

NOTES :

PROJECT :
DESIGN & BUILD FOR CONSTRUCTION OF WATER SUPPLY & SEWERAGE FACILITIES

TITLE :
TYPICAL WATER SUPPLY CONNECTION


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 Nov-20

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ARCHITECT : -
 ENGINEER : -
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 DWG NO :



SECTION - VALVE CHAMBER

NOTES :

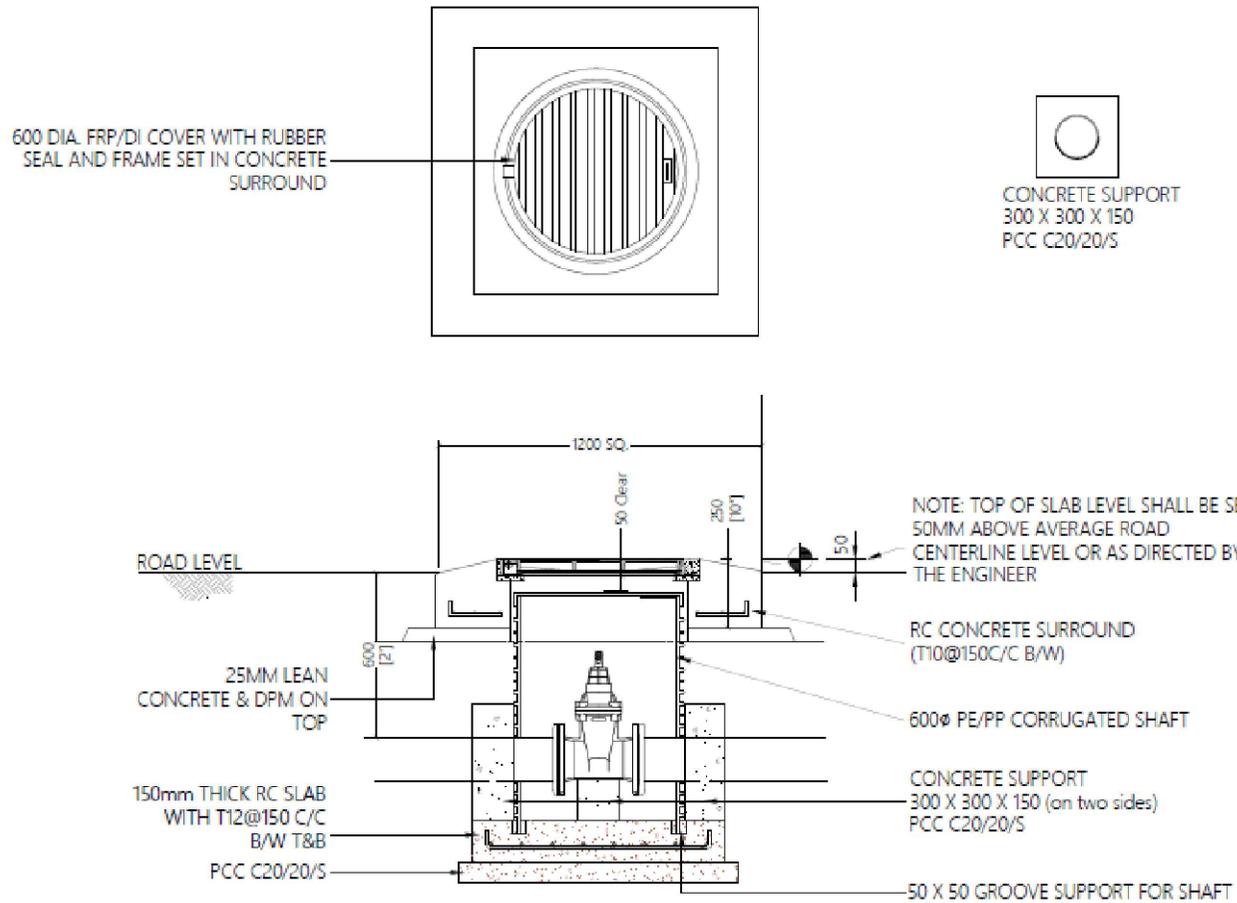PROJECT :
DESIGN & BUILD FOR CONSTRUCTION OF WATER SUPPLY & SEWERAGE FACILITIES

TITLE :
TYPICAL VALVE CHAMBER

CLIENT :
MINISTRY OF NATIONAL PLANNING, HOUSING & INFRASTRUCTURE



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ENGINEER : -
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RAINWATER LIFTWELL
NTS

NOTES :

PROJECT :
DESIGN & BUILD FOR
CONSTRUCTION OF WATER
SUPPLY & SEWERAGE FACILITIES

TITLE :
TYPICAL RAINWATER LIFTWELL

CLIENT :
MINISTRY OF NATIONAL PLANNING,
HOUSING & INFRASTRUCTURE

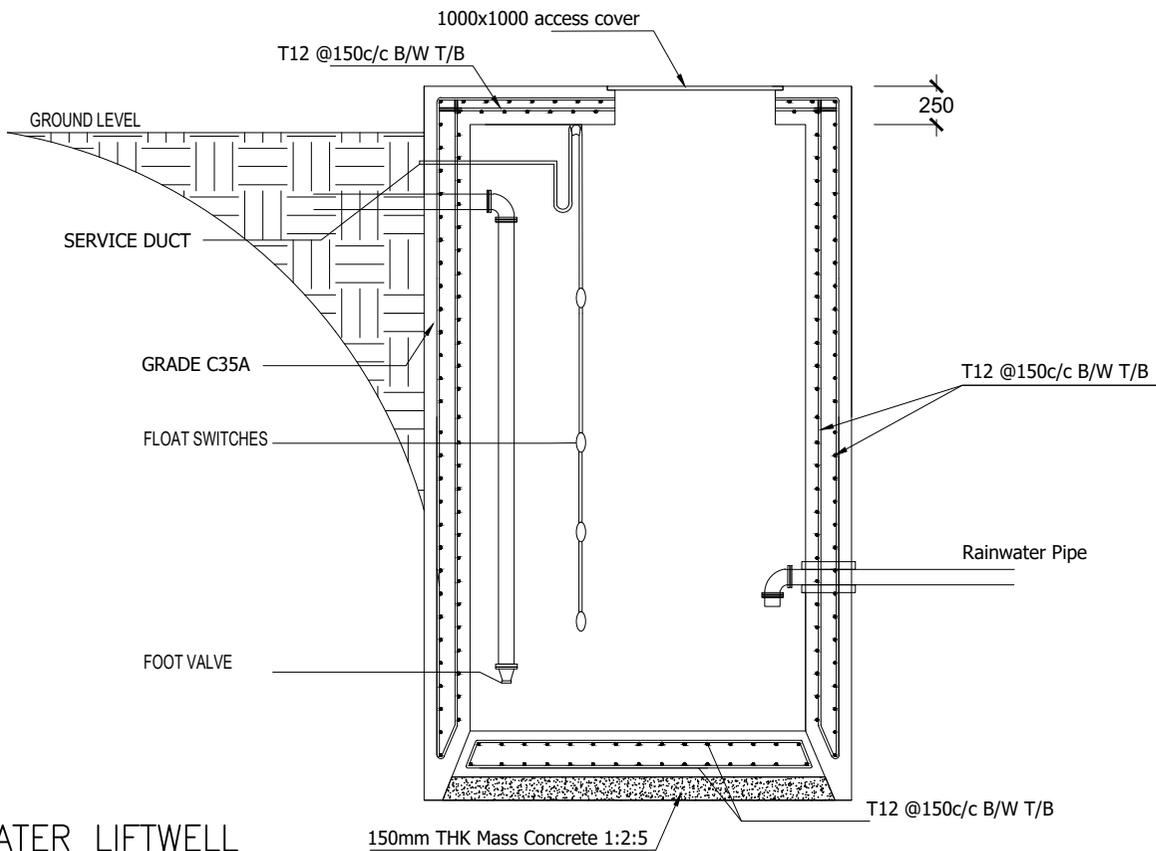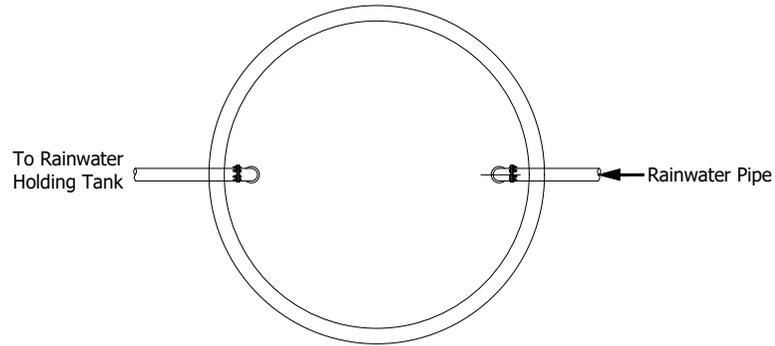
SCALE :
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Nov-20

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ENGINEER : -
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APPROVED BY : -
DWG NO :

A- /-



FIRST FLUSH MECHANISM

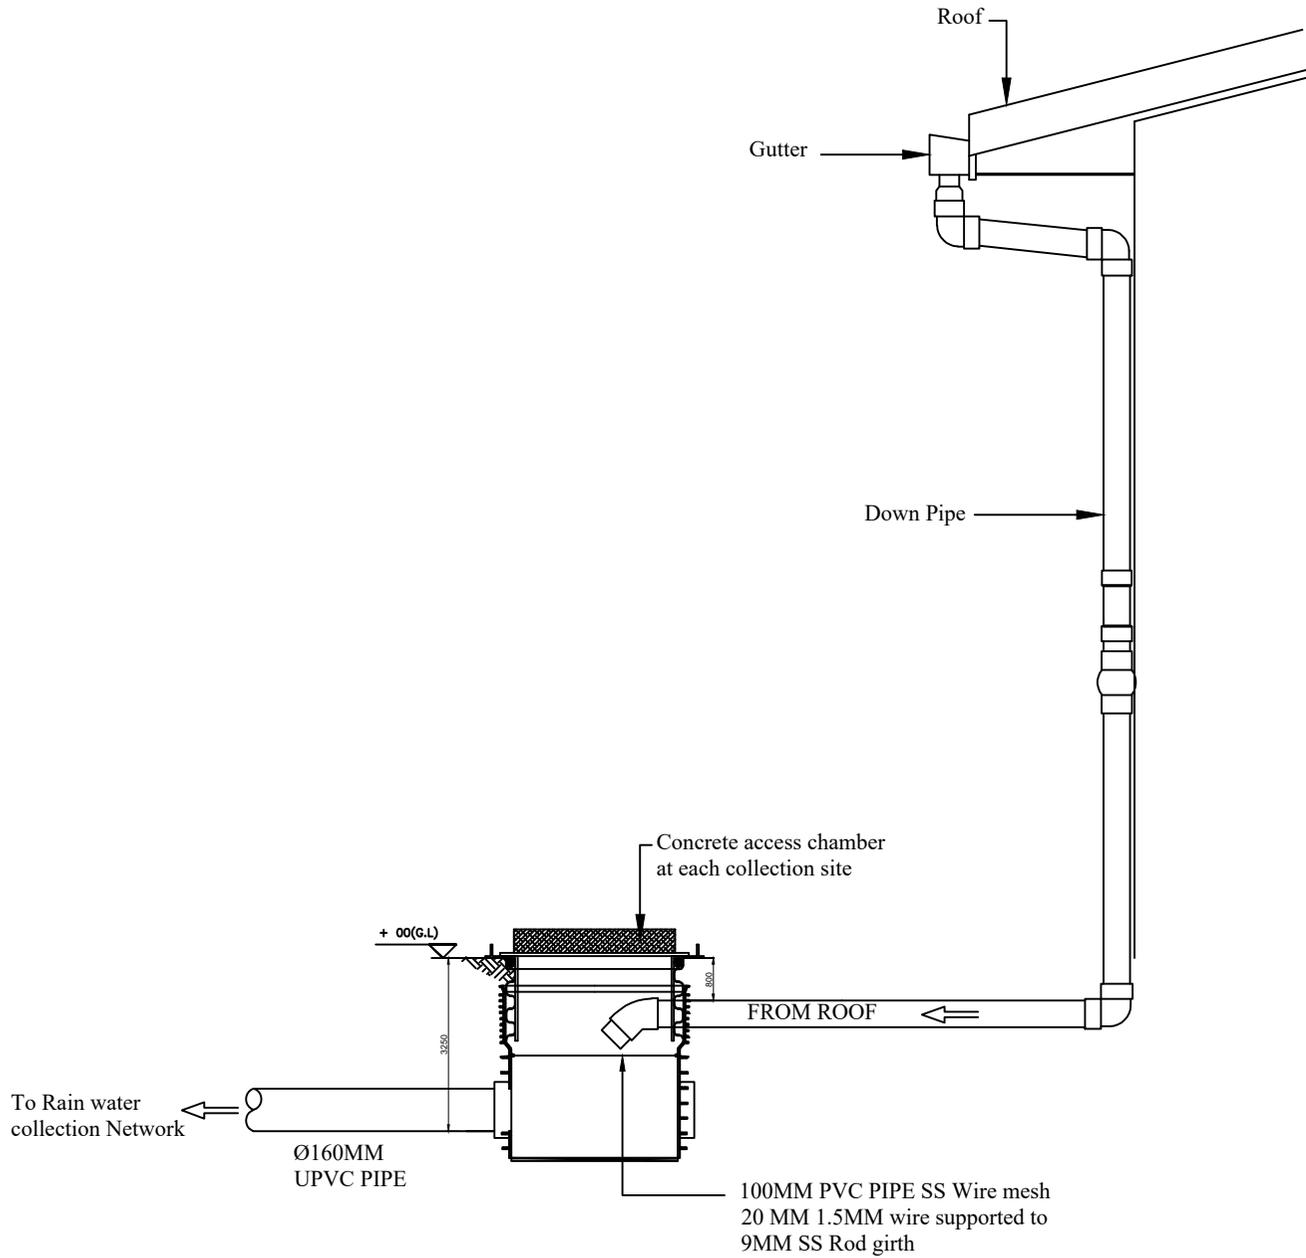NOTES :

PROJECT :
DESIGN & BUILD FOR CONSTRUCTION OF WATER SUPPLY & SEWERAGE FACILITIES

TITLE :
TYPICAL DOWNTAKE ARRANGEMENT

CLIENT :
MINISTRY OF NATIONAL PLANNING, HOUSING & INFRASTRUCTURE

SCALE :
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DATE :
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PROJECT NO :

ARCHITECT : -

ENGINEER : -

DRAWN BY : -


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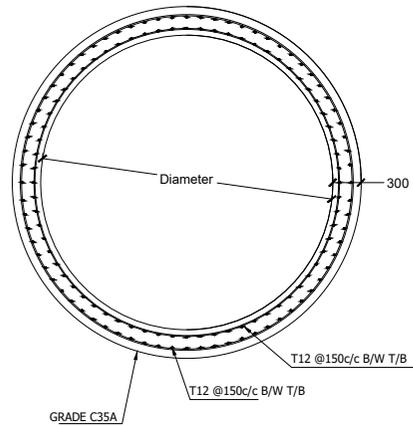
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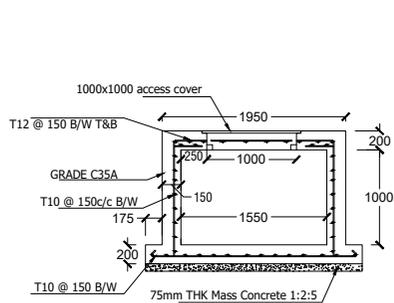


PLAN



Note:


1. All structural concrete shall be of grade C35A.
2. All castings shall be done using Sulpahte Resistant Portland Cement to BS 4027:1996.
3. All structural reinforcement shall be epoxy coating of non-pre-stressed reinforcement to ASTM-A775/A775M.

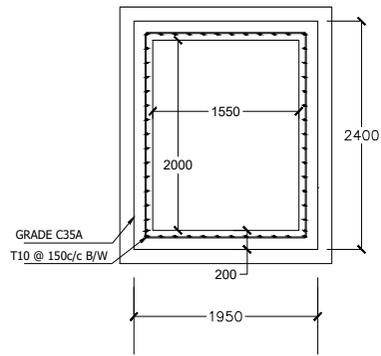

SECTION

VALVE CHAMBER DETAIL

PUMPING STATION STRUCTURAL DETAILS
Scale: N.T.S

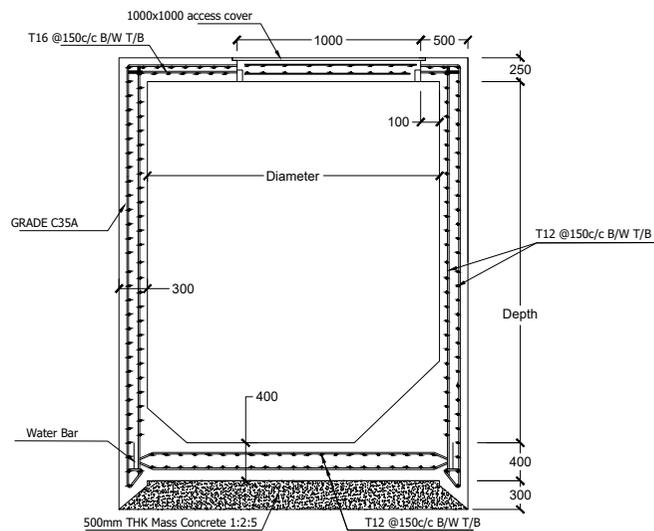

PUMP STATION DETAIL

NOTES :

PROJECT :
DESIGN & BUILD FOR
CONSTRUCTION OF WATER SUPPLY
& SEWERAGE FACI

TITLE :
Typical Pump Station

CLIENT :
MINISTRY OF NATIONAL PLANNING,
HOUSING & INFRASTRUCTURE

SCALE :
AS GIVEN

DATE :
Nov-20

PROJECT NO :

ARCHITECT : -

ENGINEER : -

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APPROVED BY : -


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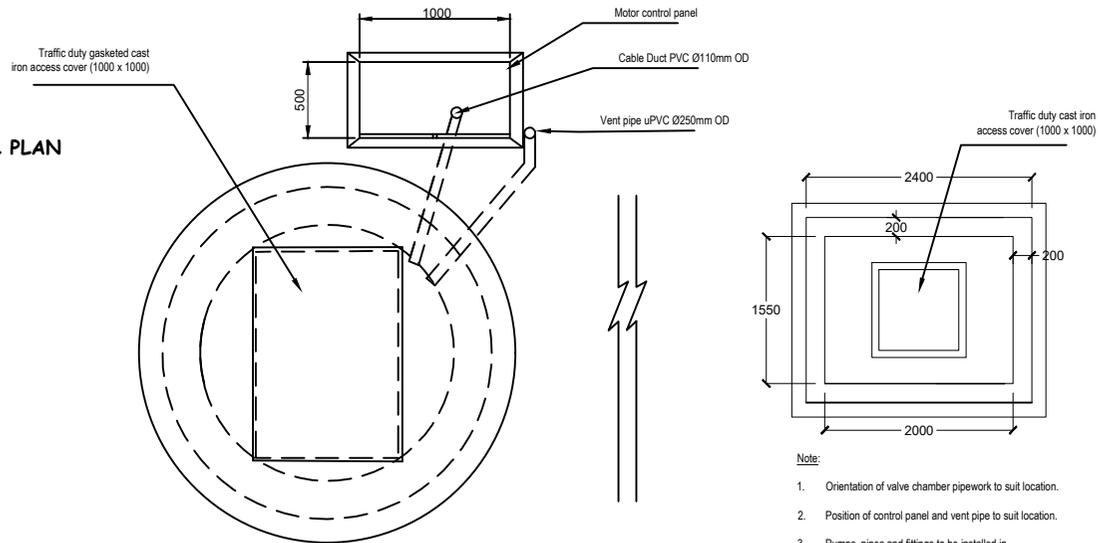


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SECTION VIEW



GROUND LEVEL PLAN

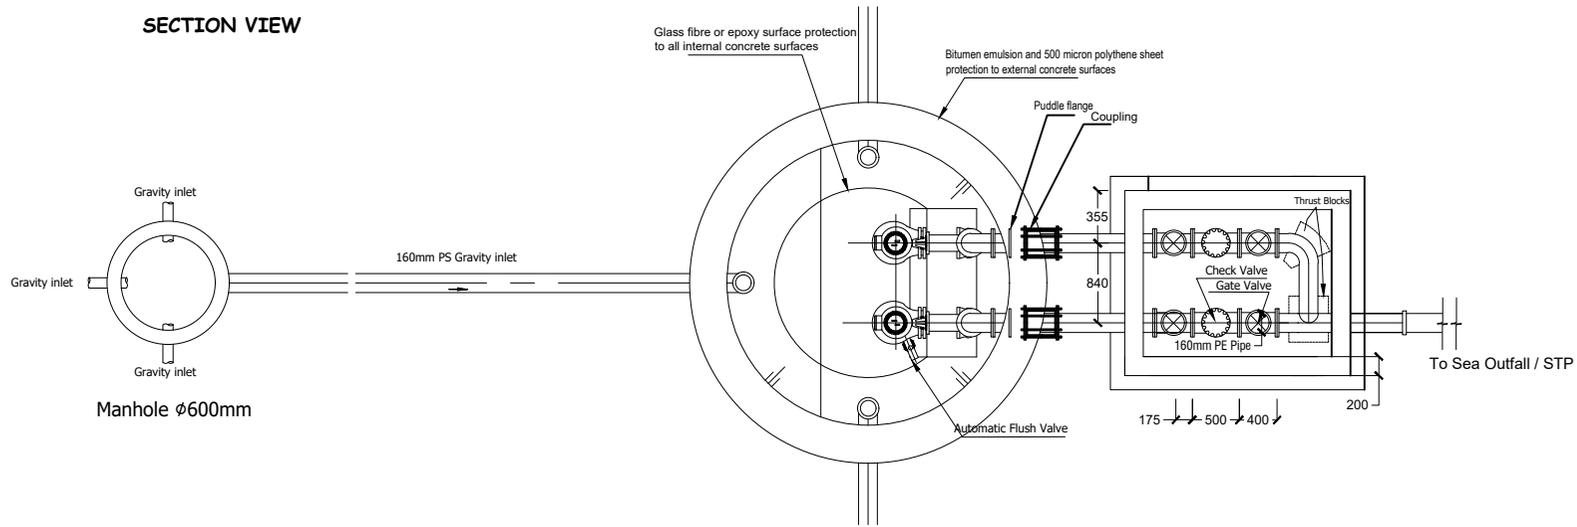

- Note:
1. Orientation of valve chamber pipework to suit location.
 2. Position of control panel and vent pipe to suit location.
 3. Pumps, pipes and fittings to be installed in accordance with manufacturers recommendations.

NOTES :

PROJECT :
DESIGN & BUILD FOR CONSTRUCTION OF WATER SUPPLY & SEWERAGE FACILITIES

TITLE :
 Typical Pump Station

CLIENT :
 MINISTRY OF NATIONAL PLANNING, HOUSING & INFRASTRUCTURE


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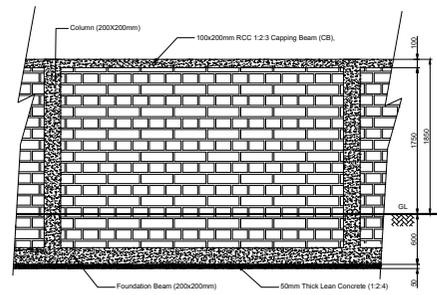
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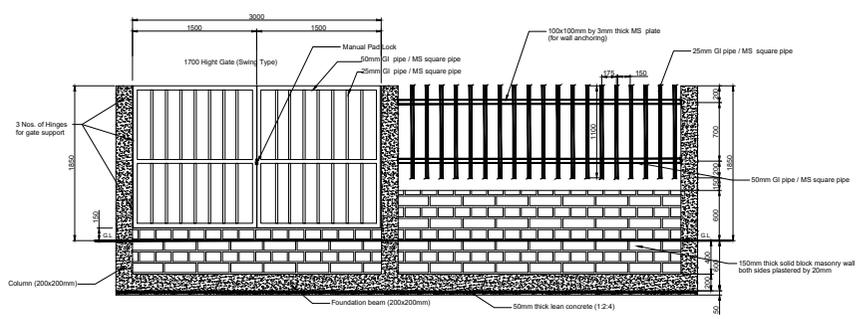
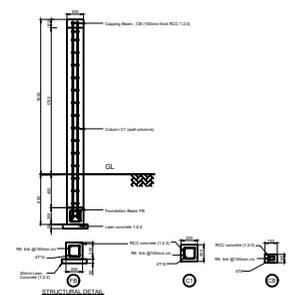
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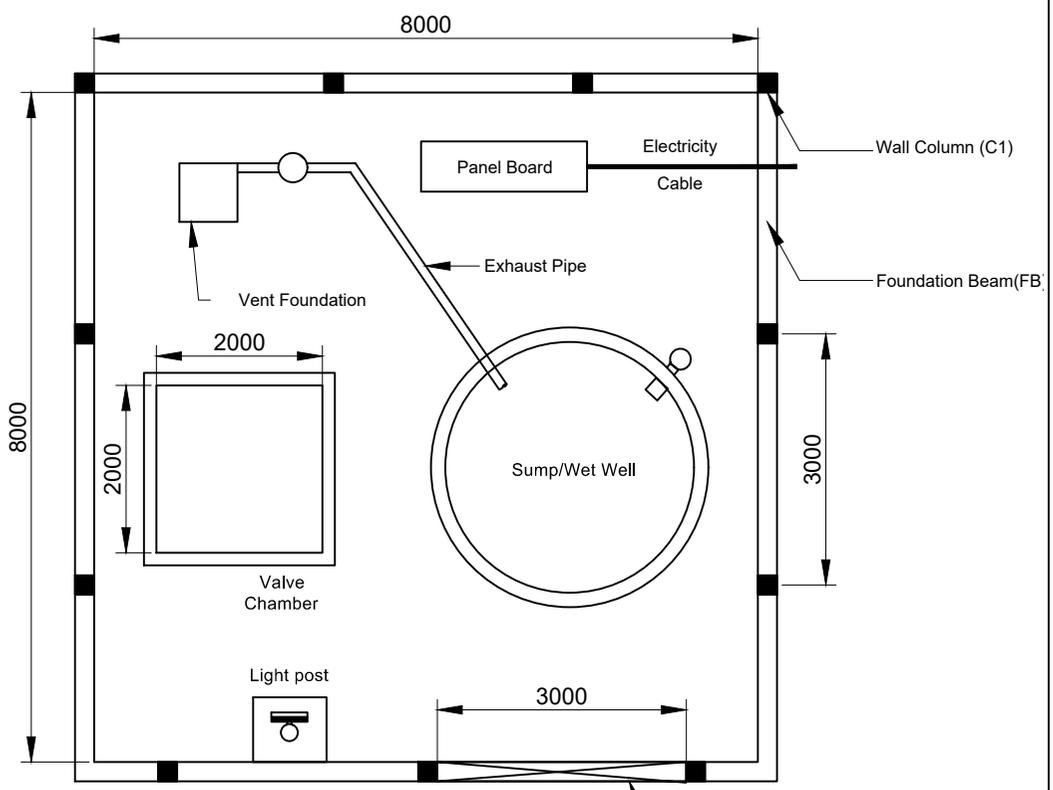
BOUNDARY WALL FENCING ALONG THE ROAD SIDE



BOUNDARY WALL ALONG ADJACENT TO ANOTHER ROAD / PLOT



BOUNDARY WALL FENCING & STEEL GATE ELEVATION DETAILS

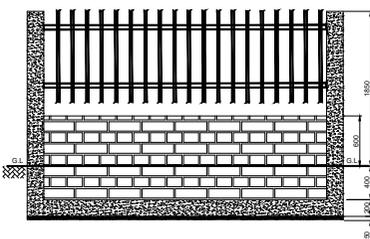

LAYOUT OF SPS WITH BOUNDARY WALL

(1:50)

NOTES :

PROJECT :
DESIGN & BUILD FOR CONSTRUCTION OF WATER SUPPLY AND SEWERAGE FACILITIES

TITLE :
PUMP STATION PLOT LAYOUT

CLIENT :
MINISTRY OF NATIONAL PLANNING, HOUSING & INFRASTRUCTURE


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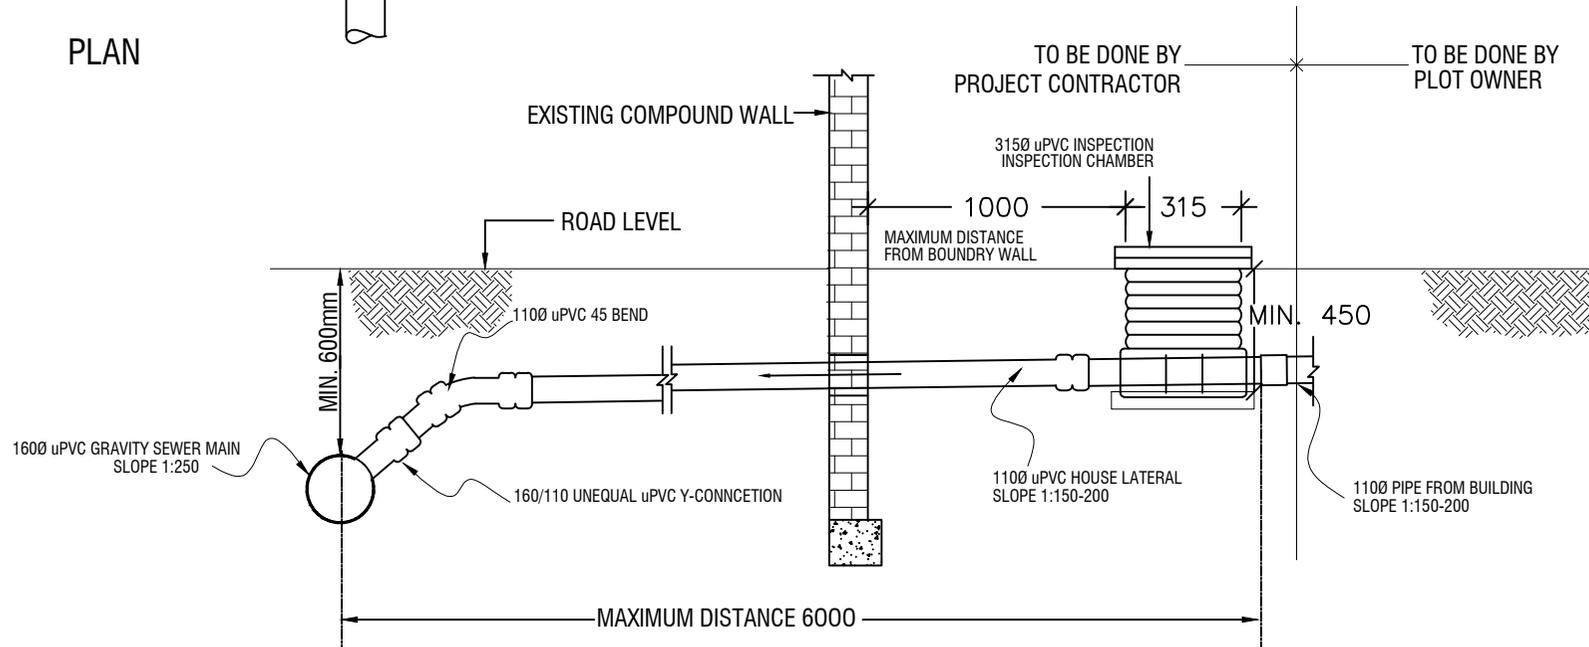
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ARCHITECT : -
 ENGINEER : -
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 APPROVED BY : -

DWG NO :
A- -/-



PLAN

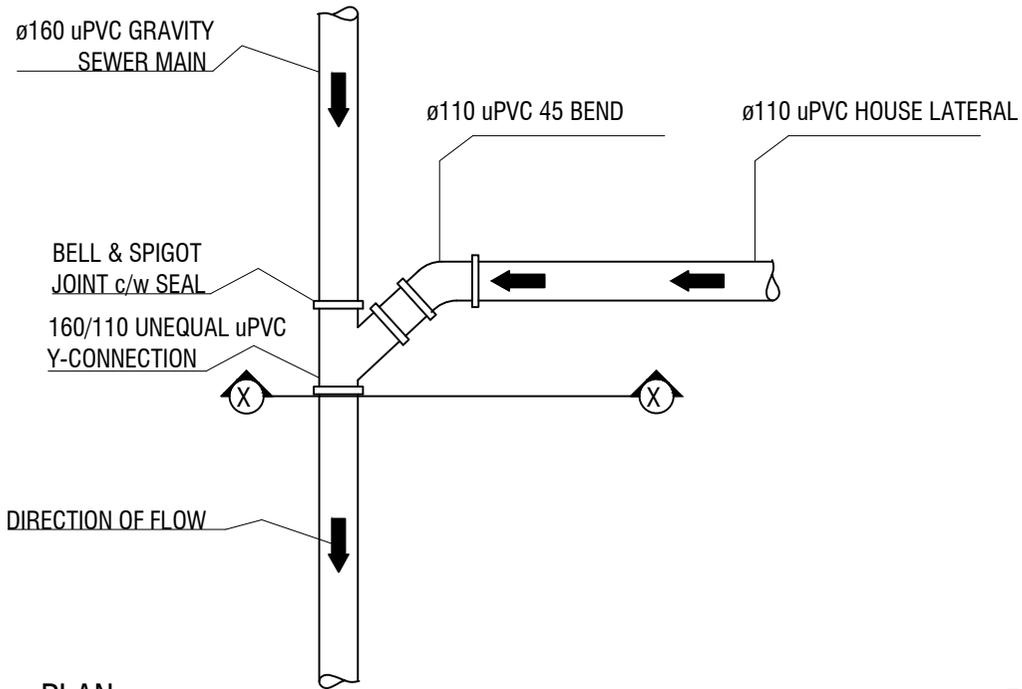

SECTION

TYPICAL HOUSE CONNECTION DETAIL
N.T.S

NOTES :

PROJECT :
DESIGN & BUILD FOR CONSTRUCTION OF WATER SUPPLY & SEWERAGE FACILITIES

TITLE :
SEWERAGE COLLECTION SYSTEM

CLIENT :
MINISTRY OF NATIONAL PLANNING, HOUSING & INFRASTRUCTURE

SCALE :
AS GIVEN

DATE :
Nov-20

PROJECT NO :

ARCHITECT : -

ENGINEER : -

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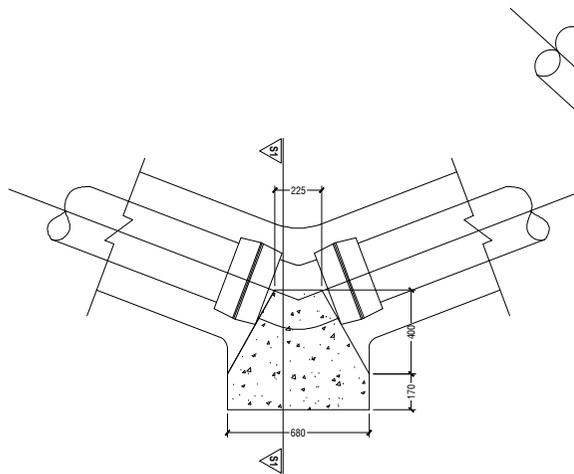
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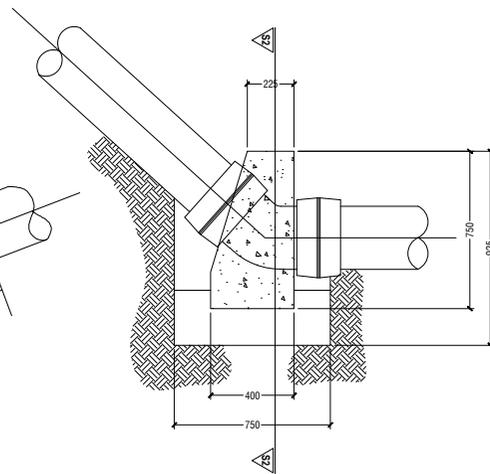
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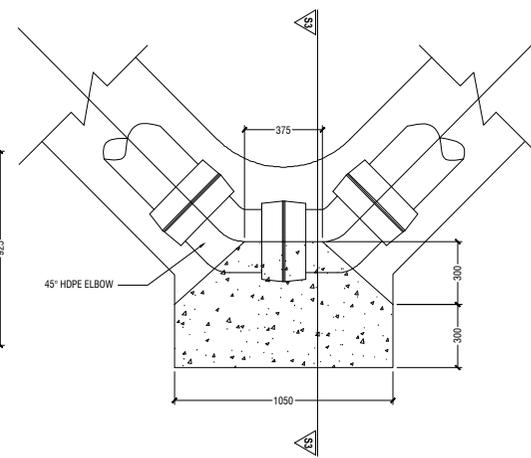
MINISTRY OF NATIONAL PLANNING,
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 TEL: 4662001, 4662071, 4662111; WWW.PLANING.GOV.MV




HORIZONTAL 45° BEND
NTS




VERTICAL 45° BEND
NTS




HORIZONTAL 90° BEND
NTS

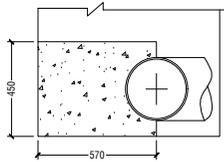

SECTION S1-S1
NTS

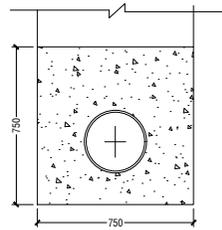

SECTION S2-S2
NTS

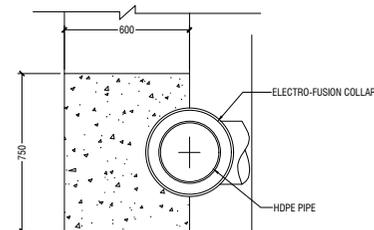

SECTION S3-S3
NTS

THRUST BLOCK DETAIL - FORCE MAINS ONLY



NOTES :

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DESIGN & BUILD FOR CONSTRUCTION OF WATER SUPPLY & SEWERAGE FACILITIES

TITLE :
SEWERAGE COLLECTION SYSTEM

CLIENT :
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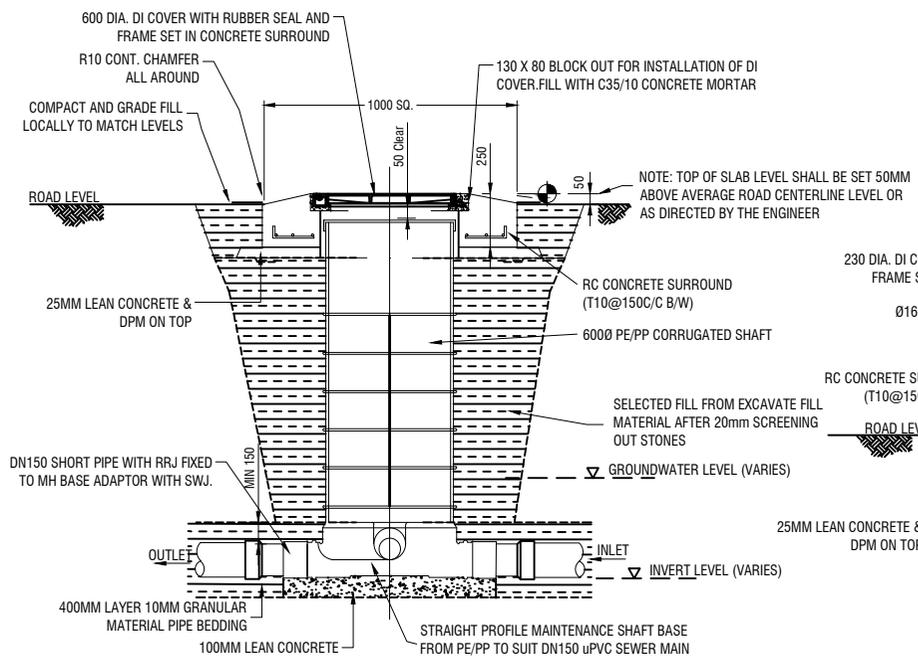
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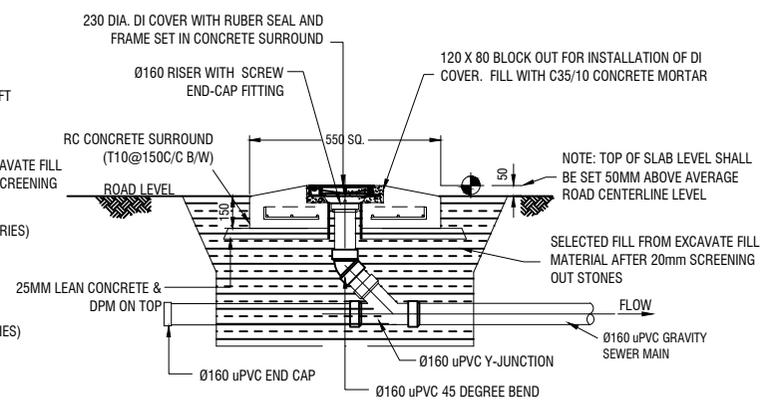
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DWG NO :


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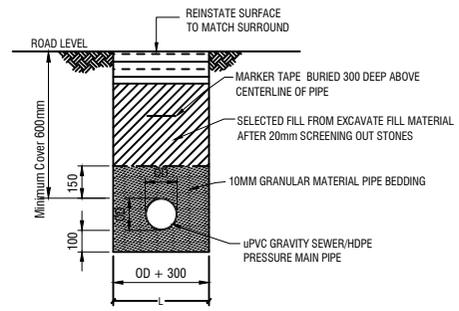
ELEVATION - MAINTENANCE SHAFT (MH)
Scale 1:20



ELEVATION - CLEANOUT (CO)
Scale 1:20



HOUSE INSPECTION CHAMBER (IC)
Scale 1:20

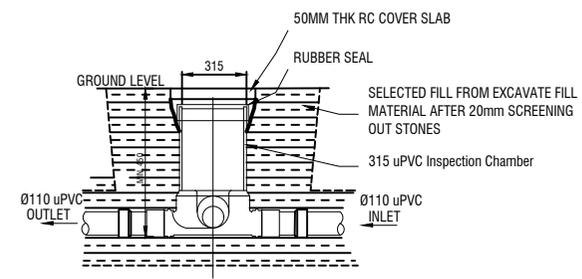

TRENCH & BEDDING DETAILS
Scale 1:20

NOTES :

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TITLE :
SEWERAGE COLLECTION SYSTEM

CLIENT :
MINISTRY OF NATIONAL PLANNING, HOUSING & INFRASTRUCTURE


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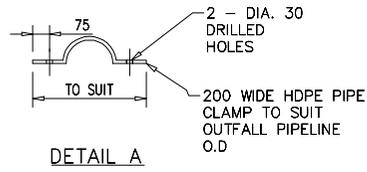
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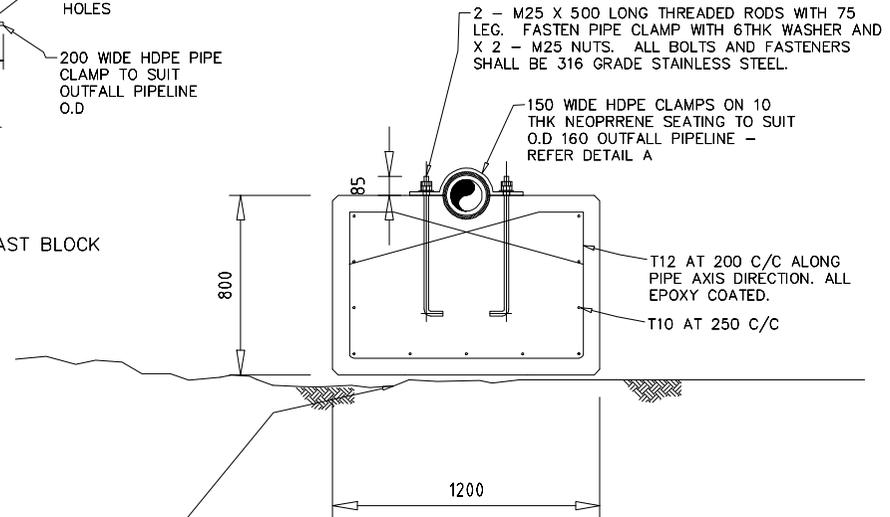


PLAN PRE-CAST BALLAST BLOCK
Scale: N.T.S




PRE-CAST BALLAST BLOCK

PREPARE SEABED PRIOR TO PLACEMENT OF BALLAST BLOCKS MAX. +/- 25MM AMPLITUDE

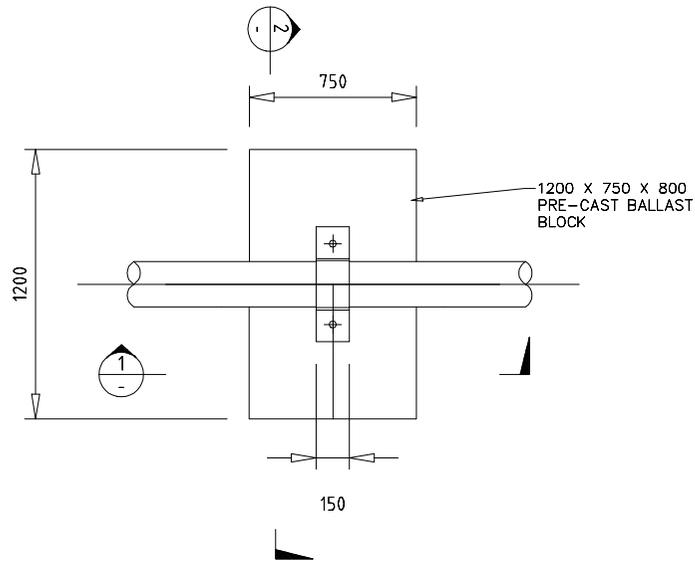


SECTION - PRE-CAST BALLAST BLOCK ASSEMBLY
Scale: N.T.S


- NOTES:
1. MIN 75MM COVER TO ALL REINFORCEMENT BARS.
 2. ALL REINFORCEMENT SHALL BE EPOXY COATED PRIOR TO PLACEMENT OF CONCRETE.
 3. PRE-CAST BALLAST BLOCKS SHALL BE FABRICATED WITH N40 / 20 CONCRETE.

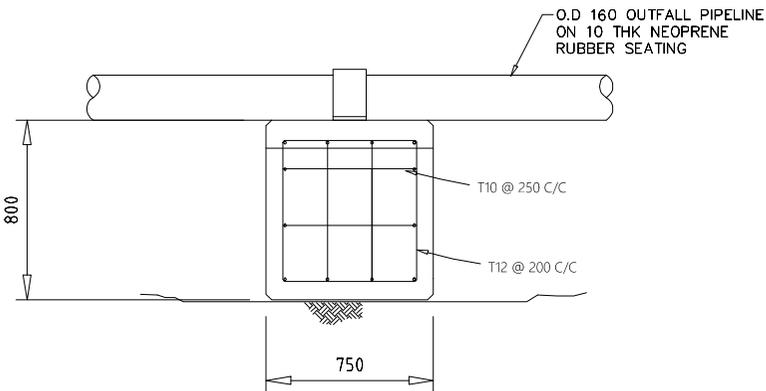

ELEVATION
Scale: N.T.S

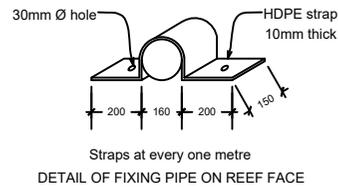

ANCHOR BOLT DETAIL FOR FIXING OUTFALL PIPE ON STEEP REEF SLOPES

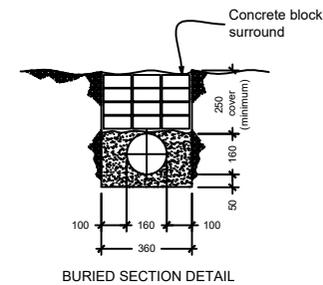

SEA OUTFALL FIXING DETAIL
Scale: N.T.S

NOTES:

PROJECT :
DESIGN & BUILD FOR
CONSTRUCTION OF WATER SUPPLY
& SEWERAGE FACILITIES

TITLE :
Sea Outfall

CLIENT :
MINISTRY OF NATIONAL PLANNING,
HOUSING & INFRASTRUCTURE

SCALE :
AS GIVEN


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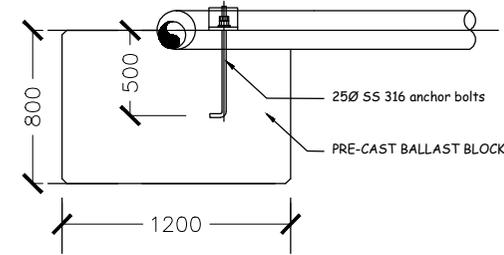
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DWG NO :


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PLAN – T-HEAD DIFFUSER
Scale: N.T.S



SECTION – T-HEAD DIFFUSER
Scale: N.T.S

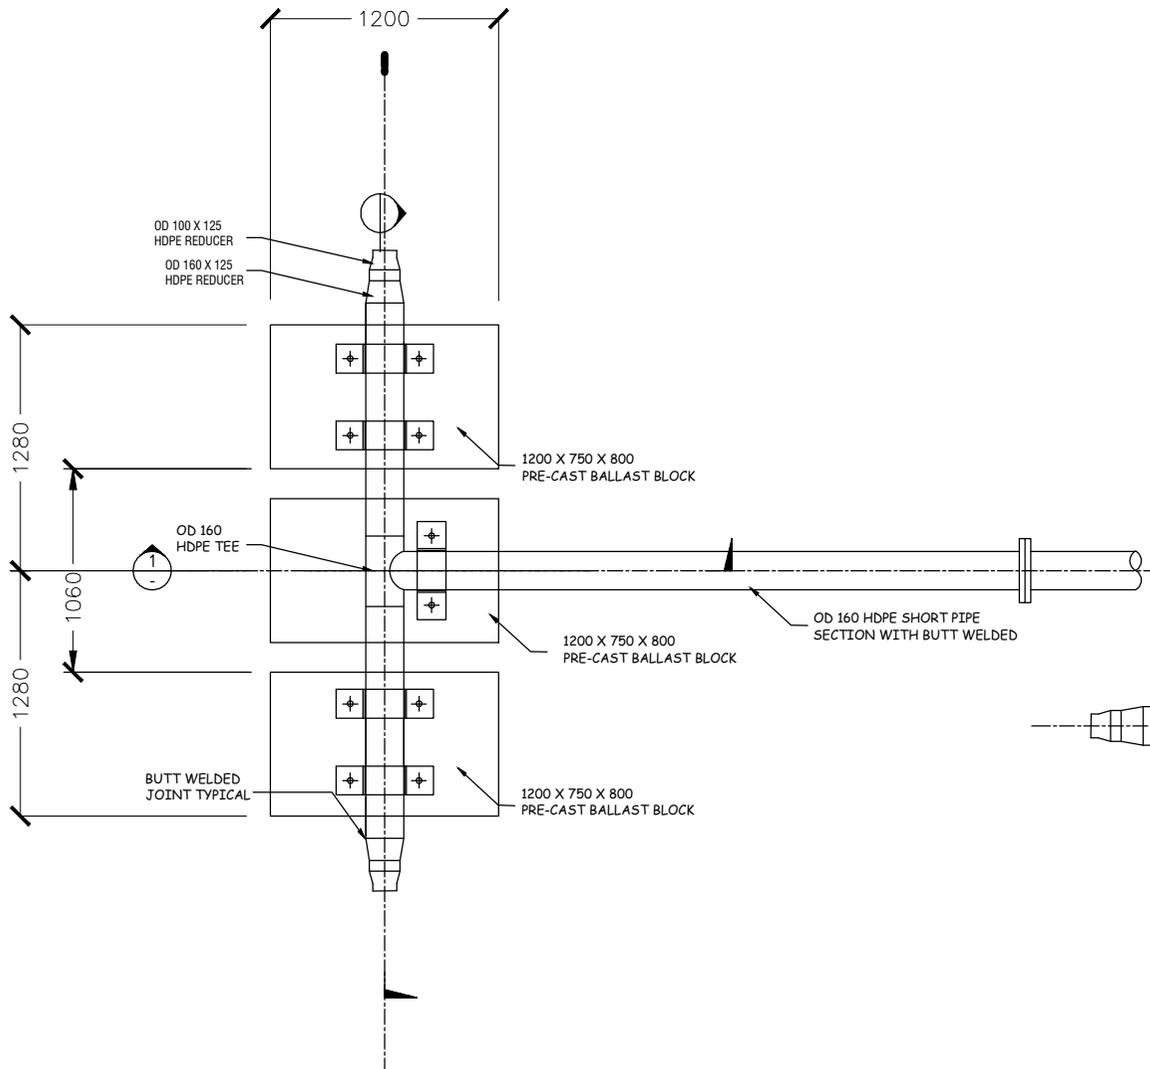

SECTION – T-HEAD DIFFUSER

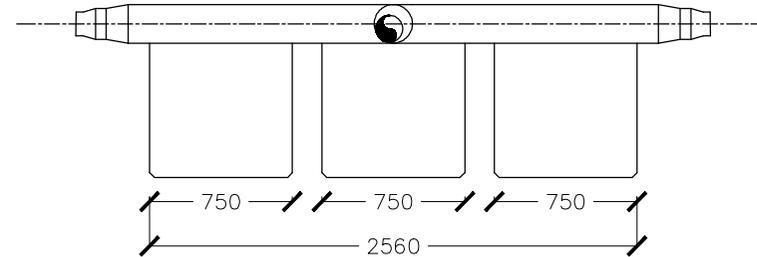- NOTES:
1. ALL BACKING RINGS FOR STUB FLANGES, NUTS AND BOLTS SHALL BE GRADE 316 STAINLESS STEEL.
 2. ALL PIPEWORK SHALL BE BEDDED ON 10MM THICK NEOPRENE RUBBER SEAT IN SEMICIRCULAR RECESS MATCHING THE O.D OF THE PIPE.
 3. FABRICATE SPECIFIC PIPE CLAMPS TO PROVIDE FIRM CLAMPING ACTION ACCORDING TO PIPE O.D .

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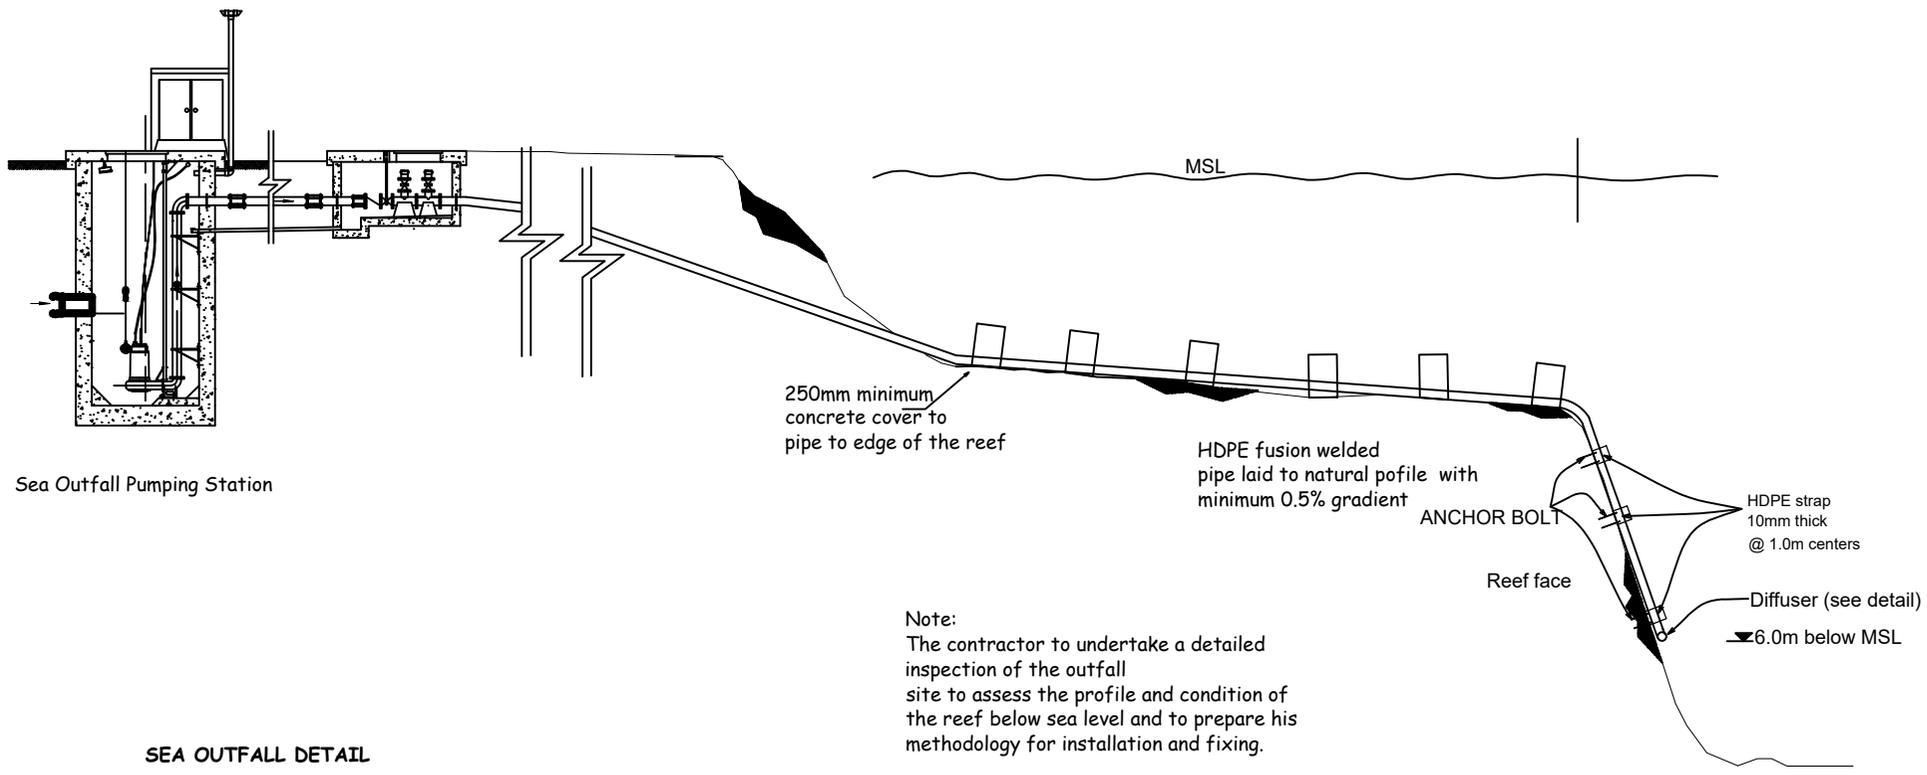
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Sea Outfall Pumping Station

250mm minimum concrete cover to pipe to edge of the reef

HDPE fusion welded pipe laid to natural profile with minimum 0.5% gradient

ANCHOR BOLT

HDPE strap 10mm thick @ 1.0m centers

Reef face

Diffuser (see detail) 6.0m below MSL

Note:
The contractor to undertake a detailed inspection of the outfall site to assess the profile and condition of the reef below sea level and to prepare his methodology for installation and fixing.

SEA OUTFALL DETAIL
Scale: N.T.S

NOTES :

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TITLE :
Sea Outfall

CLIENT :
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