

Proposed 12 Classroom at
S.Hithadhoo Noorani School
(03 Storey)

SERVICES DRAWINGS
Client: Ministry of Education




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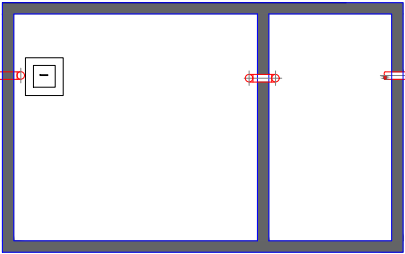
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3rd floor, H. Azum, Amereemagui, Male'

TABLE OF CONTENTS

DRAWING No.	TITLE	REVISION No.	DATE	REMARKS
S E R V I C E S		---	---	---
DR - 01 /03	GROUND FLOOR DRAINAGE LAYOUT	---	---	---
DR - 02 /03	FIRST - SECOND FLOOR DRAINAGE LAYOUT	---	---	---
DR - 03 /03	ROOF DRAINAGE LAYOUT	---	---	---
PL - 01 / 02	GROUND FLOOR PLUMBING LAYOUT	---	---	---
PL - 02 / 02	FIRST - SECOND FLOOR PLUMBING LAYOUT	---	---	---
EL - 01 / 02	GROUND FLOOR LIGHTING LAYOUT	---	---	---
EL - 02 / 02	FIRST - SECOND FLOOR LIGHTING LAYOUT	---	---	---
EP - 01 / 02	GROUND FLOOR POWER LAYOUT	---	---	---
EP - 02 / 02	FIRST - SECOND FLOOR POWER LAYOUT	---	---	---
FDP - 01 / 02	GROUND FLOOR FDP LAYOUT	---	---	---
FDP - 02 / 02	FIRST - SECOND FLOOR FDP LAYOUT	---	---	---
DETAIL - 01/ 01	SEPTIC TANK DETAIL	---	---	---

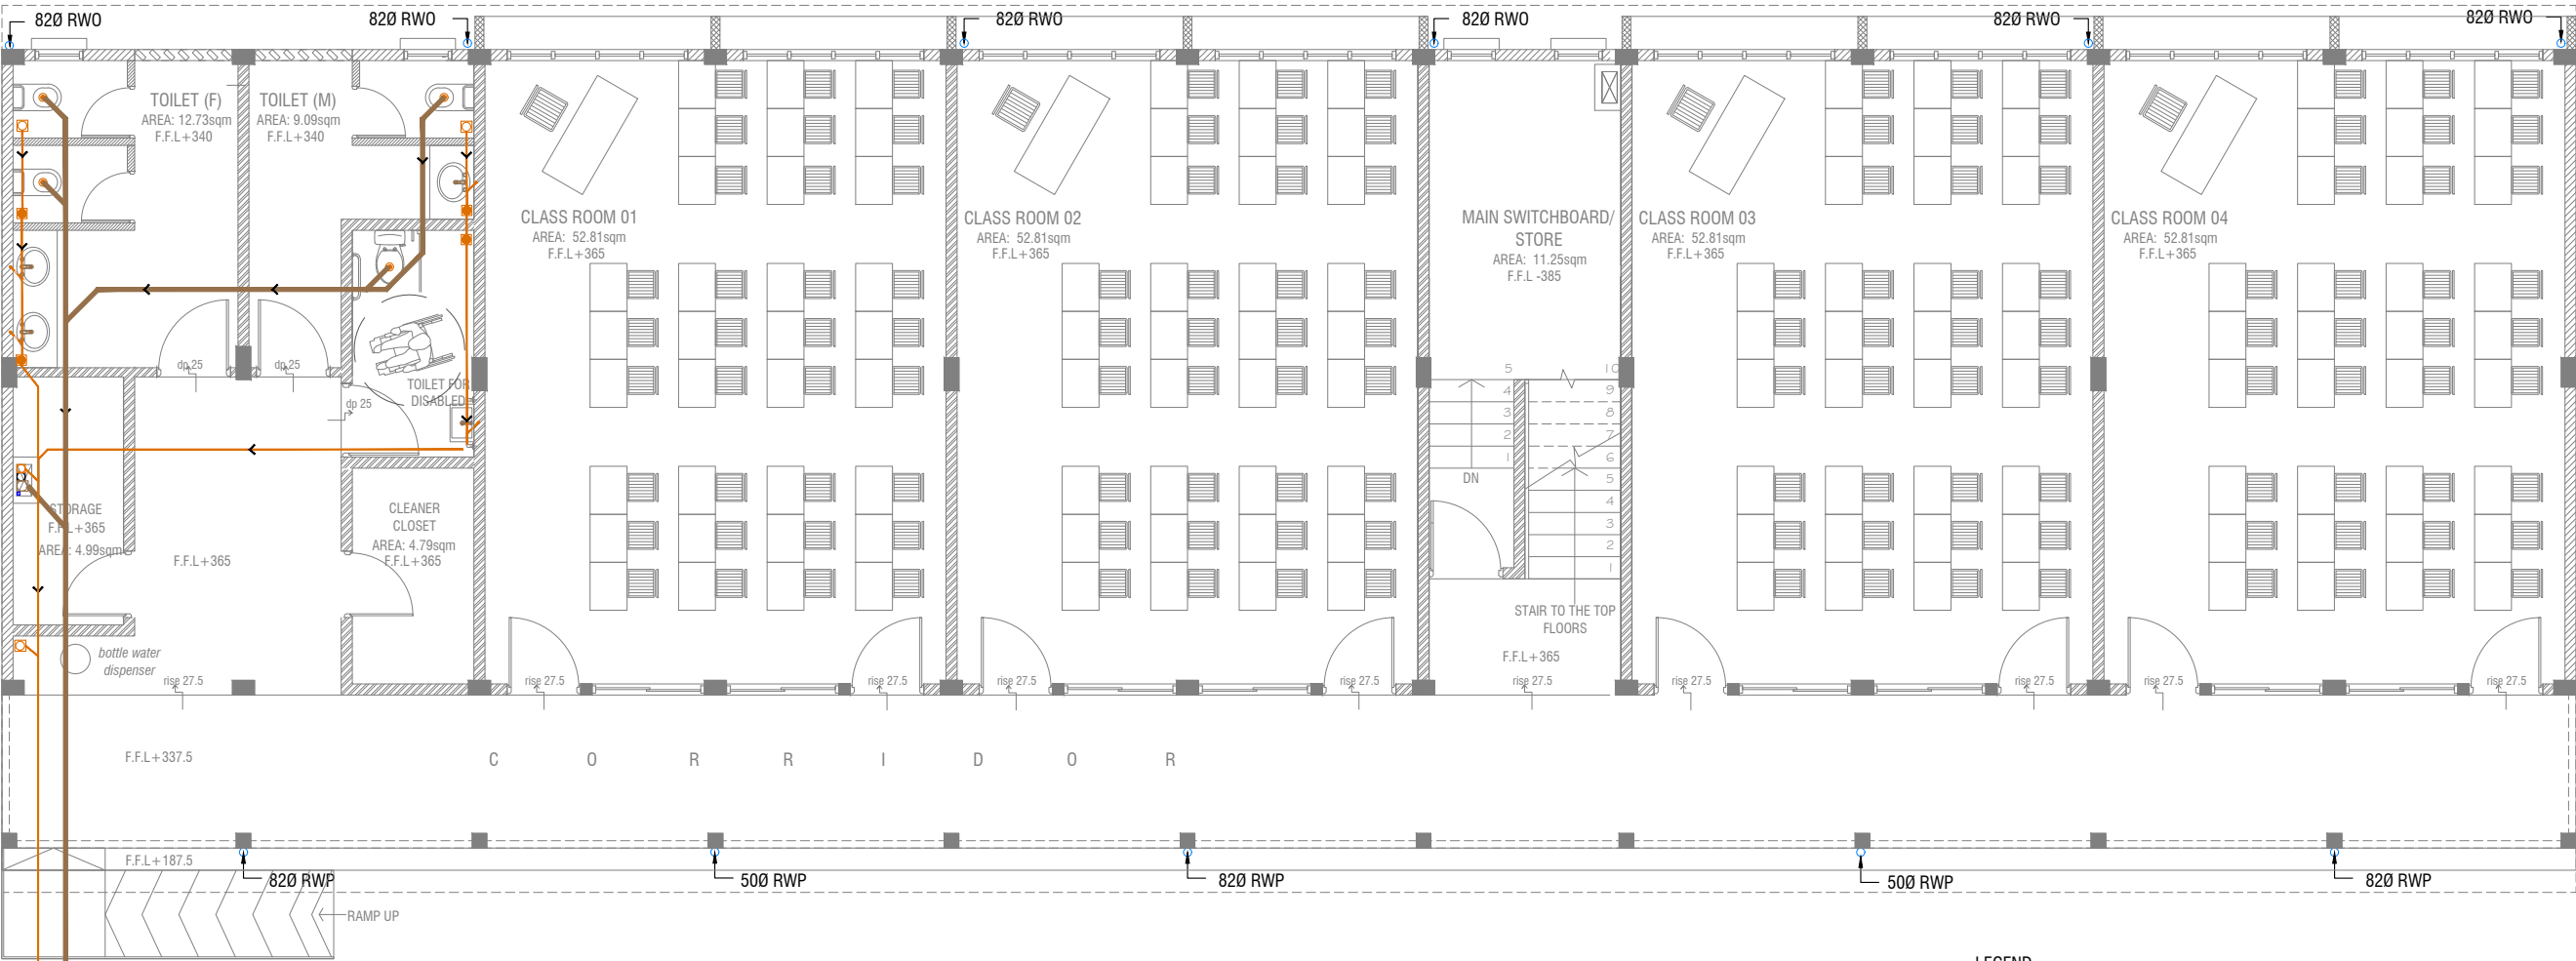

CONNECTED TO PROPOSED SEPTIC TANK



- LEGEND
- FG FLOOR GULLY
 - FD FLOOR DRAIN
 - WM 40 Ø STUB FOR WASHING MACHINE
 - SP 110 Ø SOIL PIPE
 - SVP 110 Ø SOIL VENT PIPE
 - WP 82 Ø WASTE PIPE
 - WVP 82 Ø WASTE VENT PIPE
 - WP 40 Ø WASTE PIPE
 - RWP 82/50 Ø RAINWATER PIPE
 - RWO 82/50 Ø DRAIN OUTLET
 - CD 25 Ø DRAIN PIPE
 - MHVP 50 Ø MANHOLE VENT PIPE

NOTE:
- ALL RAINWATER PIPES TO BE AT GROUND LEVEL
DISCHARGED THROUGH A PERFORATED COWL OR TO A SOAK PIT
- ALL SOIL AND WASTE PIPES TO BE AT GROUND
LEVEL, UNDER THE SLAB.

GROUND FLOOR DRAINAGE LAYOUT



Sn.Hithadhoo Noorani School - 12 Classroom (03 Storey)


Client: Ministry of Education

Project Number	Rev	Date
RI/2020/006		
Date	March	2021
Architect	Mariyam Irasha Shareef	
Engineer	Mohamed Muththalib Waleed	
Drawn by	Mariyam Leevan Jaleel	
Services	Aishath Ahmed	

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Title: Ground Floor
Drainage Layout
Page: DR 01-03



FIRST - SECOND FLOOR DRAINAGE LAYOUT

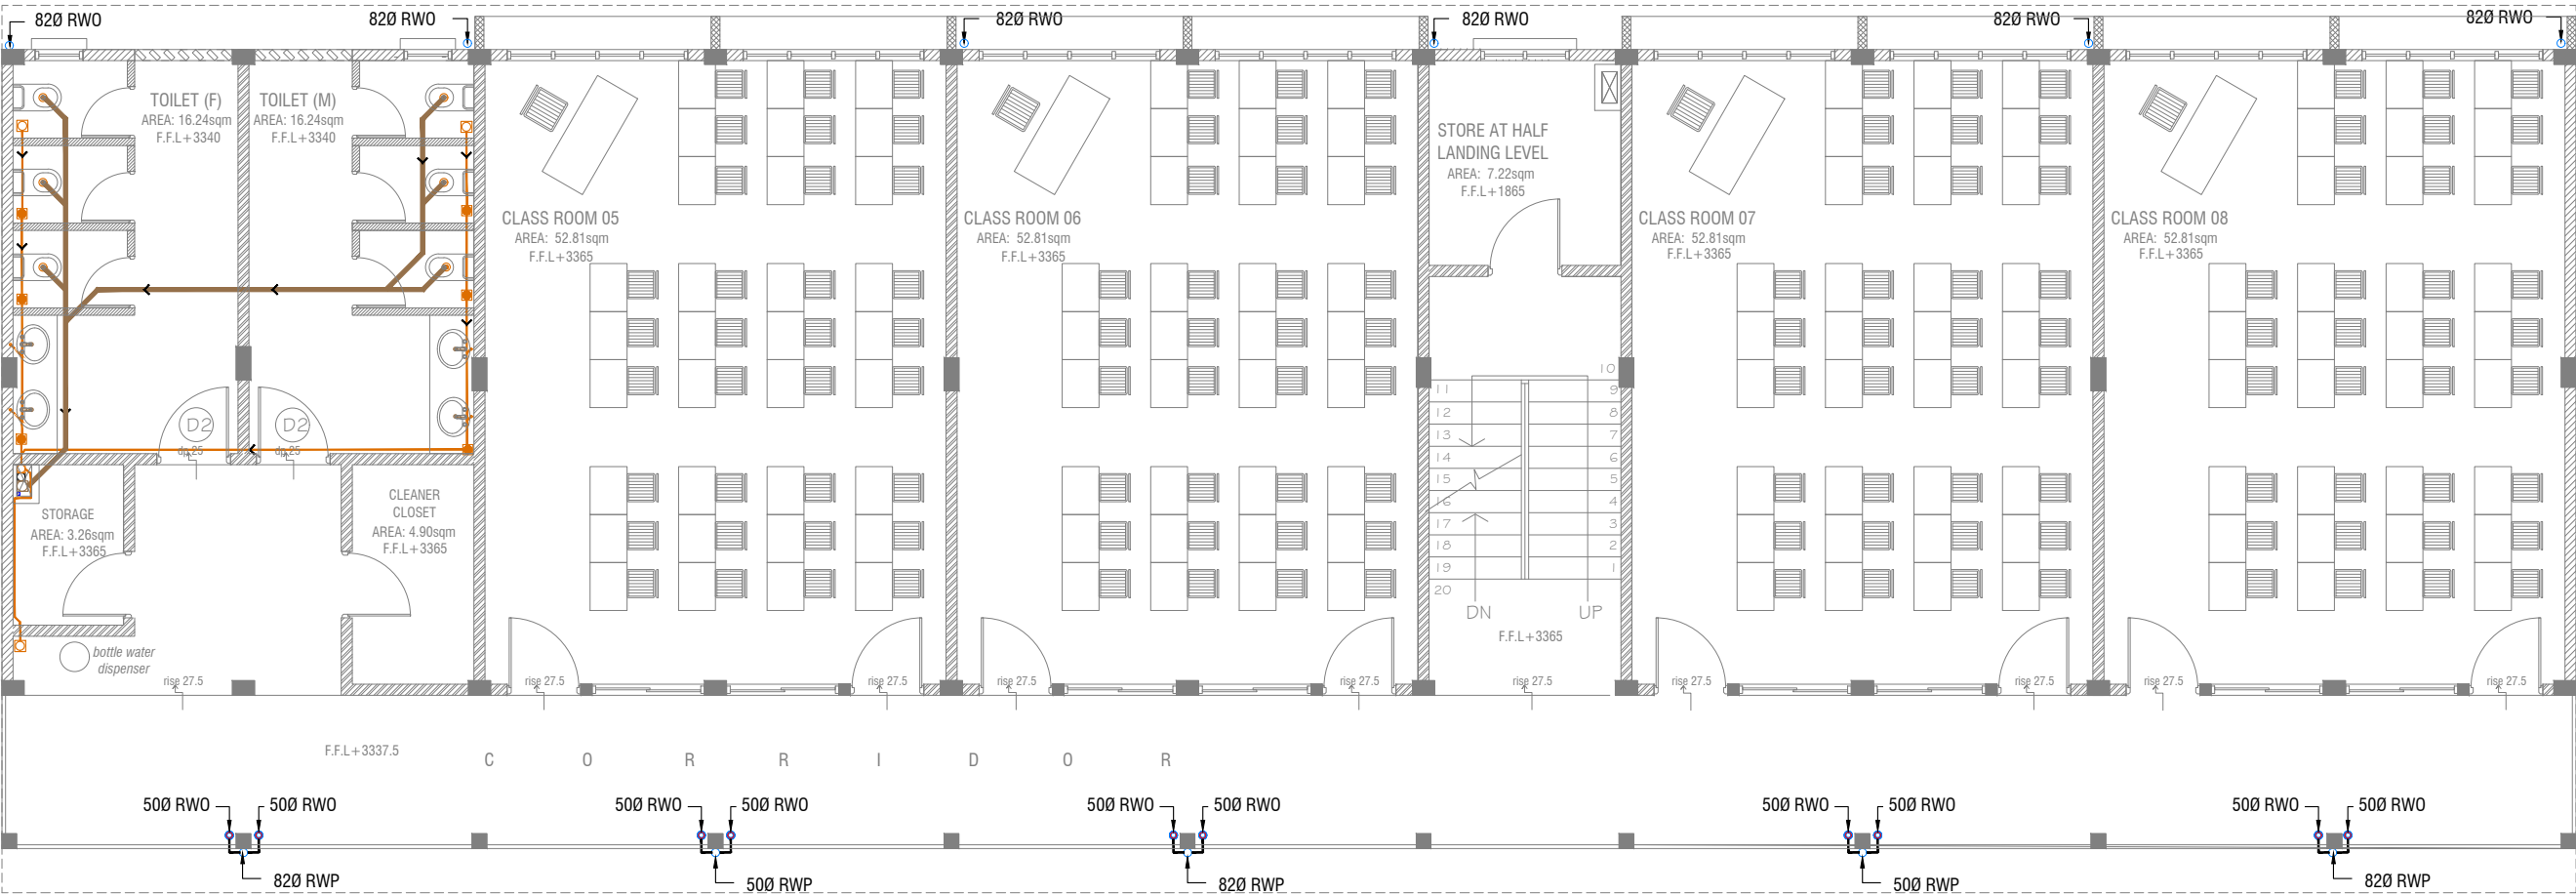

- LEGEND
- FG FLOOR GULLY
 - FD FLOOR DRAIN
 - WM 40 Ø STUB FOR WASHING MACHINE
 - SP 110 Ø SOIL PIPE
 - SVP 110 Ø SOIL VENT PIPE
 - WP 82 Ø WASTE PIPE
 - WVP 82 Ø WASTE VENT PIPE
 - WP 40 Ø WASTE PIPE
 - RWP 82/50 Ø RAINWATER PIPE
 - RWO 82/50 Ø DRAIN OUTLET
 - CD 25 Ø DRAIN PIPE
 - MHVP 50 Ø MANHOLE VENT PIPE

NOTE:
- ALL SOIL AND WASTE PIPES TO BE UNDER THE SLAB LEVEL.

Sn.Hithadhoo Noorani School - 12 Classroom (03 Storey)
Client: Ministry of Education

Rev no	Date
1	2021
2	2021
3	2021
4	2021
5	2021

Project Number: RI/2020/006
Date: March 2021
Architect: Mariyam Irasha Shareef
Engineer: Mohamed Muthalib Waleed
Drawn by: Mariyam Leevan Jaleel
Services: Aishath Ahmed



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











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Title: First - Second Floor
Drainage Layout

Page: DR 02- 03



LEGEND

FG		FLOOR GULLY
FD		FLOOR DRAIN
WM		40 Ø STUB FOR WASHING MACHINE
SP		110 Ø SOIL PIPE
SVP		110 Ø SOIL VENT PIPE
WP		82 Ø WASTE PIPE
WVP		82 Ø WASTE VENT PIPE
WP		40 Ø WASTE PIPE
RWP		82/50 Ø RAINWATER PIPE
RWO		82/50 Ø DRAIN OUTLET
CD		25 Ø DRAIN PIPE
MHVP		50 Ø MANHOLE VENT PIPE

Sn.Hithadhoo Noorani School - 12 Classroom (03 Storey)
Client: Ministry of Education

Project Number: RI/2020/006
Date: March 2021

Architect : Maryam Irasha Shareef	Rev no	Date
Engineer : Mohamed Muthalib Waleed	---	-----
Drawn by : Maryam Leevan Jaleel	---	-----
Services : Aishath Ahmed	---	-----




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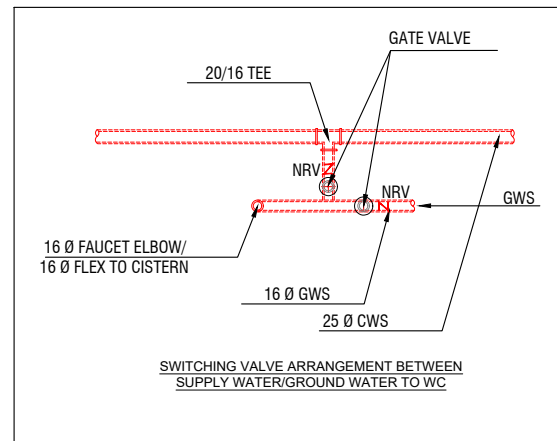
Title: Roof
Drainage Layout

Page: DR 03-03



GROUND FLOOR PLUMBING LAYOUT

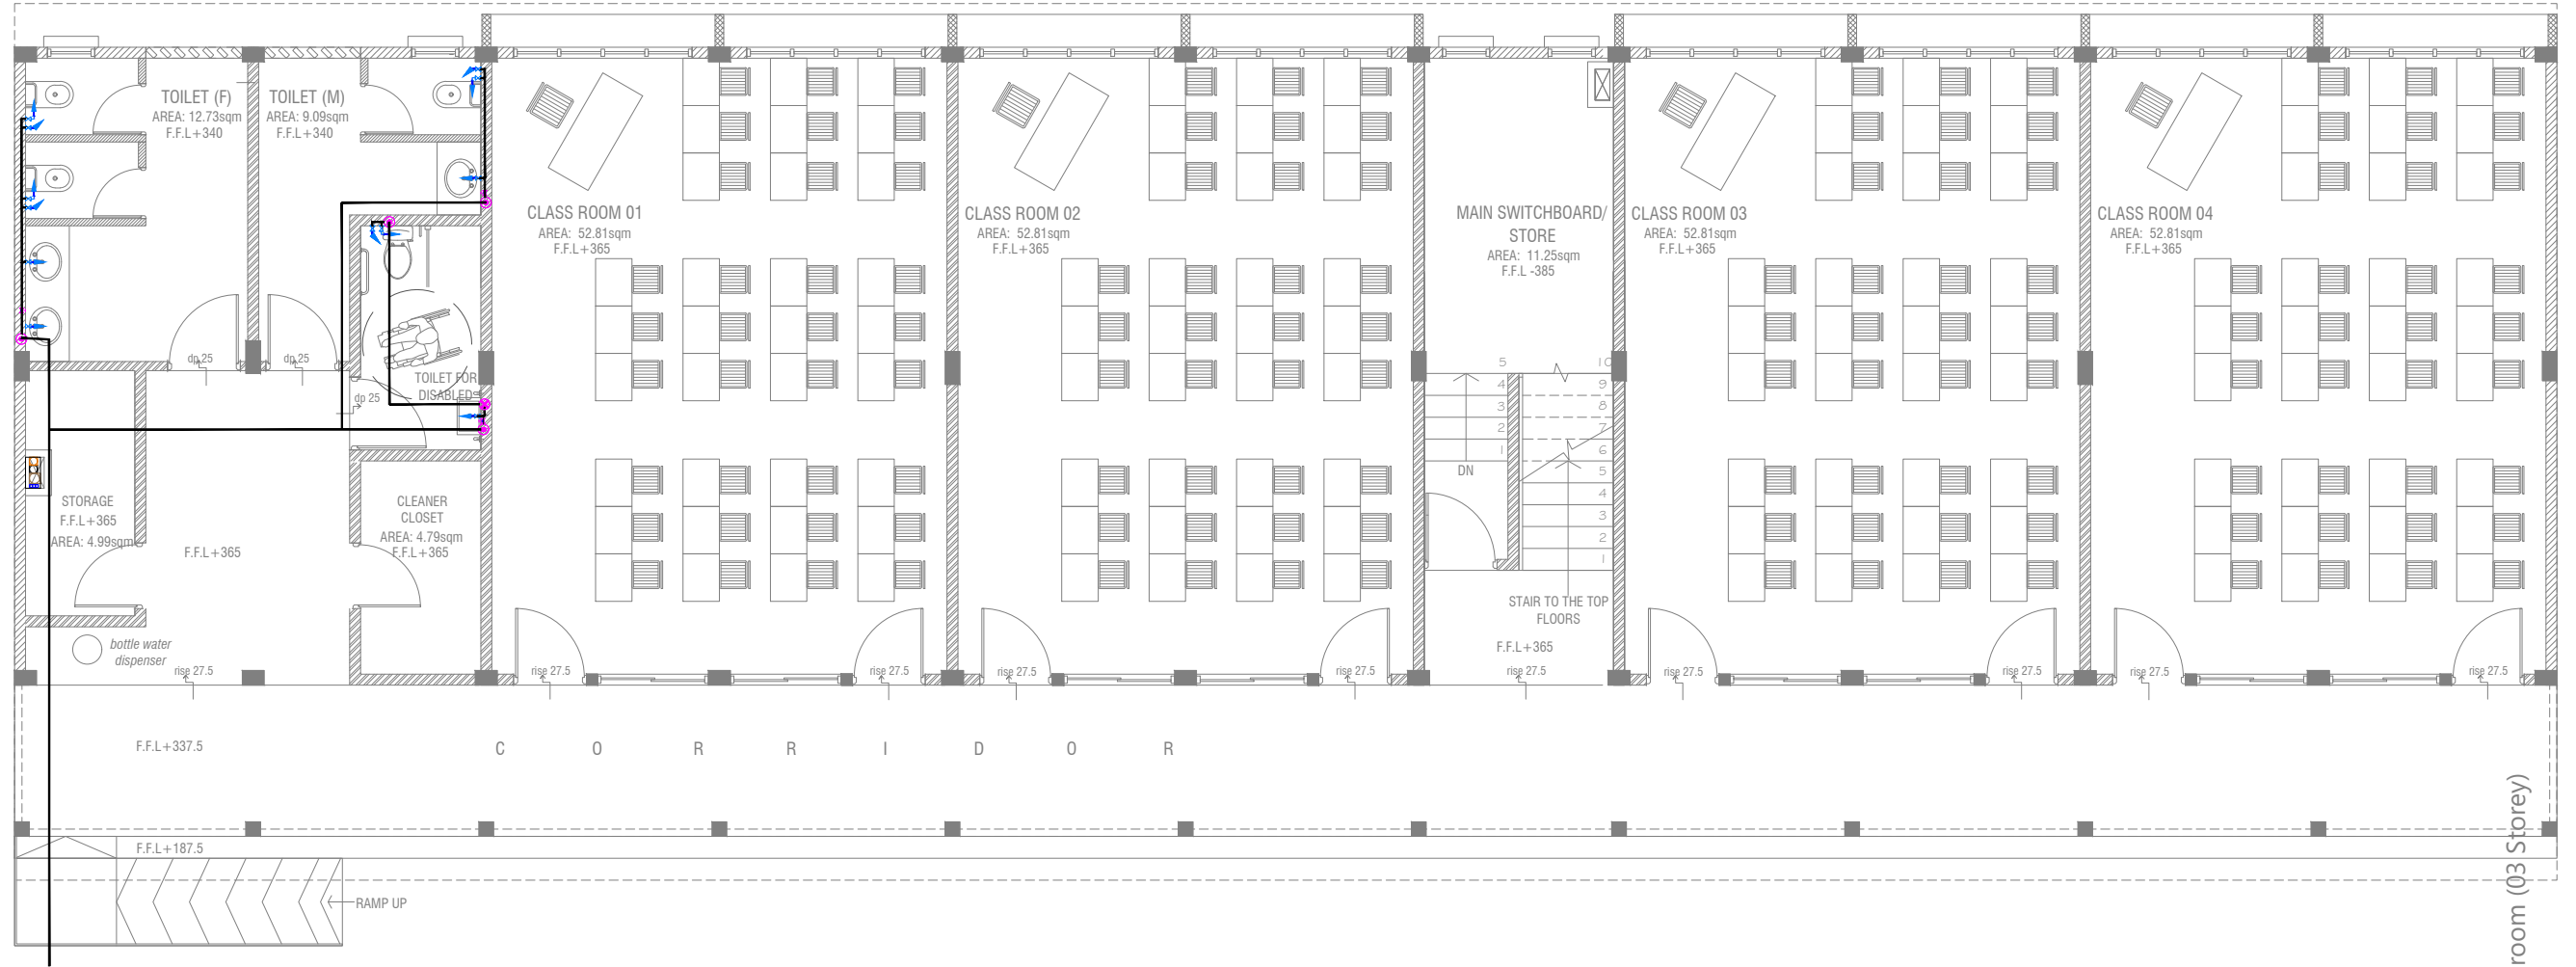SCALE 1:100



LEGEND

- 16 Ø COLD WATER SUPPLY TO CISTERN
- 16 Ø COLD WATER SUPPLY TO BIDET SHOWER
- 16 Ø COLD WATER SUPPLY TO BASIN FAUCET / SINK
- GV GATE VALVE
- 25 Ø COLD WATER SUPPLY PIPES RUN UNDERGROUND
- 25 Ø COLD WATER SUPPLY PIPES RUN IN WALL / UNDER FALSE CEILING
- RISE IN WALL
- DROP IN WALL
- CWS** COLD WATER SUPPLY
- HWS** HOT WATER SUPPLY
- GROUND WATER SUPPLY

NOTE:

- THE WELL SHALL BE RELOCATED ACCORDING TO THE SALINITY OF THE GROUND WATER.
- BASED ON WELL LOCATION PUMP CAPACITY TO BE DECIDED

Sn.Hithadhoo Noorani School - 12 Classroom (03 Storey)
Client: Ministry of Education

Project Number: RI/2020/006

Date: March 2021

Architect: Mariyam Irshad Shareef

Engineer: Mohamed Muthalib Waleed

Drawn by: Mariyam Leevan Jaleel

Services: Aishath Ahmed

Rev no


Date

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Title: Ground Floor
Plumbing Layout

Page: PL 01-02



FIRST - SECOND FLOOR PLUMBING LAYOUT

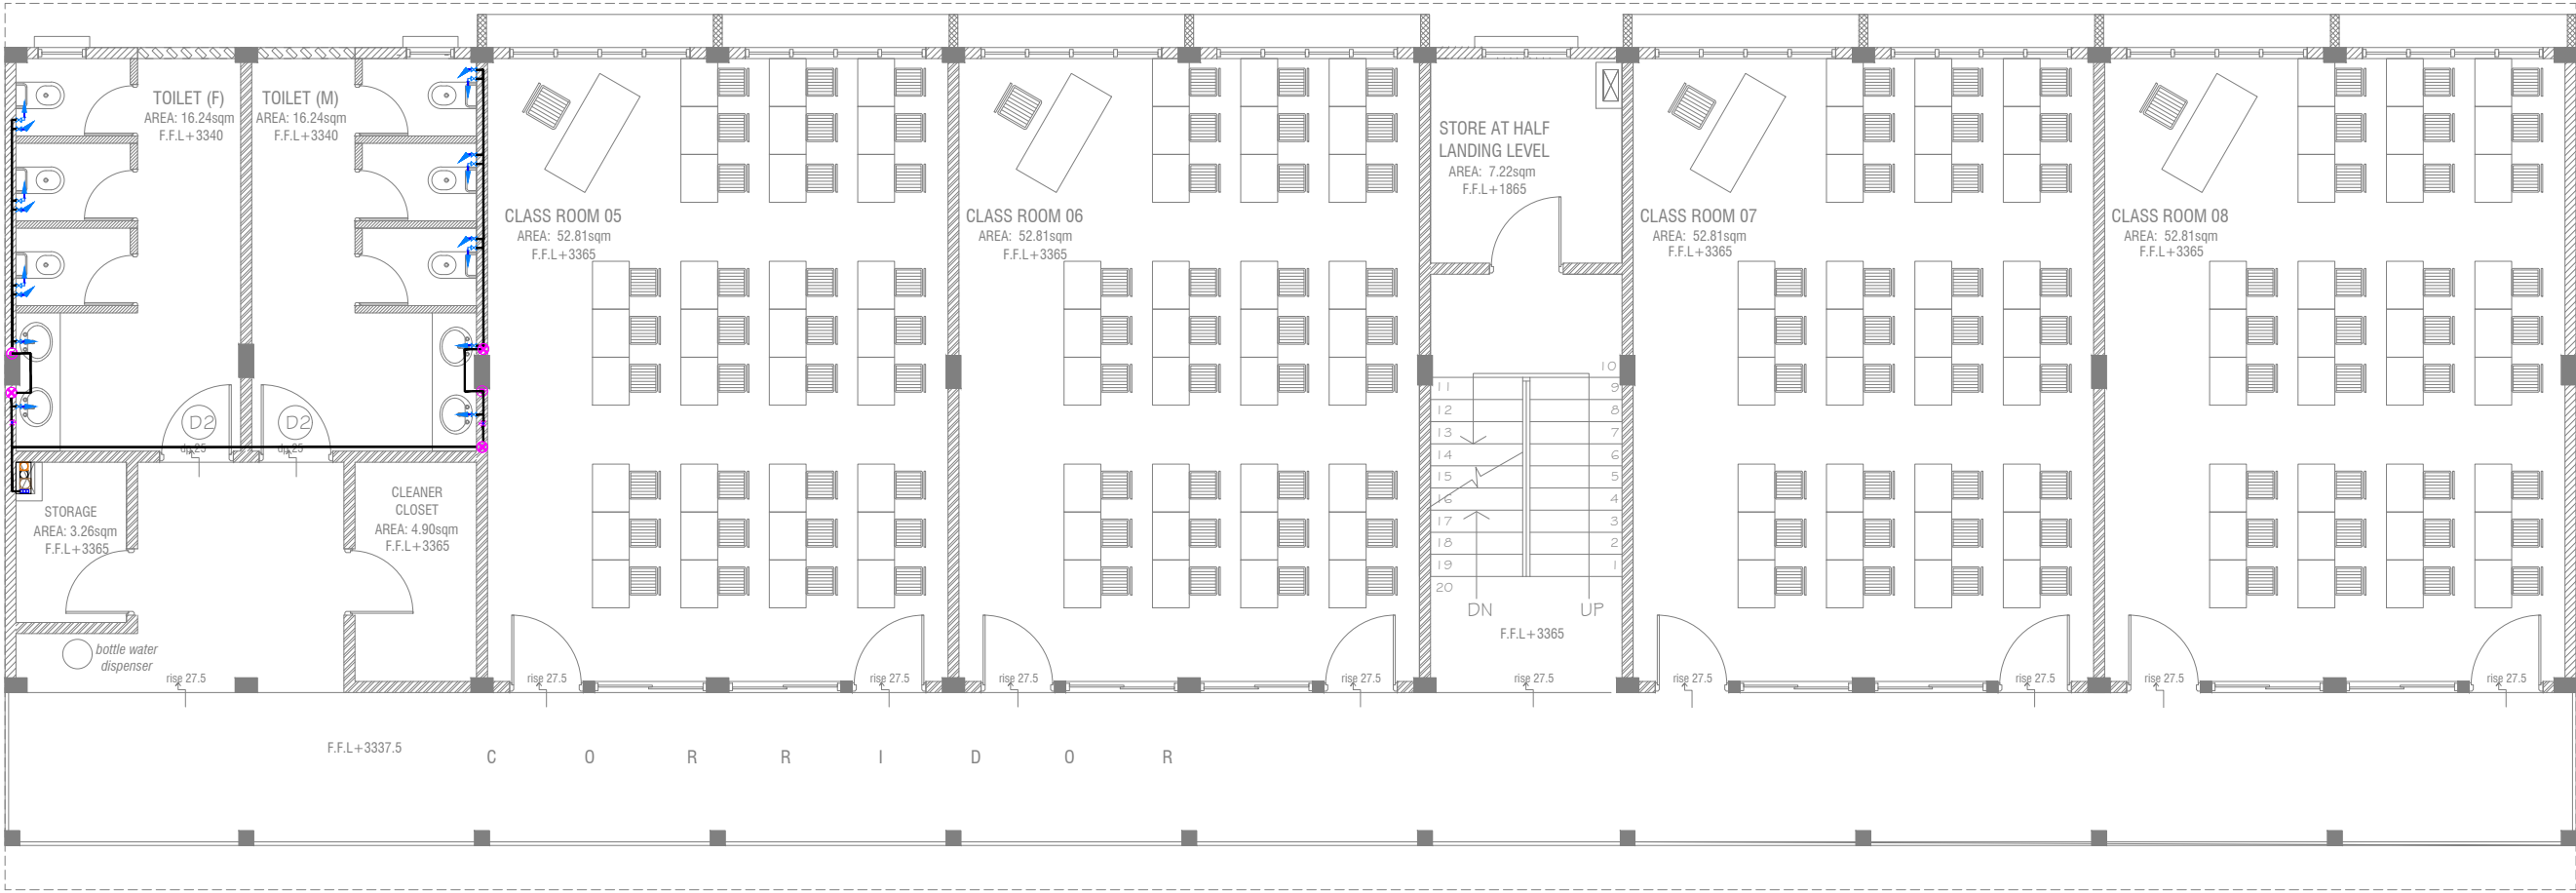


- LEGEND**
- 16 Ø COLD WATER SUPPLY TO CISTERN
 - 16 Ø COLD WATER SUPPLY TO BIDET SHOWER
 - 16 Ø COLD WATER SUPPLY TO BASIN FAUCET / SINK
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 - 25 Ø COLD WATER SUPPLY PIPES RUN IN WALL / UNDER FALSE CEILING
 - RISE IN WALL
 - DROP IN WALL
 - CWS COLD WATER SUPPLY
 - HWS HOT WATER SUPPLY
 - GROUND WATER SUPPLY

Sn.Hithadhoo Noorani School - 12 Classroom (03 Storey)
Client: Ministry of Education

Project Number: RI/2020/006
Date: March 2021
Architect: Mariyam Irasha Shareef
Engineer: Mohamed Muthalib Waleed
Drawn by: Mariyam Leevan Jaleel
Services: Aishath Ahmed

Rev no	Date
1	
2	
3	

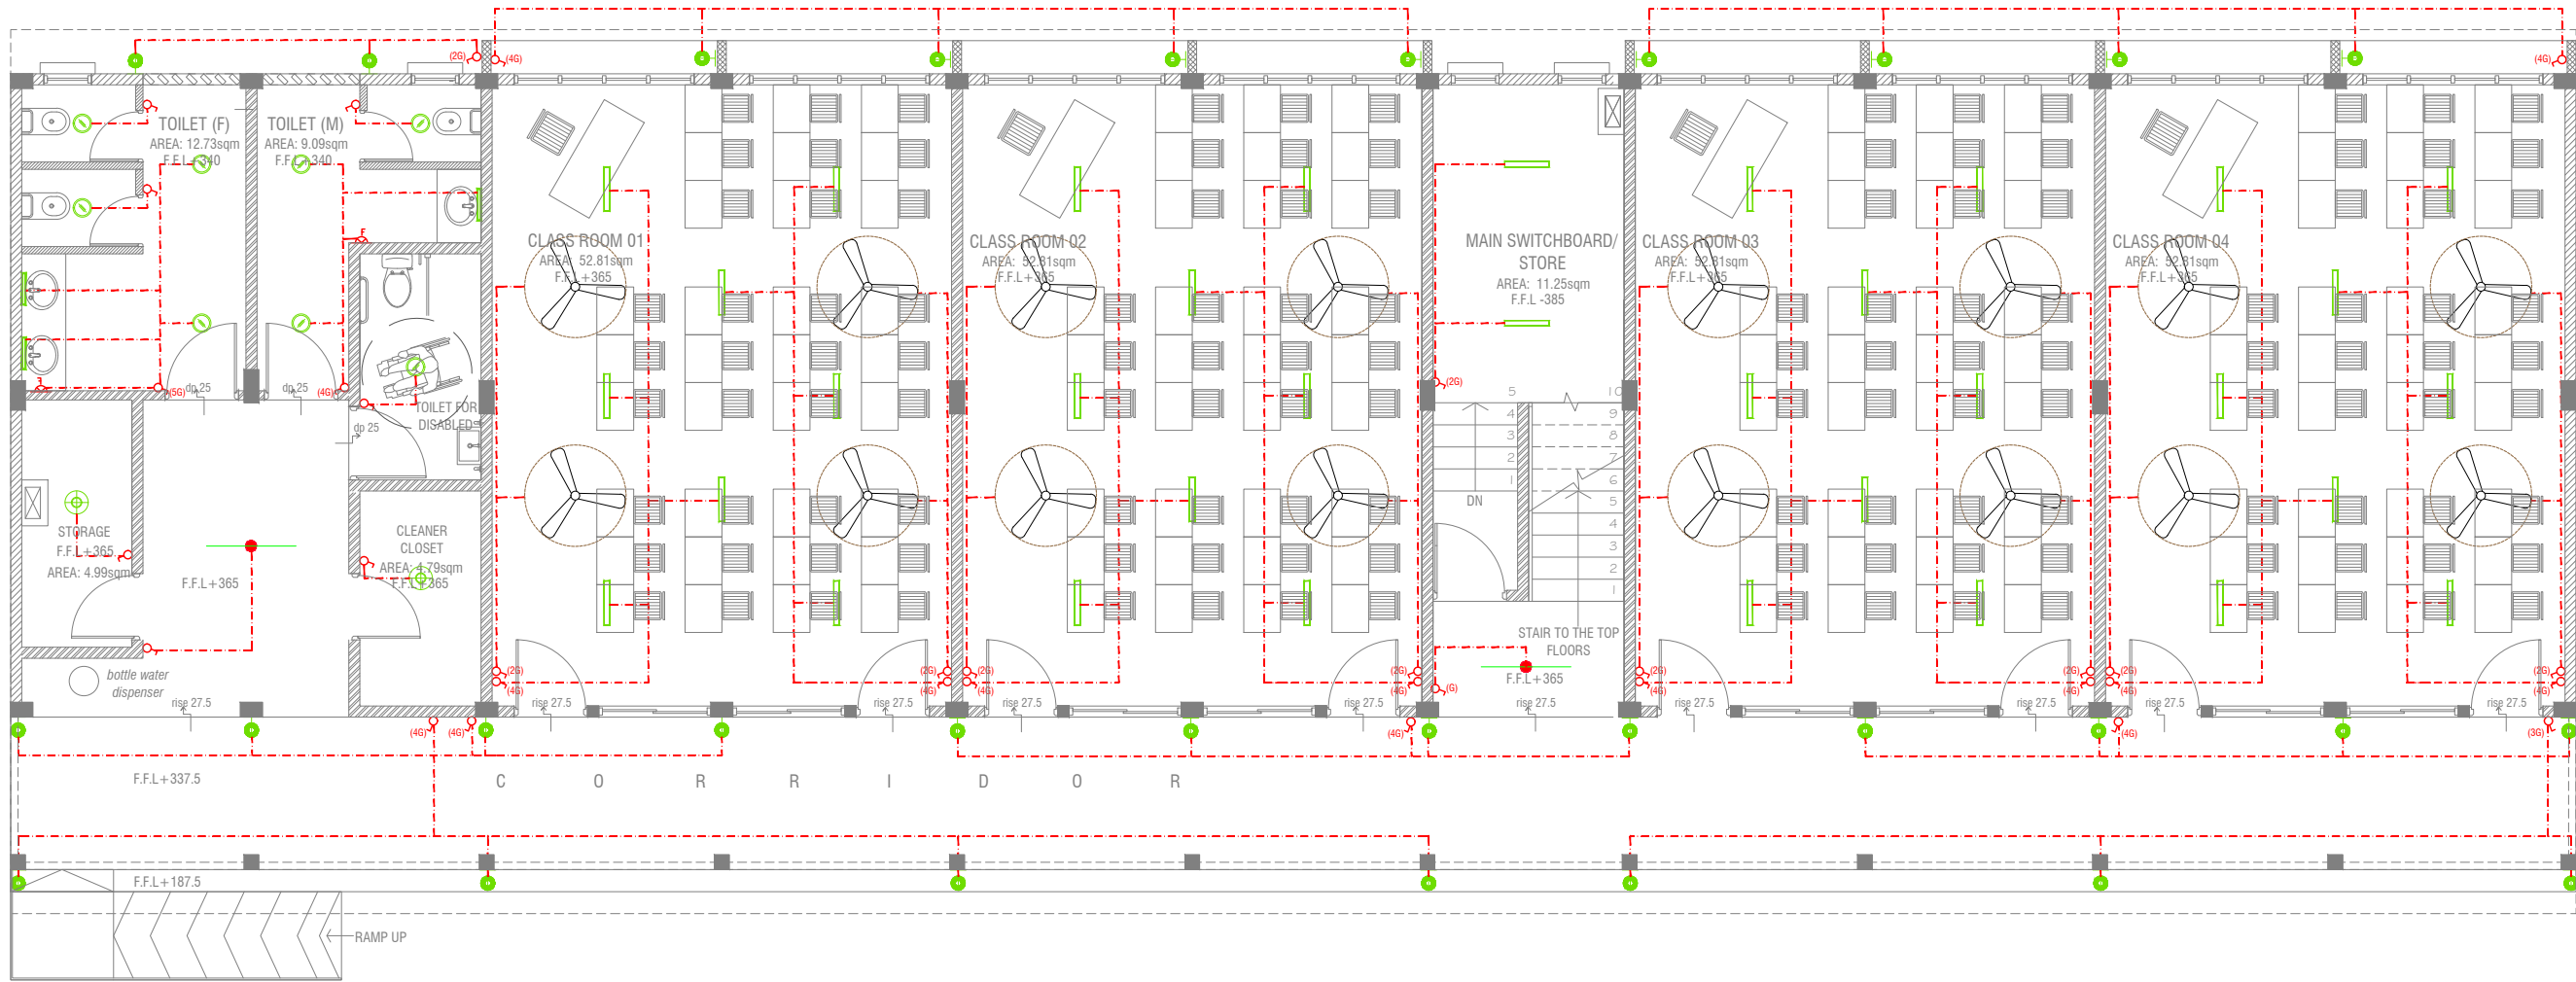


GROUND FLOOR LIGHTING LAYOUT

SCALE 1:100

LEGEND

- WPD 40W (IP 65) OUT DOOR WALL LIGHT
- ML MIRROR LIGHT (7W LED LIGHT)
- H2 LED RECESSED DOWN LIGHT 12W
- CL LED CEILING LIGHT 18W
- WP LED TUBE LIGHT WITH WEATHER PROOF OPAL CASING
- C2 LED CEILING DOWN LIGHT (18W)
- LIGHT SWITCH
- SWITCHING LINE
- EXHAUST

CL2 LED TUBE LIGHT WITH OPAL CASING

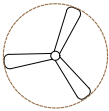

CEILING FAN (52" - 54")

NOTE:

- ALL WIRING TO BE OF STELCO APPROVED STANDARDS
- SWITCH CONTROL = 1200MM FROM FLOOR FIN. LEVEL
- ALL LIGHTING POINTS CONNECTED TO THEIR RESPECTIVE DB
- POLYCARBONATE ENCLOSURE TO ALL SWITCH AND SOCKET WHICH ARE LOCATED AT THE OUTDOORS


Sn.Hithadhoo Noorani School - 12 Classroom (03 Storey)
Client: Ministry of Education

Project Number	Rev	Date
RI/2020/006		
Date March 2021		
Architect : Mariyam Irasha Shareef		
Engineer : Mohamed Munthaliab Waleed		
Drawn by : Mariyam Leevan Jaleel		
Services : Aishath Ahmed		



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FIRST - SECOND FLOOR LIGHTING LAYOUT

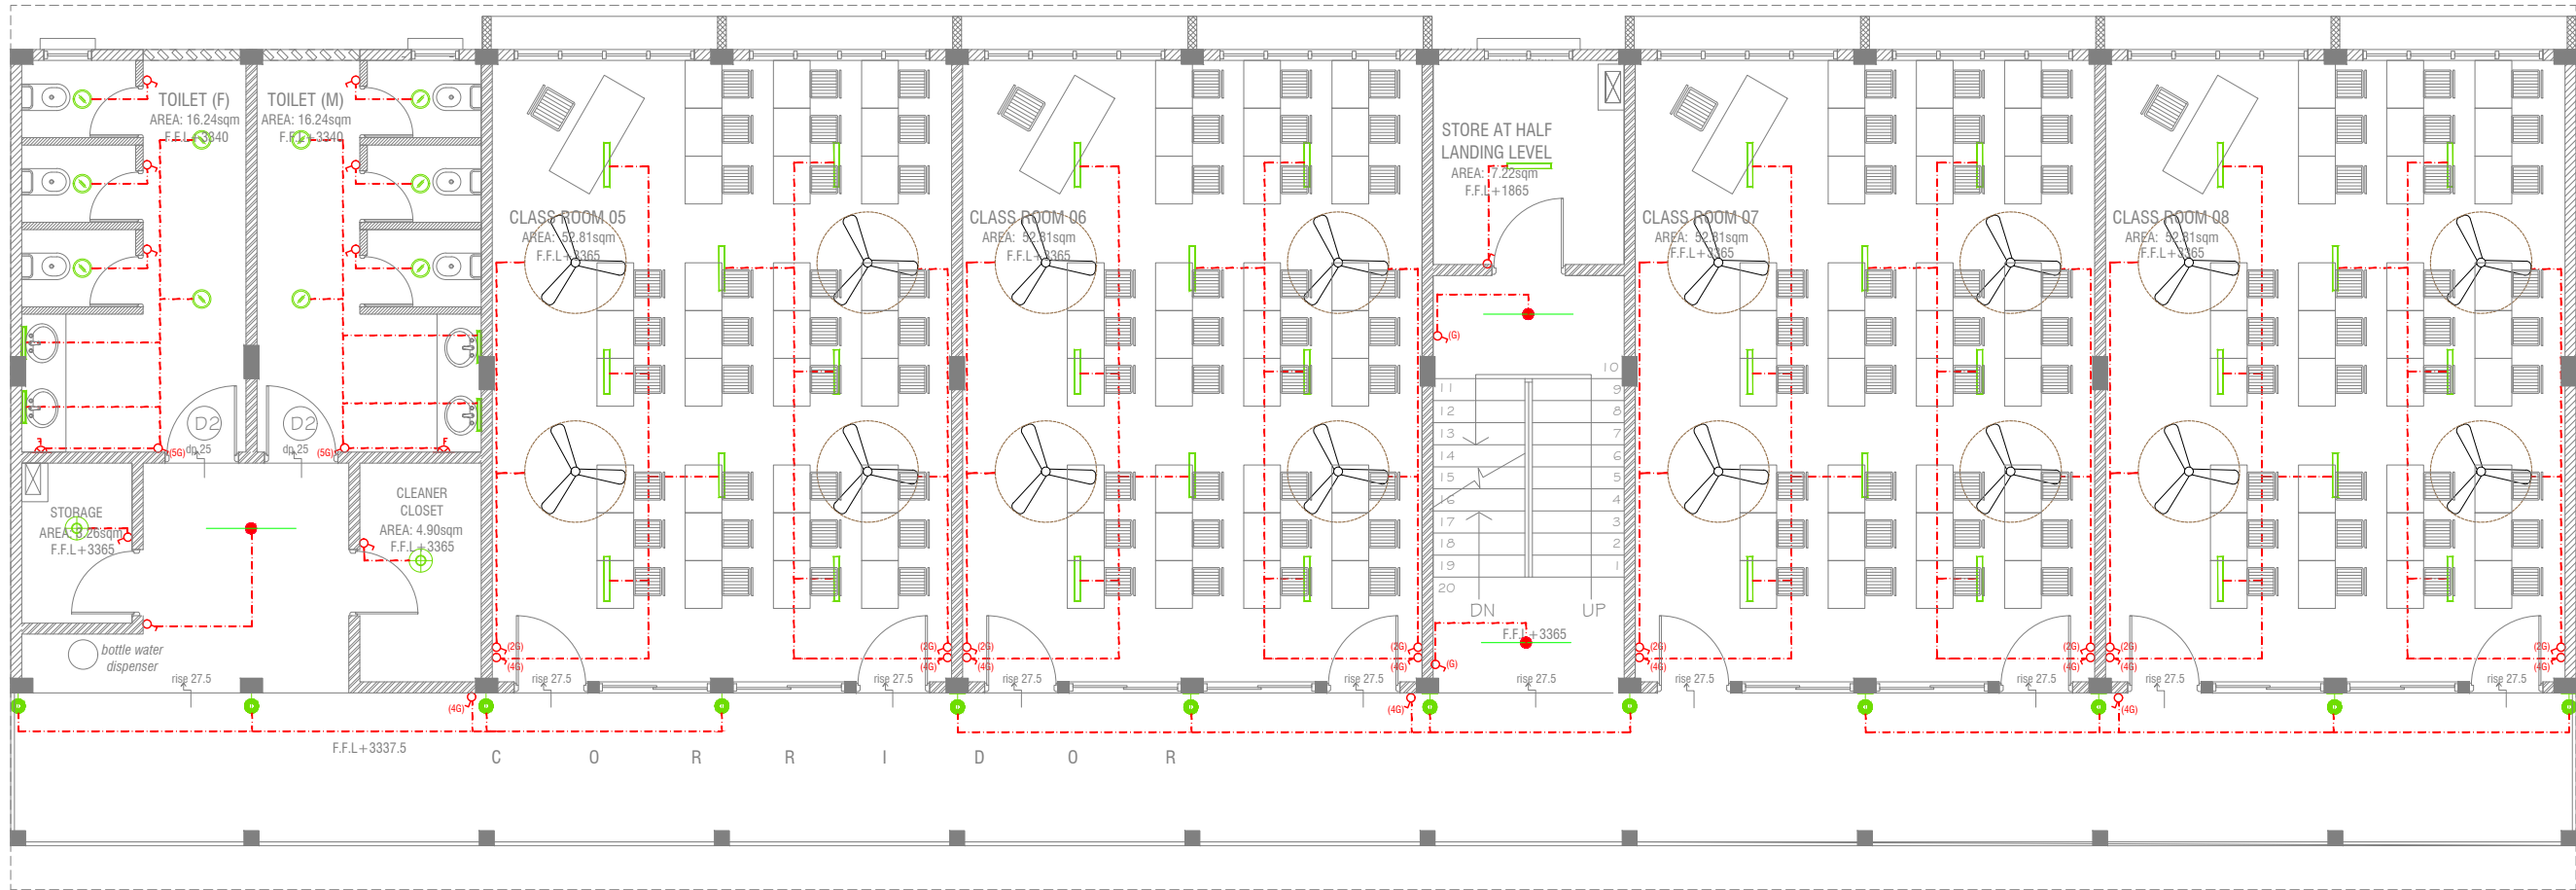

LEGEND

- WPD 40W (IP 65) OUT DOOR WALL LIGHT
- ML MIRROR LIGHT (7W LED LIGHT)
- H2 LED RECESSED DOWN LIGHT 12W
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CL2 LED TUBE LIGHT WITH OPAL CASING



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- POLYCARBONATE ENCLOSURE TO ALL SWITCH AND SOCKET WHICH ARE LOCATED AT THE OUTDOORS

Sn.Hithadhoo Noorani School - 12 Classroom (03 Storey)
Client: Ministry of Education

Rev no	Date
1	
2	
3	
4	
5	

Project Number: RI/2020/006
Date: March 2021
Architect: Mariyam Iqbal Shareef
Engineer: Mohamed Muthalib Waleed
Drawn by: Mariyam Leevan Jaleel
Services: Aishath Ahmed




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Title: First - Second Flo
Lighting Layout

Page: EL 02-02

PVC DUCT FOR DATA CABLE LEAD IN BELOW GR.SLAB



GROUND FLOOR POWER LAYOUT

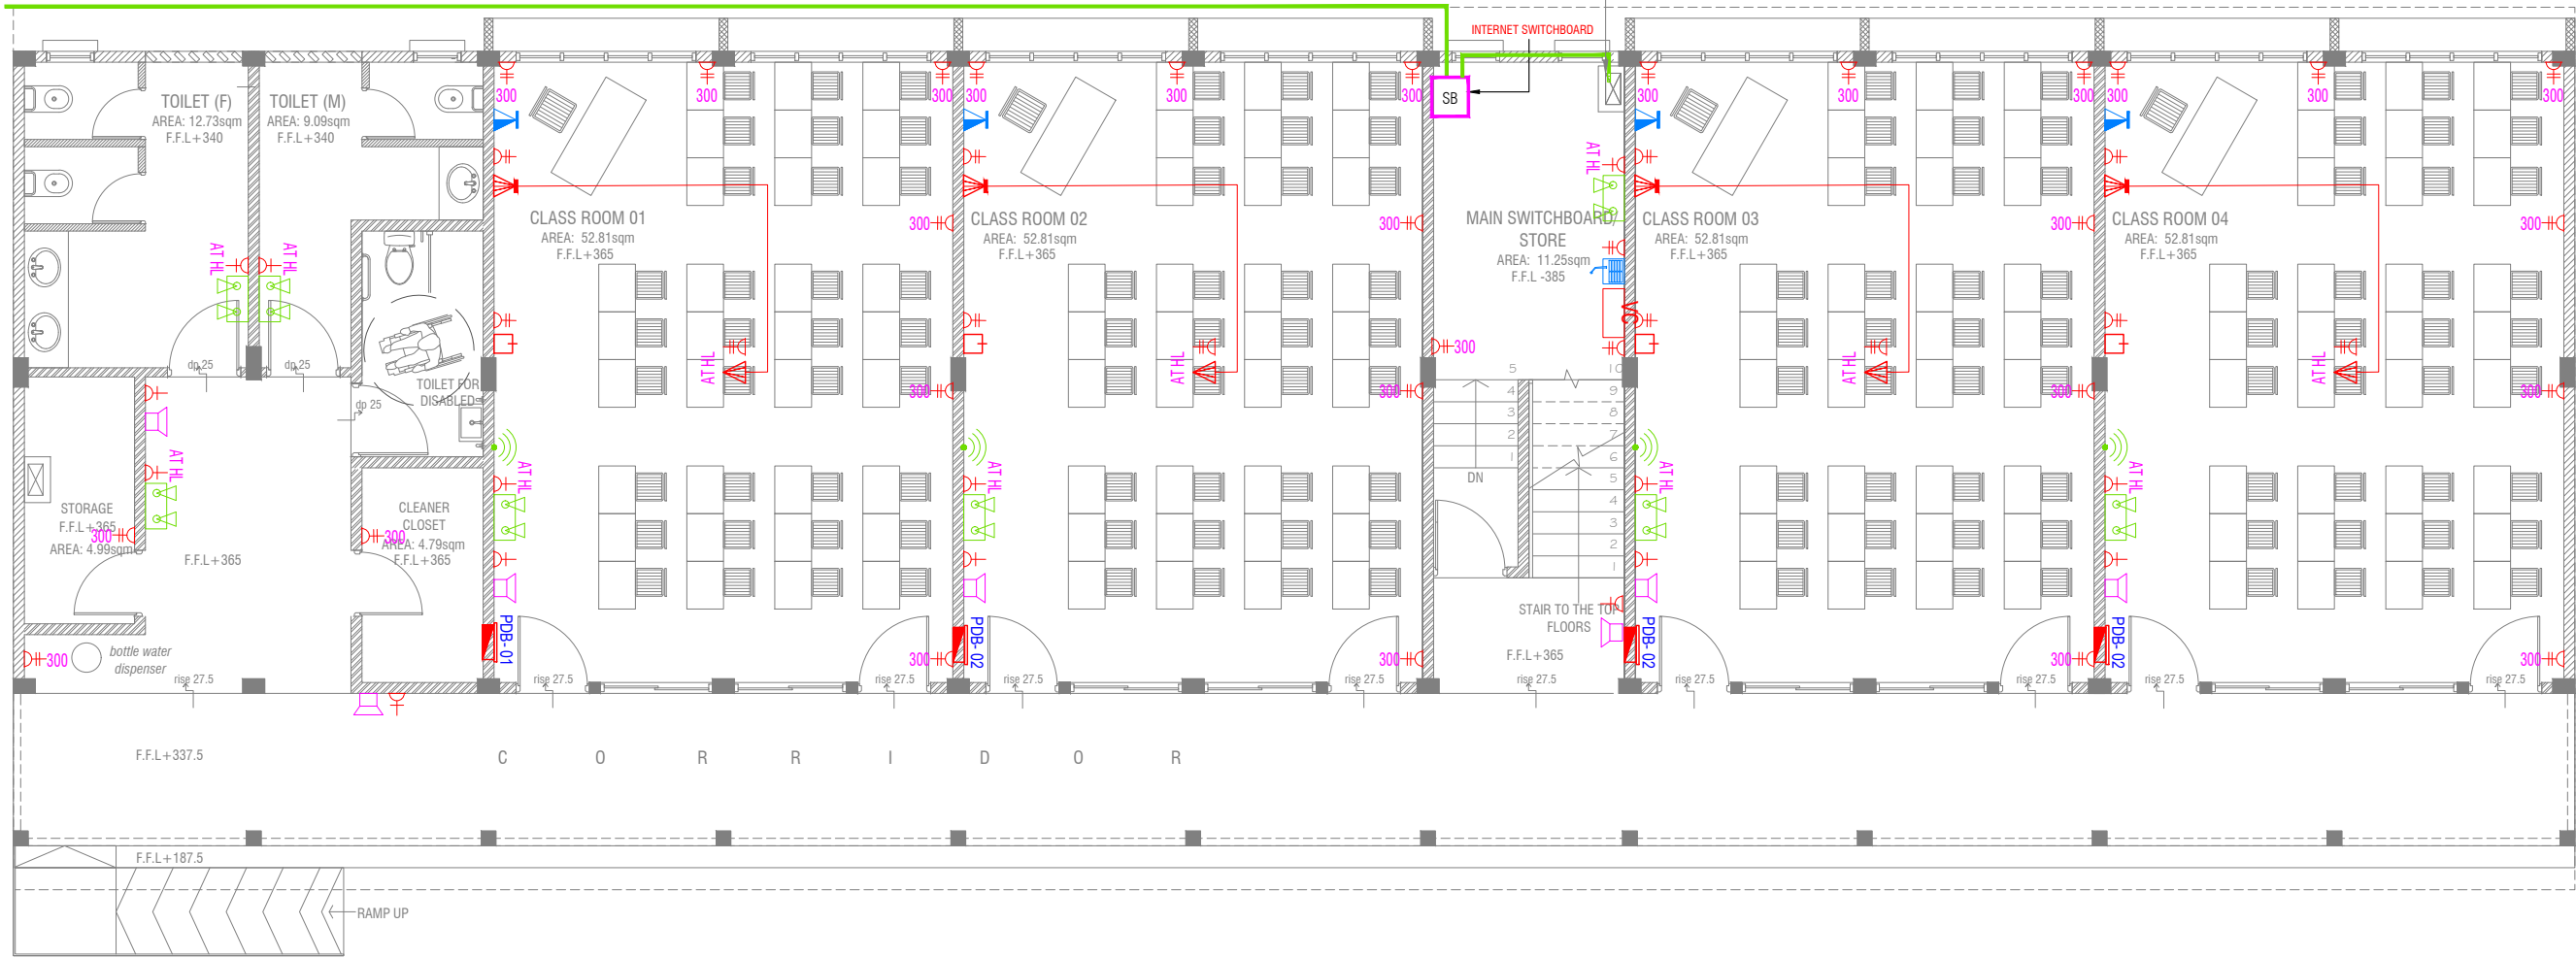SCALE 1:100



NOTE:

1. ALL WIRING TO BE OF APPROVED STANDARDS
2. POWER/IT/COMPUTER SOCKETS = 300MM - 450MM FROM FLOOR FIN. LEVEL
3. SWITCH CONTROL / SOCKET = 1100MM - 1200MM FROM FLOOR FIN. LEVEL
4. KITCHEN SOCKETS / PANTRY SOCKETS = 1150MM - 1250MM FROM FLOOR FIN. LEVEL
5. AC = 2500MM - 2700MM FROM FLOOR FIN. LEVEL

LEGEND

- TELEPHONE OUTLET (RJ11, CONNECTOR)
- 13A POWER OUTLET
- 13A TWIN SOCKET OUTLET
- HDMI,VGA & RAC AV SOCKET
- DISTRIBUTION BOX
- SPEAKERS
- HDMI,VGA & RAC AV TWIN SOCKET
- TWIN COMPUTER NETWORK OUTLET
- DATA POINT
- TWO GANG / TV SOCKET

- PAGING MIC
- VOLUME CONTROLLER
- EMERGENCY LIGHT

ALL ELECTRICAL COMPONENT TO BE CONNECTED TO THEIR RESPECTIVE DB

SPEAKERS TO BE CONNECTED TO THE MAIN PA SYSTEM OF THE SCHOOL

Sn.Hithadhoo Noorani School - 12 Classroom (03 Storey)
Client: Ministry of Education


Project Number: RI/2020/006
Date: March 2021
Architect: Mainiyam Irasha Shareef
Engineer: Mohammed Muththalib Waleed

Rev no
Date

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3rd floor, H. Azum, Amee

Title: Ground Floor Power Lay
Page: EP 01-02

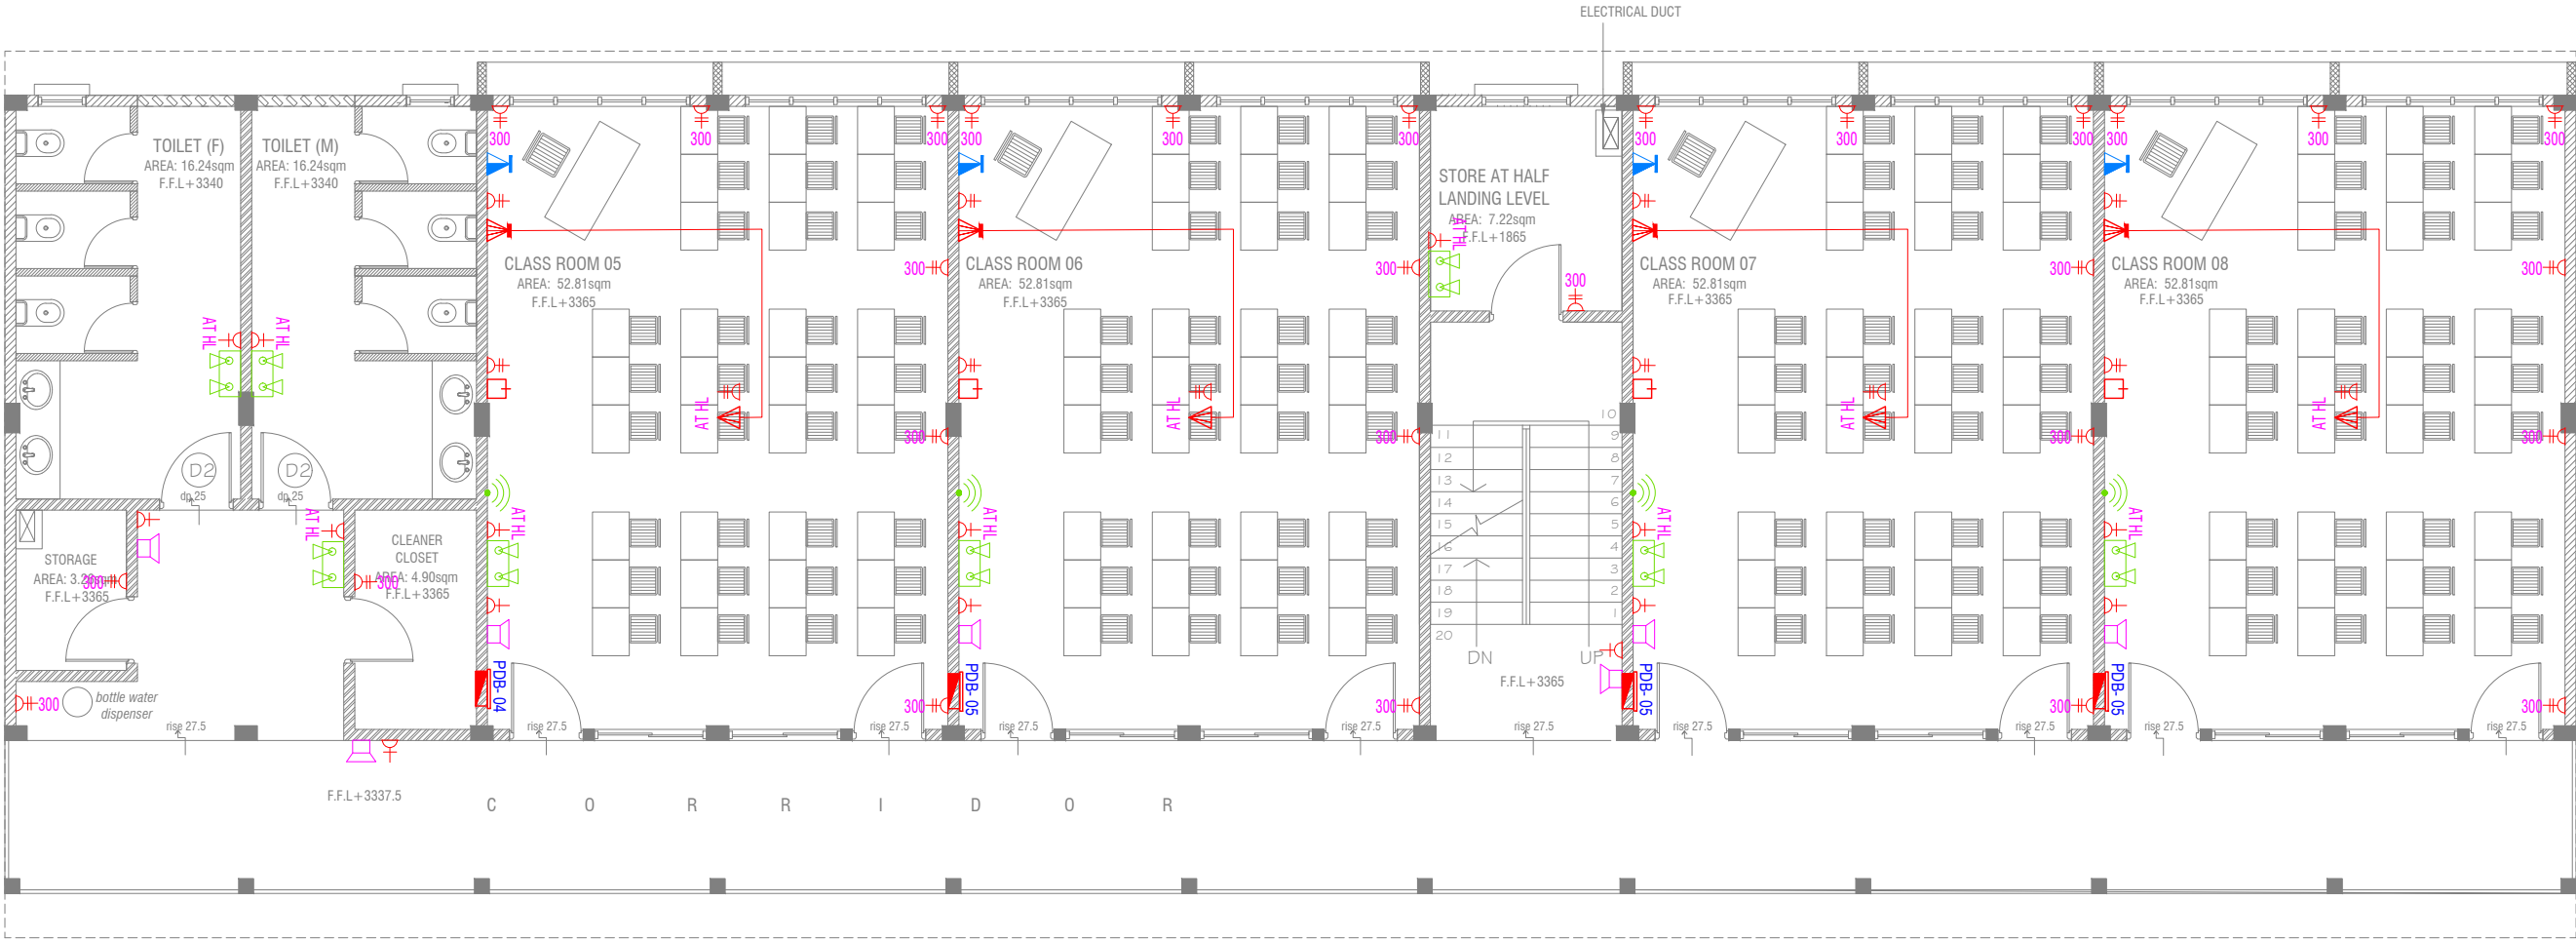

FIRST - SECOND FLOOR POWER LAYOUT

SCALE 1:100

0 0.5 1 2 3 4 5

NOTE:

1. ALL WIRING TO BE OF APPROVED STANDARDS
2. POWER/IT/COMPUTER SOCKETS = 300MM - 450MM FROM FLOOR FIN. LEVEL
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5. AC = 2500MM - 2700MM FROM FLOOR FIN. LEVEL

LEGEND

- TELEPHONE OUTLET (RJ11, CONNECTOR)
- 13A POWER OUTLET
- 13A TWIN SOCKET OUTLET
- HDMI,VGA & RAC AV SOCKET
- DISTRIBUTION BOX
- SPEAKERS
- HDMI,VGA & RAC AV TWIN SOCKET
- TWIN COMPUTER NETWORK OUTLET
- DATA POINT
- TWO GANG / TV SOCKET


- PAGING MIC
- VOLUME CONTROLLER
- EM EMERGENCY LIGHT

ALL ELECTRICAL COMPONENT TO BE CONNECTED TO THEIR RESPECTIVE DB

SPEAKERS TO BE CONNECTED TO THE MAIN PA SYSTEM OF THE SCHOOL

Sn.Hithadhoo Noorani School - 12 Classroom (03 Storey)
Client: Ministry of Education

Project Number	Rev	Rev no	Date
RI/2020/006			
Date: March 2021			
Architect: Mariyam Irshad Shareef			
Engineer: Mohamed Muthalib Waleed			
Drawn by: Mariyam Leevan Jaleel			
Services: Aishath Ahmed			

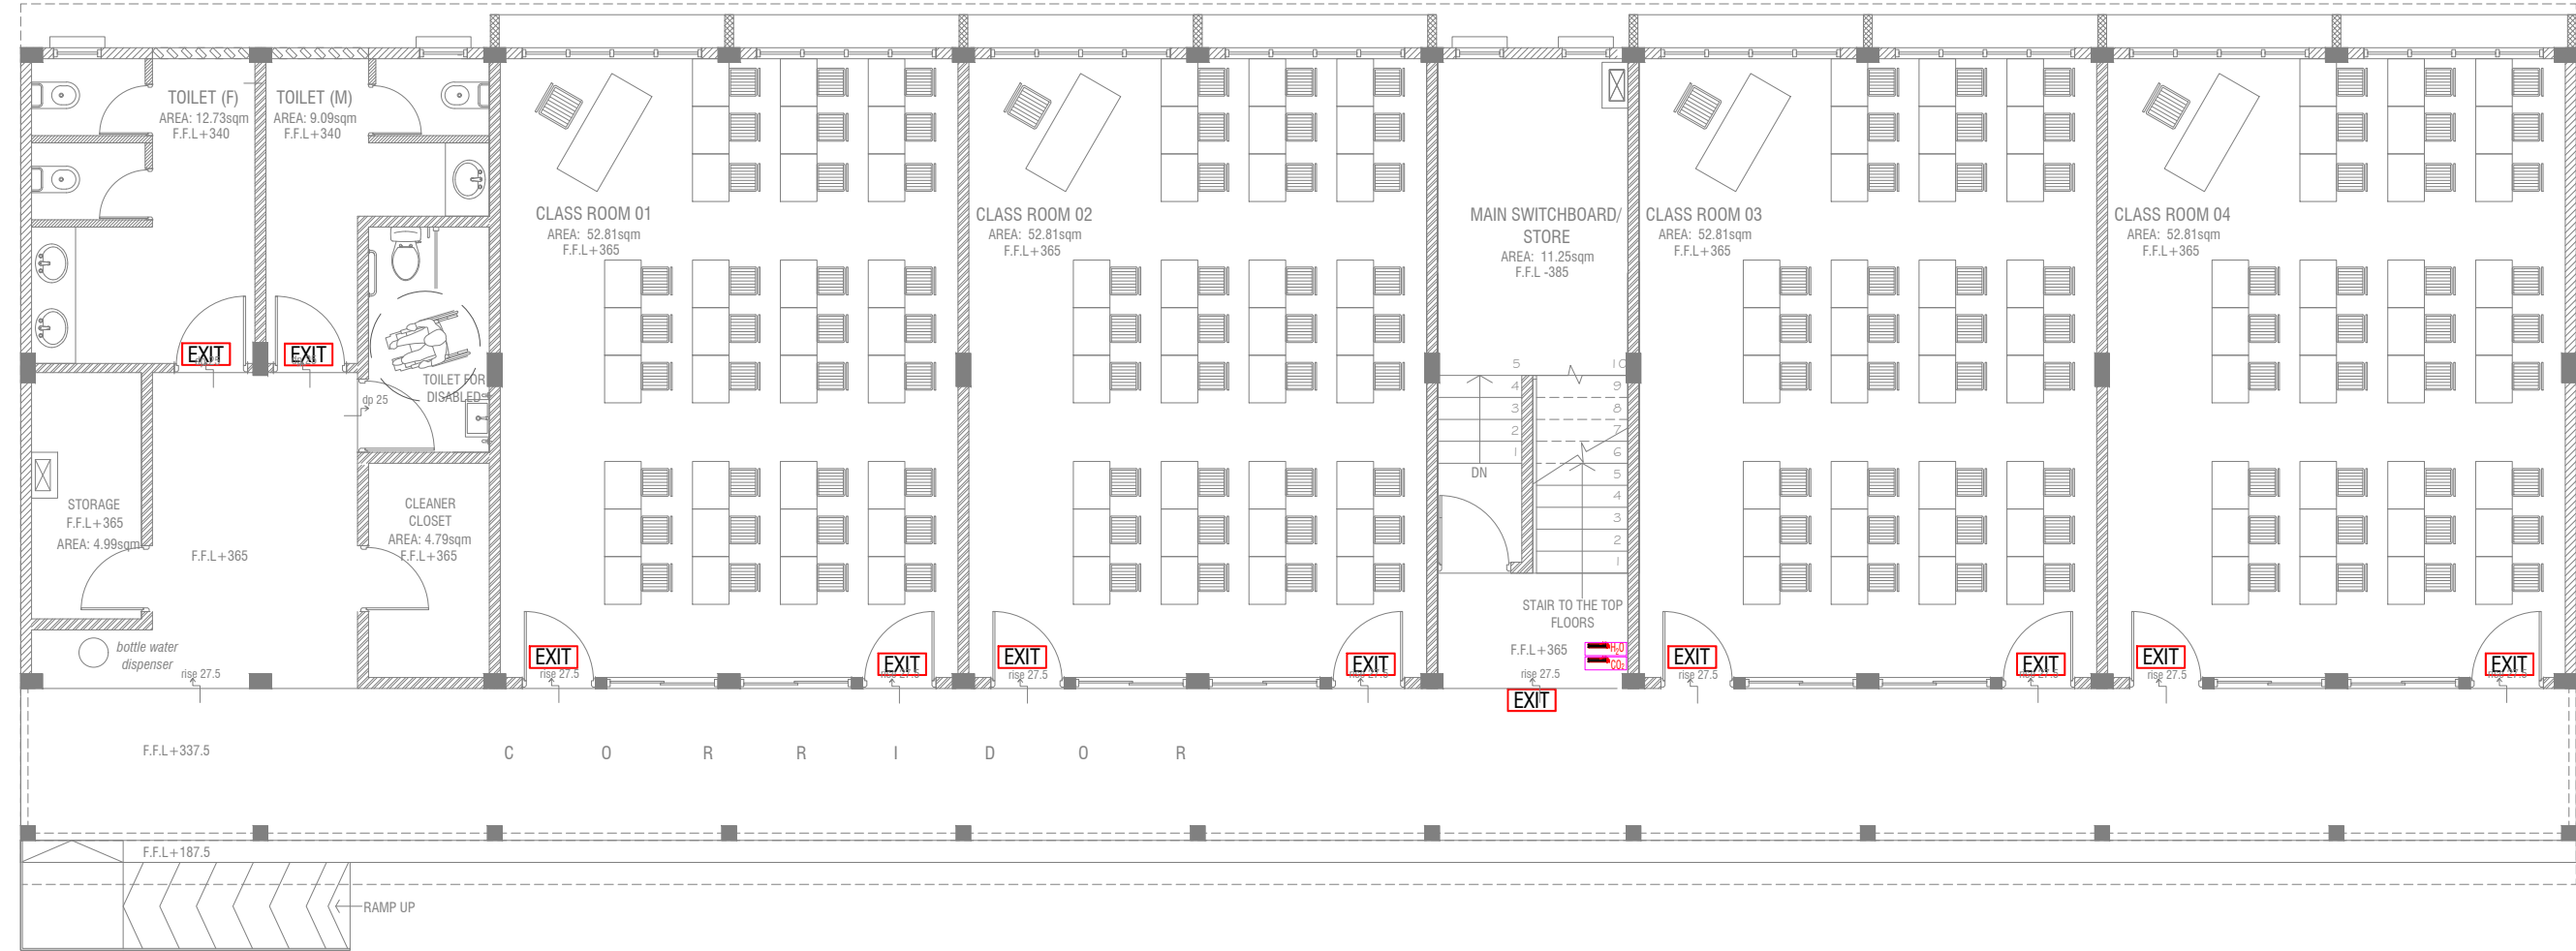

GROUND FLOOR FDP LAYOUT



LEGEND

- EXIT SIGN
- CO₂ EXTINGUISHER (LOAD: 2KG) IN POLYCARBONATE ENCLOSURE(TYP.)
- H₂O EXTINGUISHER (LOAD: 9L) IN POLYCARBONATE ENCLOSURE(TYP.)

ALL FIRE CABLES AND CONDUITS SHOULD BE FIRE RETARDANT LOW SMOKE (FRLS) TYPE.

ALL FIRE RATED DOOR SHOULD COME WITH PACKING (EXPANSION SEAL TRAP)

- 1.ALL PIPES SHOULD BE GALVANIZED,SCHEDULE 40.
2. ALL PIPE SHALL BE PAINTED IN RED AS PER REGULATION.
3. ALL SUPPORT/BACKET SHALL BE HOT DIPPED GALVANIZED TO 100MM
- 4.ALL FIRE EXTINGUISHER INSIDE CABINETS. (CABINET SHOULD BE PROVIDED)

-IF THE INSTALLATION OF CEILING IS CARRIED OUT LOWER THAN BEAM BOTTOM ,SMOKE DETECTORS SHOULD BE PLACED AS INDICATED ON THE DRAWING.
-ALTERNATIVELY IF THE INSTALLATION OF CEILING IS CARRIED OUT EQUAL TO BEAM BOTTOM OR IF THE CEILING IS NOT INSTALLED , SMOKE DETECTORS ARE TO BE PLACED IN BETWEEN EACH BEAM

Sn.Hithadhoo Noorani School - 12 Classroom (03 Storey)
Client: Ministry of Education

Rev no	Date
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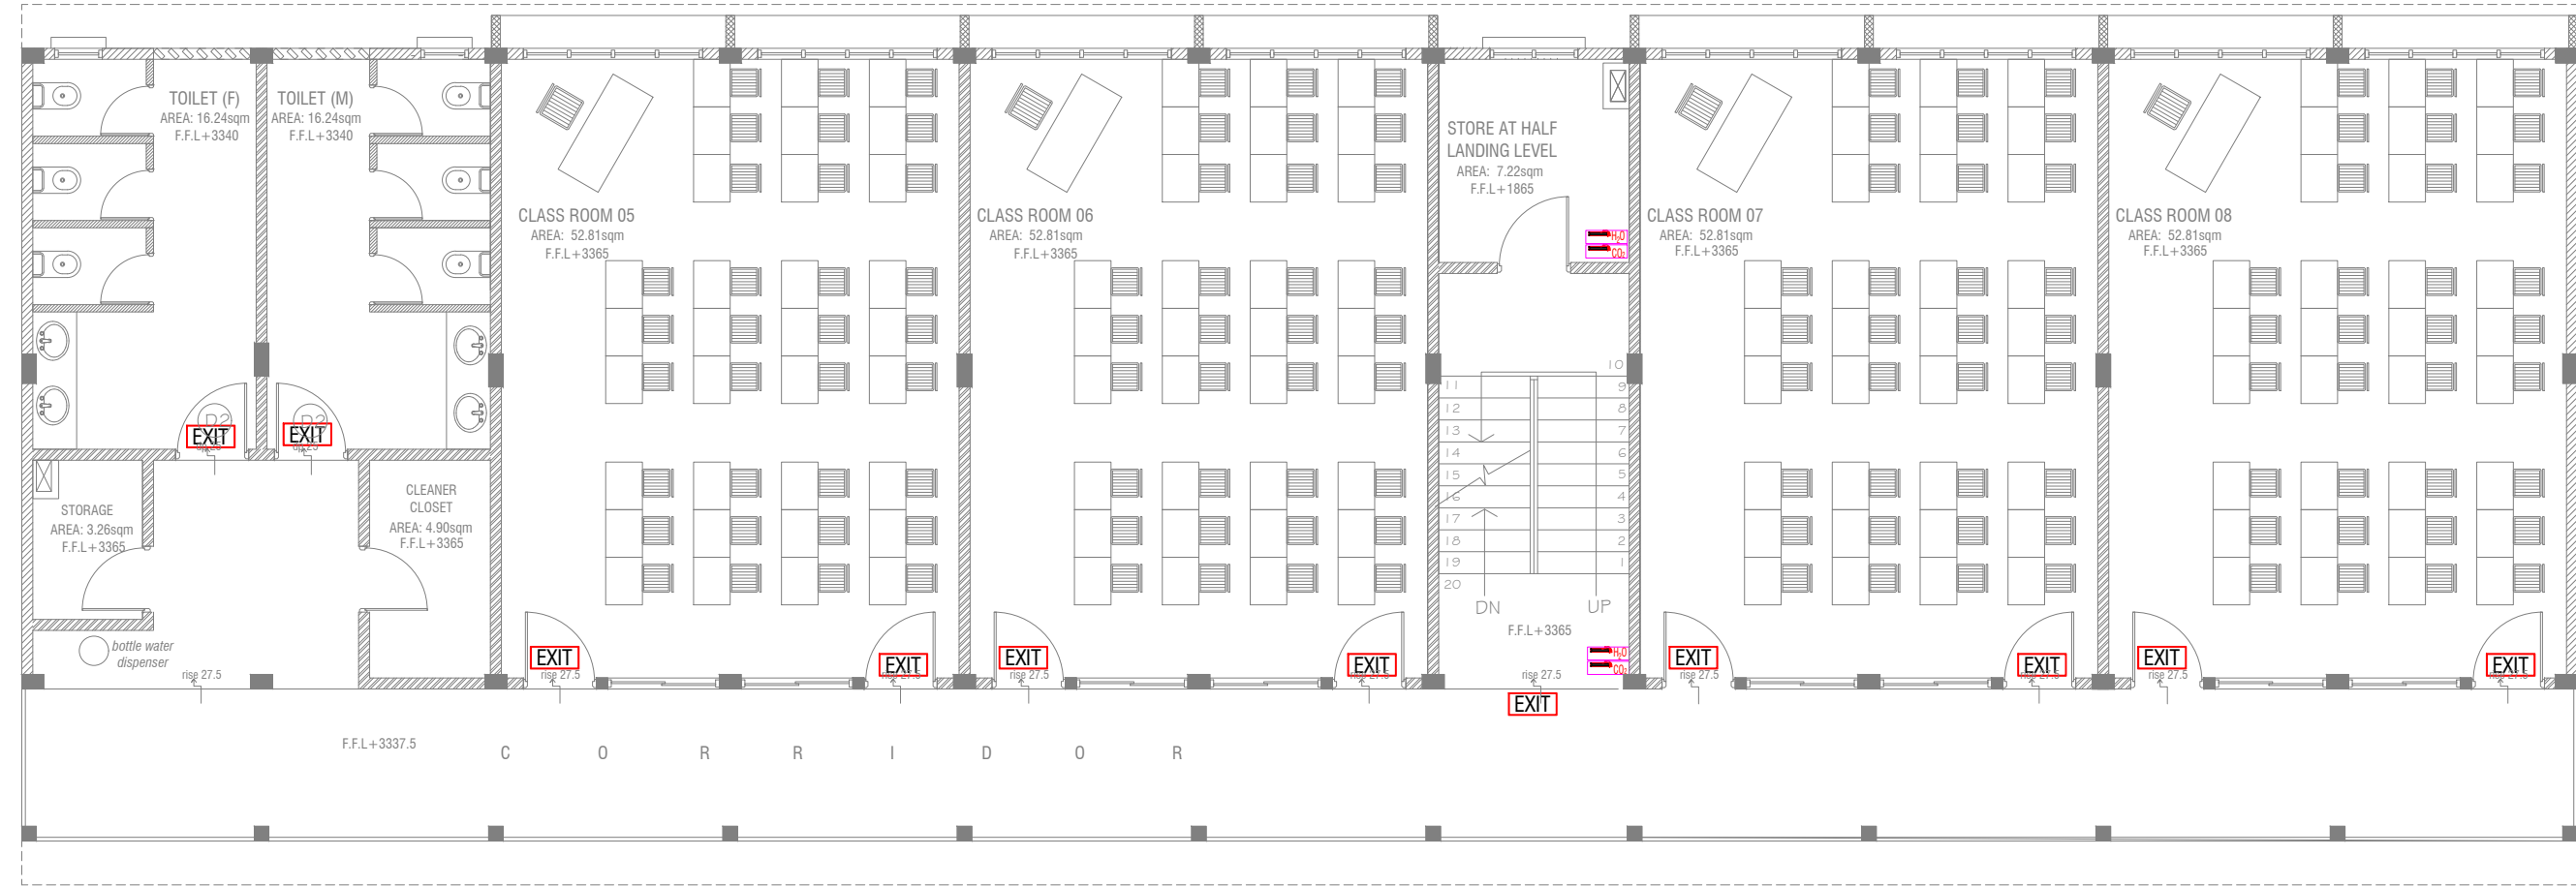
Project Number: RI/2020/006
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Architect : Mariyam Irasha Shareef
Engineer : Mohamed Muththalib Waleed
Drawn by : Mariyam Leevan Jaleel
Services : Aishath Ahmed
Interior : -



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Title: Ground Floor
FDP Layout

Page: FDP 01-02



FIRST - SECOND FLOOR FDP LAYOUT

SCALE 1:100



LEGEND



EXIT SIGN



CO₂ EXTINGUISHER (LOAD: 2KG) IN POLYCARBONATE ENCLOSURE(TYP.)



H₂O EXTINGUISHER (LOAD: 9L) IN POLYCARBONATE ENCLOSURE(TYP.)

ALL FIRE CABLES AND CONDUITS SHOULD BE FIRE RETARDANT LOW SMOKE (FRLS) TYPE.

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-ALTERNATIVELY IF THE INSTALLATION OF CEILING IS CARRIED OUT EQUAL TO BEAM BOTTOM OR IF THE CEILING IS NOT INSTALLED , SMOKE DETECTORS ARE TO BE PLACED IN BETWEEN EACH BEAM

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Project Number: RI/2020/006

Date: March 2021

Architect : Mariyam Irasha Shareef

Engineer : Mohamed Muththalib Waleed

Drawn by : Mariyam Leevan Jaleel

Services : Aishath Ahmed

Interior : -

Rev no

Date

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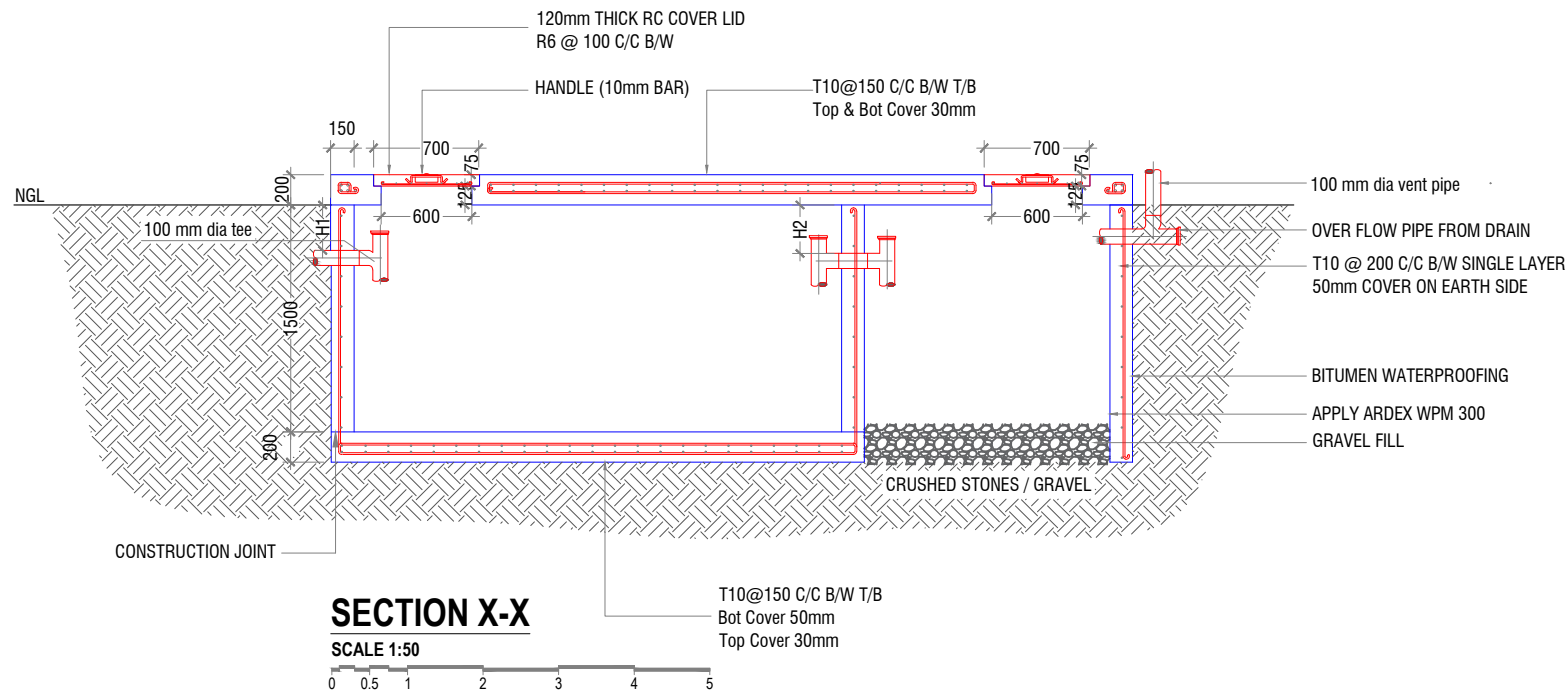
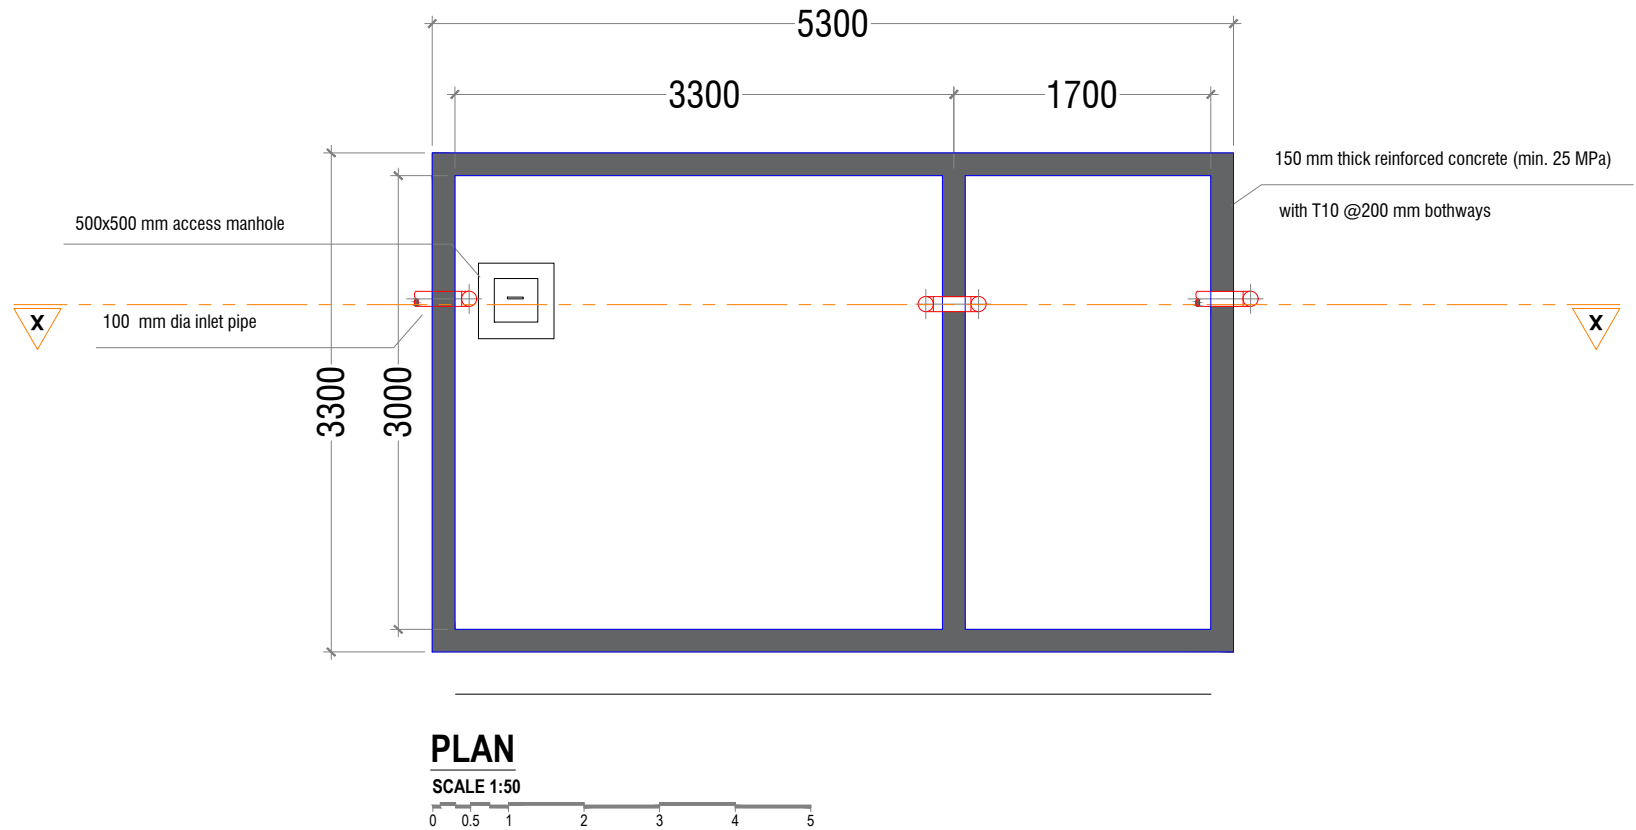
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Title: First - Second Floor FDP Layout

Page: FDP 02-02



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NOTE:

H1 < H2

- TOP AND BOTTOM OF SEPTIC TANK SHOULD BE OF 200mm THICK
- BITUMINOUS WATERPROOFING TO BE APPLIED BELOW GROUND SURFACE
- REINFORCEMENT TO HAVE A COVER OF 50mm FROM EARTH

SEPTIC TANK DETAIL

SCALE 1:50



Sn.Hithadhoo Noorani School - 12 Classroom (03 Storey)
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Project Number: RI/2020/006

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Interior: -



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Title: Septic Tank Detail

Page: Detail 01-01