WASTEWATER COLLECTION, TREATMENT, AND DISPOSAL SYSTEM IN HA.BAARAH, MALDIVES

ANNEX III - DETAILED DRAWINGS



t:+9603315049 f:+9603310776
e:info@riyan.com.mv
w:www.riyan.com.mv
3rd floor, H. Azum, Ameeneemagu, Male'

TABLE OF CONTENT

DRAWING No.	TITLE	REVISION No.	DATE	REMARKS
SEWERAGE NET	WORK AND ADMIN BUILDING			
A - 01 / 28	HA,BAARAH NETWORK LAYOUT			
A - 02 / 28	HOUSE CONNECTION DETAILS			
A - 03 / 28	MAINTENANCE SHAFT, CLEANOUT, HOUSE INSPECTION CHAMBER, TRENCH AND BEDDING DETAILS			
A - 04 / 28	THRUST BLOCK DETAIL			
A - 05 / 28	TYPICAL PUMPING STATION DETAIL - LONGITUDINAL SECTION			
A - 06 / 28	TYPICAL PUMPING STATION DETAIL - PLAN			
A - 07 / 28	PUMP STATION DETAIL			
A - 08 / 28	PUMP STATION VENT ELEVATION, FOOTING DETAIL PLAN			
A - 09 / 28	CONTROL PANEL BASE SECTION A-A			
A - 10 / 28	T-HEAD DIFFUSER PLAN & SECTION			 -
A - 11 / 28	SEA OUTFALL FIXING DETAILS			
A - 12 / 28	SEA OUTFALL DETAILS			
A - 13 / 28	ADMIN BUILDING SITE PLAN			
A - 14/ 28	ADMIN BUILDING GROUND FLOOR PLAN & ROOF PLAN			 -
A - 15 / 28	DOOR & WINDOW SCHEDULE 01			
A - 16 / 28	DOOR & WINDOW SCHEDULE 02			
A - 17 / 28	ADMIN BUILDING ELEVATION E1 & SECTION S1			
A - 18 / 28	ADMIN BUILDING FOUNDATION PLAN			
A - 19/ 28	ADMIN BUILDING ROOF BEAM AND FRAMING PLAN			
A - 20 / 28	ADMIN BUILDING BOUNDARY WALL & GATE DETAIL			 -
A - 21 / 28	ADMIN BUILDING STRUCTURAL DETAILS AND FOUNDATION DETAILS			
A - 22 / 28	ADMIN BUILDING SERVICE GROUND FLOOR CEILING LAYOUT			
A - 23 / 28	ADMIN BUILDING SERVICES GROUND FLOOR LIGHTING LAYOUT			
A - 24 / 28	ADMIN BUILDING SERVICES GROUND FLOOR FIRE LAYOUT			
A - 25 / 28	ADMIN BUILDING SERVICES GROUND FLOOR POWER LAYOUT			
A - 26 / 28	ADMIN BUILDING SERVICES GROUND FLOOR ACV LAYOUT			
A - 27 / 28	ADMIN BULIDING SERVICES GROUND FLOOR PLUMBING LAYOUT			 -
A - 28 / 28	ADMIN BUILDING SERVICES GROUND & ROOF DRAINAGE LAYOUT			

DRAWING No.	TITLE	REVISION No.	DATE	REMARKS
SEWERAGE TREATMENT PLANT (PROVISIONAL)				
STP - 1 / 4	STP SITE PLAN			
STP - 2 / 4	STP FLOW DIAGRAM			
STP - 3 / 4	STP SECTION			
STP - 4 / 4	STP GROUND FLOOR PLAN			

DRAWING No.	TITLE	REVISION No.	DATE	REMARKS
ELECTRICALS				
E - 01	POWER LAYOUT SINGLE LINE DIAGRAM FOR PS1			
E - 02	POWER LAYOUT SINGLE LINE DIAGRAM FOR PS2			
E - 03	POWER LAYOUT SINGLE LINE DIAGRAM FOR PS3			
E - 04	TYPICAL DETAIL FOR PUMP STATION CONTROL PANEL			
E - 05	OVERALL PROCESS INSTRUMENTATION DIAGRAM			
E - 06	PUMP STATION OPERATION CONTROL			



t:+9603315049 f:+9603310776 e:info@riyan.com.mv w:www.riyan.com.mv

TABLE OF CONTENT

DRAWING No.	TITLE	REVISION No.	DATE	REMARKS
SEWERAGE NET	WORK PROFILES		,	
PS1 - 01 / 24	PS1- PROFILE 1			
PS1 - 02 / 24	PS1- PROFILE 1 to 2			
PS1 - 03 / 24	PS1- PROFILE 3 to 5			
PS1 - 04 / 24	PS1- PROFILE 6 to 8			
PS1 - 05 / 24	PS1- PROFILE 9 to 10			
PS1 - 06 / 24	PS1- PROFILE 11 to 13			
PS1 - 07 / 24	PS1- PROFILE 14			
PS1 - 08 / 24	PS1- PROFILE 15 to 16			
PS1 - 09 / 24	PS1- PROFILE 17 to 18			
PS1 - 10 / 24	PS1- PROFILE 19 to 20 PS1- PROFILE 21			
PS1 - 11 / 24 PS1 - 12 / 24	PS1- PROFILE 21			
PS1 - 12 / 24 PS1 - 13 / 24	PS1- PROFILE 25			
PS1 - 14 / 24	PS1- PROFILE 26 to 27			
PS1 - 15 / 24	PS1- PROFILE 28 to 29			
PS1 - 16 / 24	PS1- PROFILE 30			
PS1 - 17 / 24	PS1- PROFILE 31 to 33			_
PS1 - 18 / 24	PS1- PROFILE 34 to 35			
PS1 - 19 / 24	PS1- PROFILE 36 to 37			
PS1 - 20 / 24	PS1- PROFILE 38 to 39			
PS1 - 21 / 24	PS1- PROFILE 40			
PS1 - 22 / 24	PS1- PROFILE 40 to 41			
PS1 - 23 / 24	PS1- PROFILE 42 to 44			
PS1 - 24 / 24	PS1- PROFILE 45 to 46			
PS2 - 01 / 20	PS2- PROFILE 1			
PS2 - 02 / 20	PS2- PROFILE 1			
PS2 - 03 / 20	PS2- PROFILE 2			
PS2 - 04 / 20 PS2 - 05 / 20	PS2- PROFILE 3 to 4 PS2- PROFILE 5 to 6			
PS2 - 06 / 20	PS2- PROFILE 5 to 6 PS2- PROFILE 7 to 9			
PS2 - 07 / 20	PS2- PROFILE 10			
PS2 - 08 / 20	PS2- PROFILE 10 to 11			
PS2 - 09 / 20	PS2- PROFILE 12 to 13			
PS2 - 10 / 20	PS2- PROFILE 14 to 15			
PS2 - 11 / 20	PS2- PROFILE 16 to 17			
PS2 - 12 / 20	PS2- PROFILE 18 to 20			
PS2 - 13 / 20	PS2- PROFILE 21			
PS2 - 14 / 20	PS2- PROFILE 22 to 23			
PS2 - 15 / 20	PS2- PROFILE 24 to 25			
PS2 - 16 / 20	PS2- PROFILE 26 to 28			
PS2 - 17 / 20	PS2- PROFILE 29 to 30			 -
PS2 - 18 / 20	PS2- PROFILE 31 to 33			_
PS2 - 19 / 20	PS2- PROFILE 34 to 35			
PS2 - 20 / 20	PS2- PROFILE 36 to 38			
D00 04 (00	DOG PROFILE 4			
PS3 - 01 / 22	PS3- PROFILE 1			
PS3 - 02 / 22	PS3- PROFILE 2 to 3			
PS3 - 03 / 22 PS3 - 04 / 22	PS3- PROFILE 4 to 5 PS3- PROFILE 6 to 6A			
PS3 - 04 / 22 PS3 - 05 / 22	PS3- PROFILE 6 to 6A PS3- PROFILE 7 to 8			
PS3 - 05 / 22	PS3- PROFILE 7 to 8			
PS3 - 07 / 22	PS3- PROFILE 10 to 11			
PS3 - 08 / 22	PS3- PROFILE 12 to 13			
PS3 - 09 / 22	PS3- PROFILE 14 to 15			
PS3 - 10 / 22	PS3- PROFILE 16 to 17			
PS3 - 11 / 22	PS3- PROFILE 18			
PS3 - 12 / 22	PS3- PROFILE 18 to 19			
PS3 - 13 / 22	PS3- PROFILE 20 to 21			
PS3 - 14 / 22	PS3- PROFILE 20 to 23			
PS3 - 15 / 22	PS3- PROFILE 24 to 26			
PS3 - 16 / 22	PS3- PROFILE 27 to 29			
PS3 - 17 / 22	PS3- PROFILE 30 to 31			
PS3 - 18 / 22	PS3- PROFILE 32 to 33			
PS3 - 19 / 22	PS3- PROFILE 34 to 35			<u></u>
PS3 - 20 / 22	PS3- PROFILE 36 to 37			
PS3 - 21 / 22	PS3- PROFILE 38 to 40			
PS3 - 22 / 22	PS3- PROFILE 41 to 42			

RIYAN PRIVATE LIMITED

t:+9603315049 f:+9603310776 e:info@riyan.com.mv w:www.riyan.com.mv



CONSULTANCY SERVICES FOR SURVEY, DESIGN & SUPERVISON OF SEWERAGE FACILITIES IN K. THULUSDHOO, MALDIVES

RIYAN PRIVATE LIMITED

Title: Ha.Baarah Network Layout

Page: A-01/28





Page: A-01a/28

Title: Ha.Baarah Network layout

TYPICAL HOUSE CONNECTION DETAIL N.T.S

CONSULTANCY SERVICES FOR SURVEY & DESIGN
OF SEWERAGE FACILITIES IN HA BAARAH, MALDIVES
CLIENT MINISTRY OF ENVIRONMENT AND ENERGY
DATE MARCH 2017
ENGINEER: Mohamed Saif Saeed


RIYAN PRIVATE LIMITED

t:+9603315049 f:+9603310776 e:info@riyan.com.mv w:www.riyan.com.mv 3rd floor, H. Azum, Ameeneemagu, Male

Title: House connection detail


Page: A -02/28

Scale 1:20

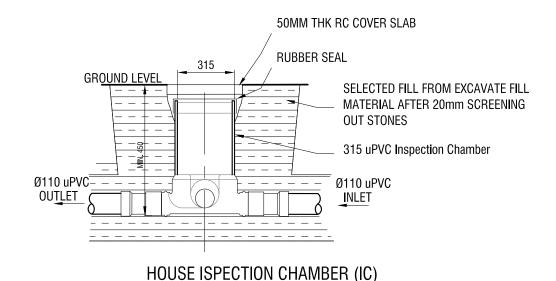

Scale 1:20



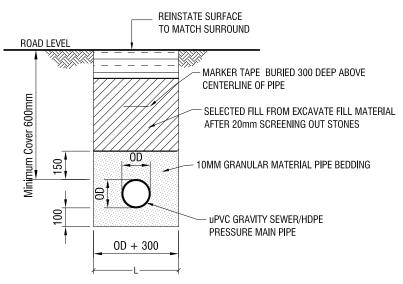


TRENCH & BEDDING DETAILS Scale 1:20

CONSULTANCY SERVICES FOR SURVEY & DESIGN
OF SEWERAGE FACILITIES IN HA.BAARAH, MALDIVES
CLIENT: MINISTRY OF ENVIRONMENT AND ENERGY
PROJECT NUMBER -DATE: MARCH 2017

RIYAN PRIVATE LIMITED

Page: A - /28

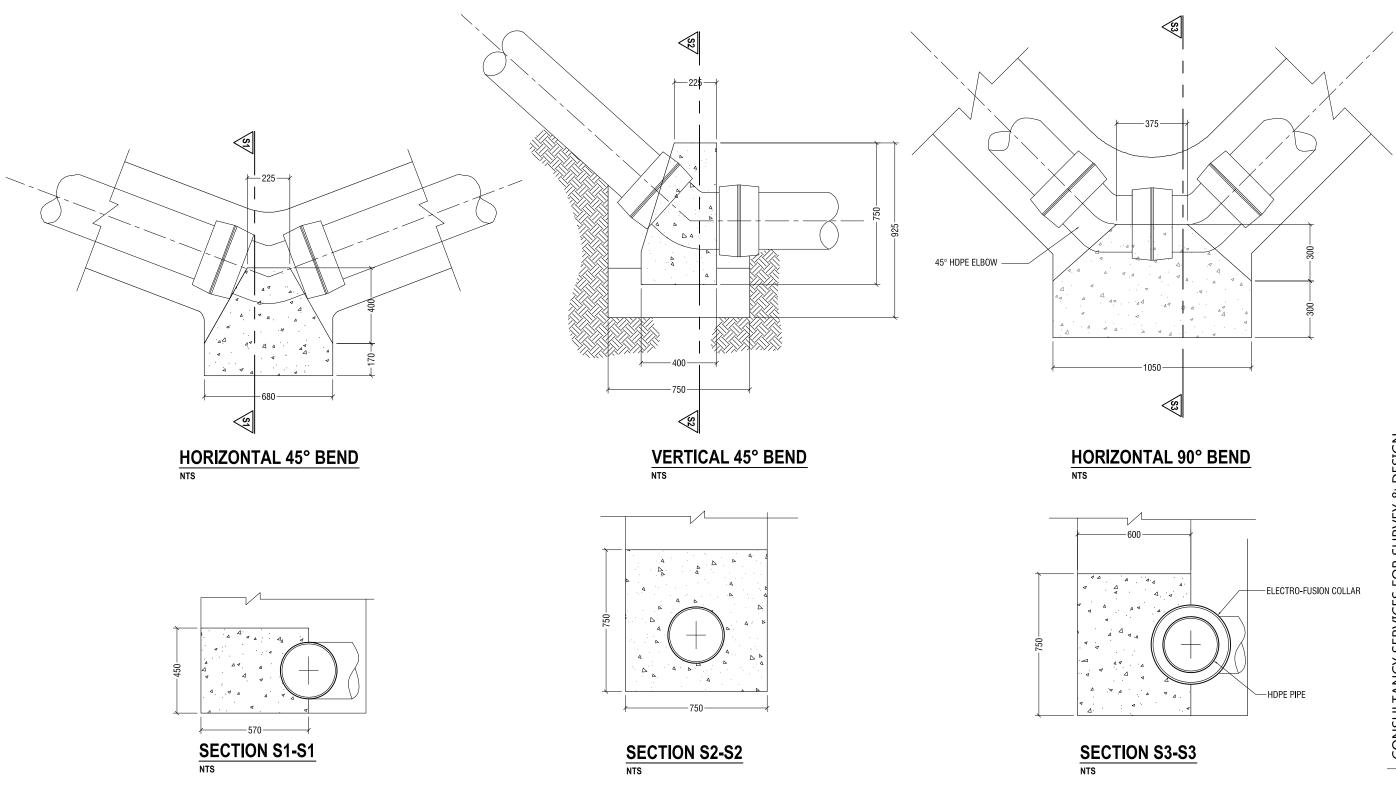

THRUST BLOCK DETAIL - FORCE MAINS ONLY


SCALE 1:20

CONSULTANCY SERVICES FOR SURVEY & DESIGN
OF SEWERAGE FACILITIES IN HA.BAARAH, MALDIVES
CLIENT: MINISTRY OF ENVIRONMENT AND ENERGY

DATE: MARCH 2017
ENGINER: - Mohammed Callon
ENGINER
ENGINER: - MOHAMMED CALLON
ENGINER
ENGI

RIYAN PRIVATE LIMITED

Page: A -04/28

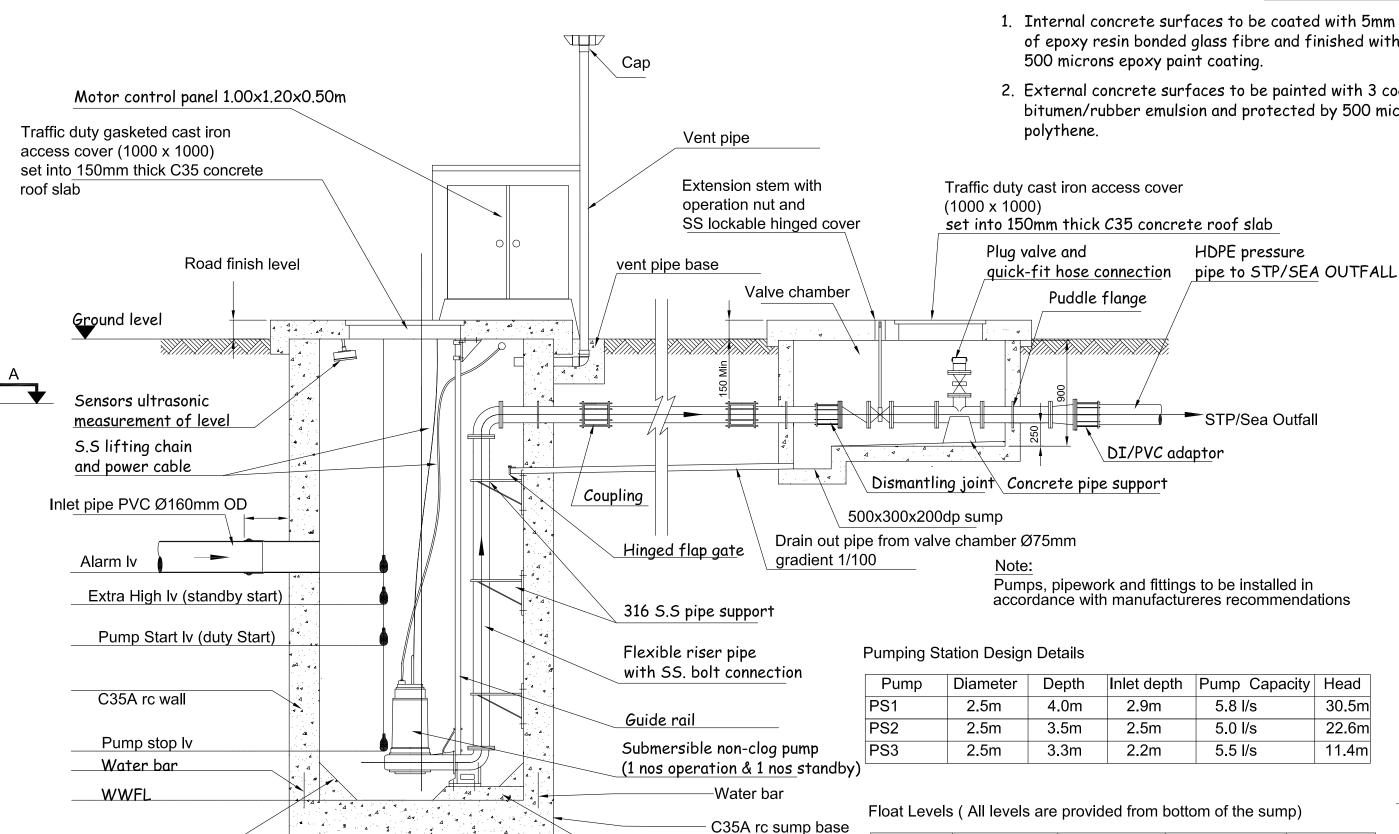

Pump stool

TYPICAL PUMPING STATION DETAIL - LONGITUDINAL SECTION

Scale: N.T.S

Benching slope 1/1

Pump	Diameter	Depth	Inlet depth	Pump Capacity	Head
PS1	2.5m	4.0m	2.9m	5.8 l/s	30.5m
PS2	2.5m	3.5m	2.5m	5.0 l/s	22.6m
PS3	2.5m	3.3m	2.2m	5.5 l/s	11.4m

Float Levels (All levels are provided from bottom of the sump)


PS	Pump Stop	Duty Start	Standby Start	Alarm
PS1	0.45m	0.65m	0.80m	0.95m
PS2	0.45m	0.65m	0.80m	0.95m
PS3	0.45m	0.65m	0.80m	0.95m

Note: Concrete surface protection to pump well /valve chamber

- 1. Internal concrete surfaces to be coated with 5mm thickness of epoxy resin bonded glass fibre and finished with gel coat or
- 2. External concrete surfaces to be painted with 3 coats of bitumen/rubber emulsion and protected by 500 micron

Y SERVICES FOR SURVEY & DESIGN EACILITIES IN HA.BAARAH, MALDIVES OF ENVIRONMENT AND ENERGY

RIYAN PRIVATE LIMITED

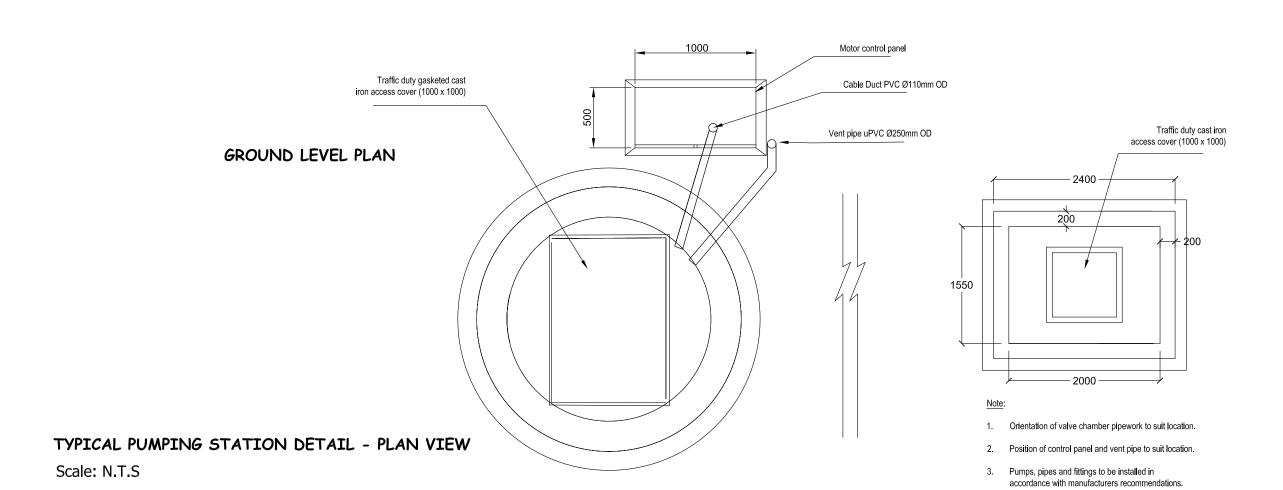


chamber in an emergency should be provided.

CONSULTANCY SERVICES FOR SURVEY & DESIGN
OF SEWERAGE FACILITIES IN HA.BAARAH, MALDIVES
CLIENT: MINISTRY OF ENVIRONMENT AND ENERGY
DATE MARCH 2017
ENGINEER: - MA


RIYAN PRIVATE LIMITED

Title: TYPICAL PUMPING STATION DETAIL - PLAN Page: A -06/28

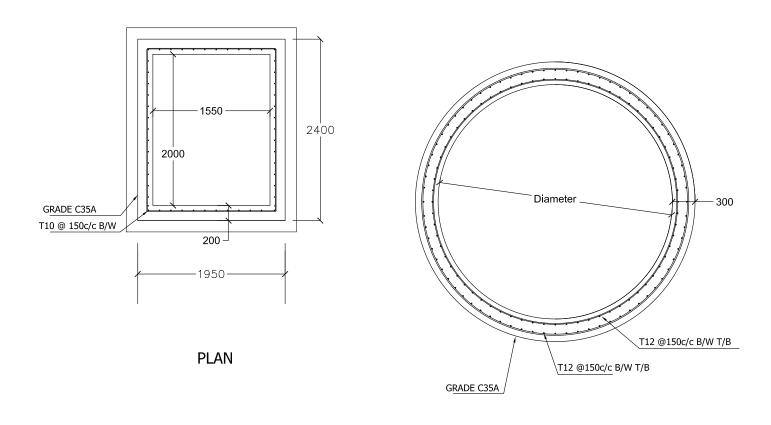

Note:

- 1. All structural concrete shall be of grade C35A.
- 2. All castings shall be done using Sulpahte Resistant Portland Cement to BS 4027:1996.
- 3. All structural reinforcement shall be epoxy coating of non-pre-stressed reinforcement to ASTM-A775/A775M.

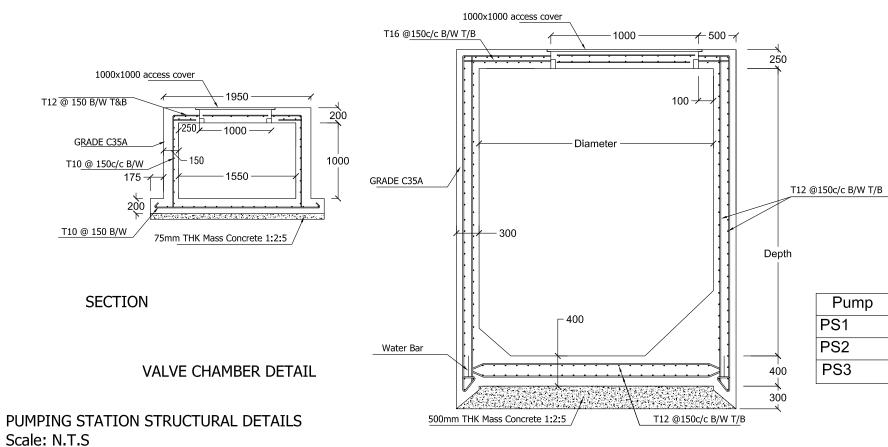


Diameter Depth Inlet depth Pump PS1 2.92m, 2.61m, 2.5m 4.0m PS2 2.49m,2.47m, 2.5m 3.5m 1.68m, 2.19m, 2.5m PS3 3.3m

PUMP STATION DETAIL

CONSULTANCY SERVICES FOR SURVEY & DESIGN OF SEWERAGE FACILITIES IN HA.BAARAH, MALDIVES CLIENT: MINISTRY OF ENVIRONMENT AND ENERGY

>


Title: PUMP STATION DETAIL
Page: A -07/28

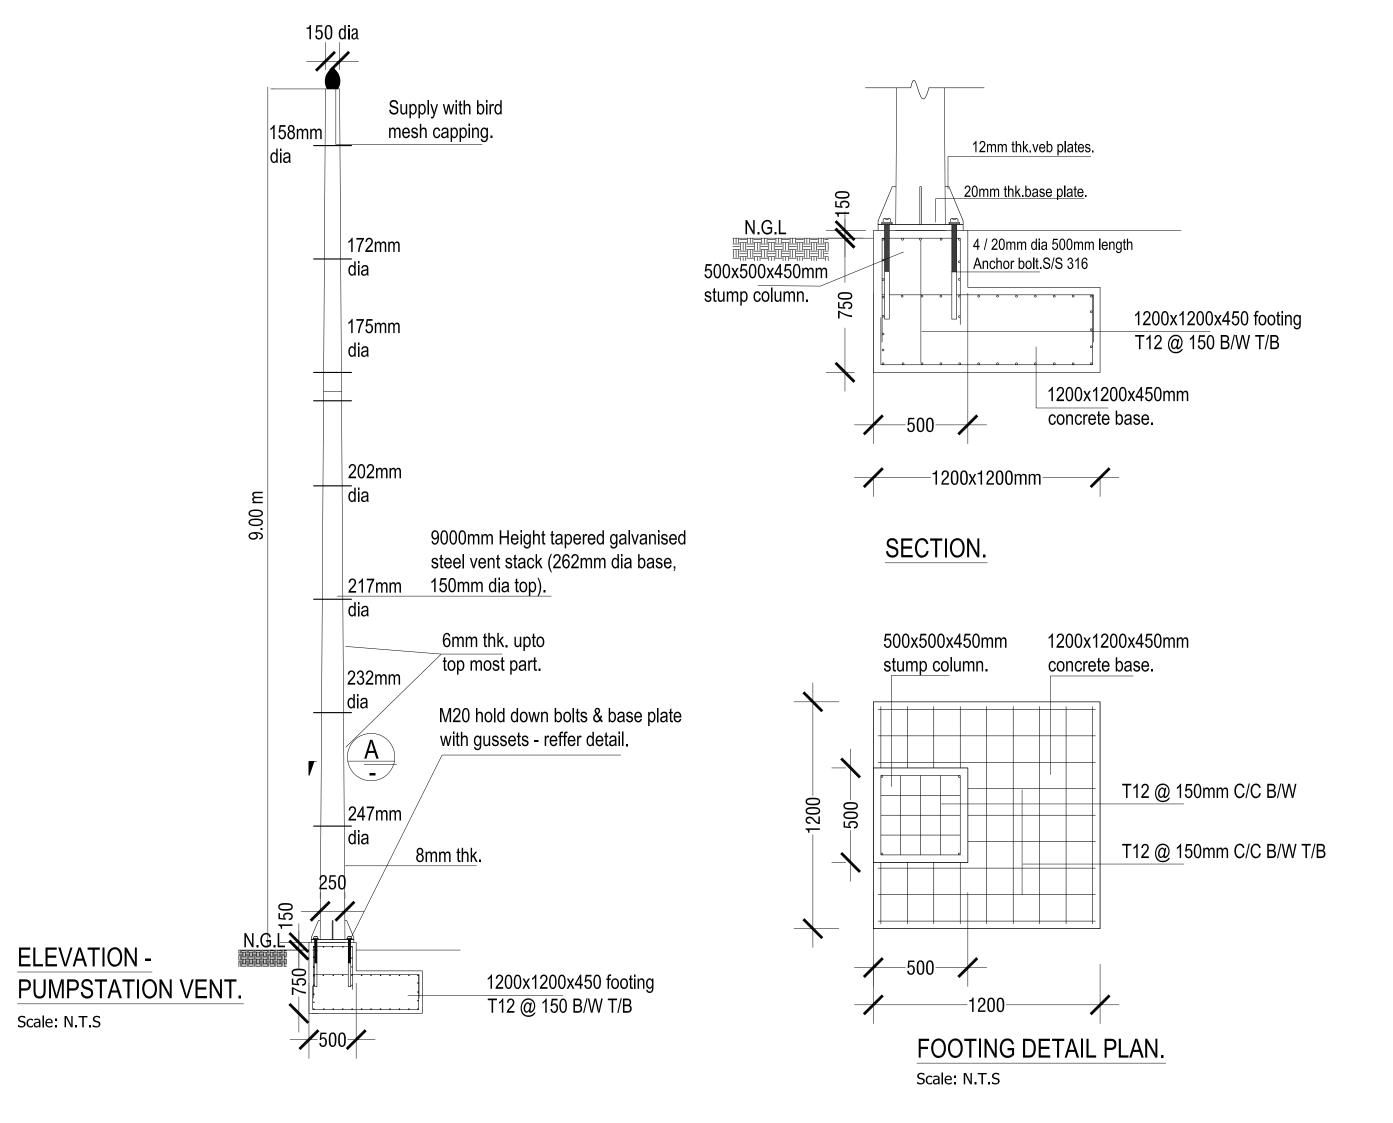

CONSULTANCY SERVICES FOR SURVEY & DESIGN
OF SEWERAGE FACILITIES IN HA.BAARAH, MALDIVES
CLIENT: MINISTRY OF ENVIRONMENT AND ENERGY
PROJECT MARGET STATES
OUT TO SERVICE STATES
OU

RIYAN PRIVATE LIMITED

Title: Pump Station Vent Elevation Page: A -08/28

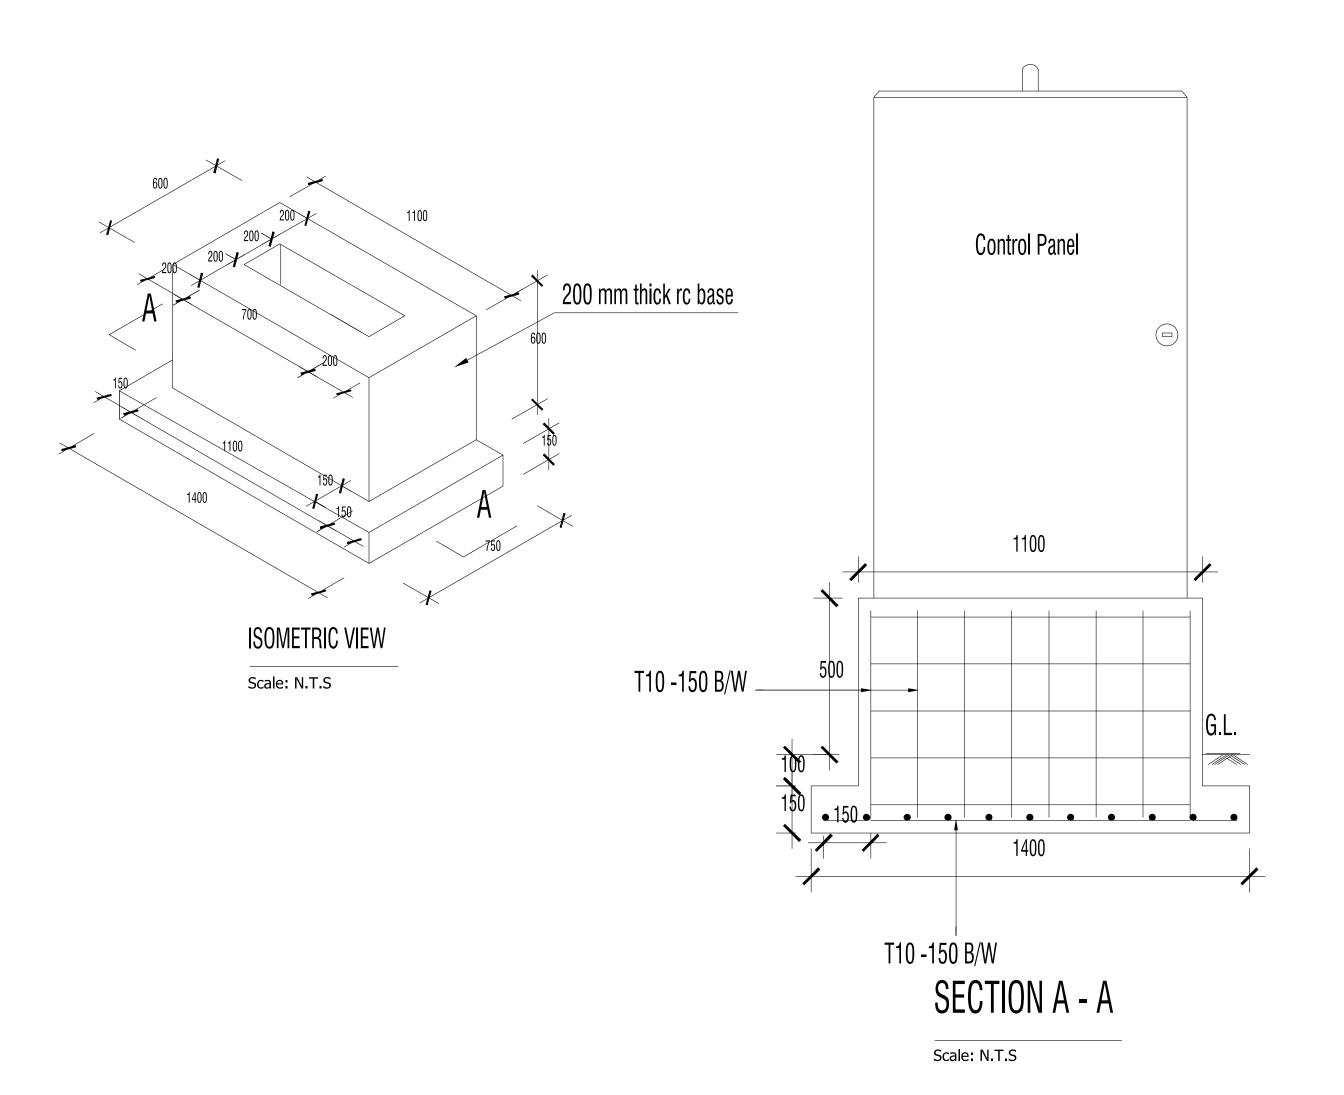


CONSOLIANCE SERVICES FOR SORVET & DESIGN
OF SEWERAGE FACILITIES IN HA.BAARAH, MALDIV
CLIENT: MINISTRY OF ENVIRONMENT AND ENERGY
PROJECT WARGH 2017
ENGINER: Mohamed Saff Saed
CHECKED BY: Insan Waheed
DRAWN BY: Mariyam Irasha Shareef

RIYAN PRIVATE LIMITED

t:+9603315049 f:+9603310776
e:info@riyan.com.mv

Title: Control Panel Base Section A-A Page: A = 09/28

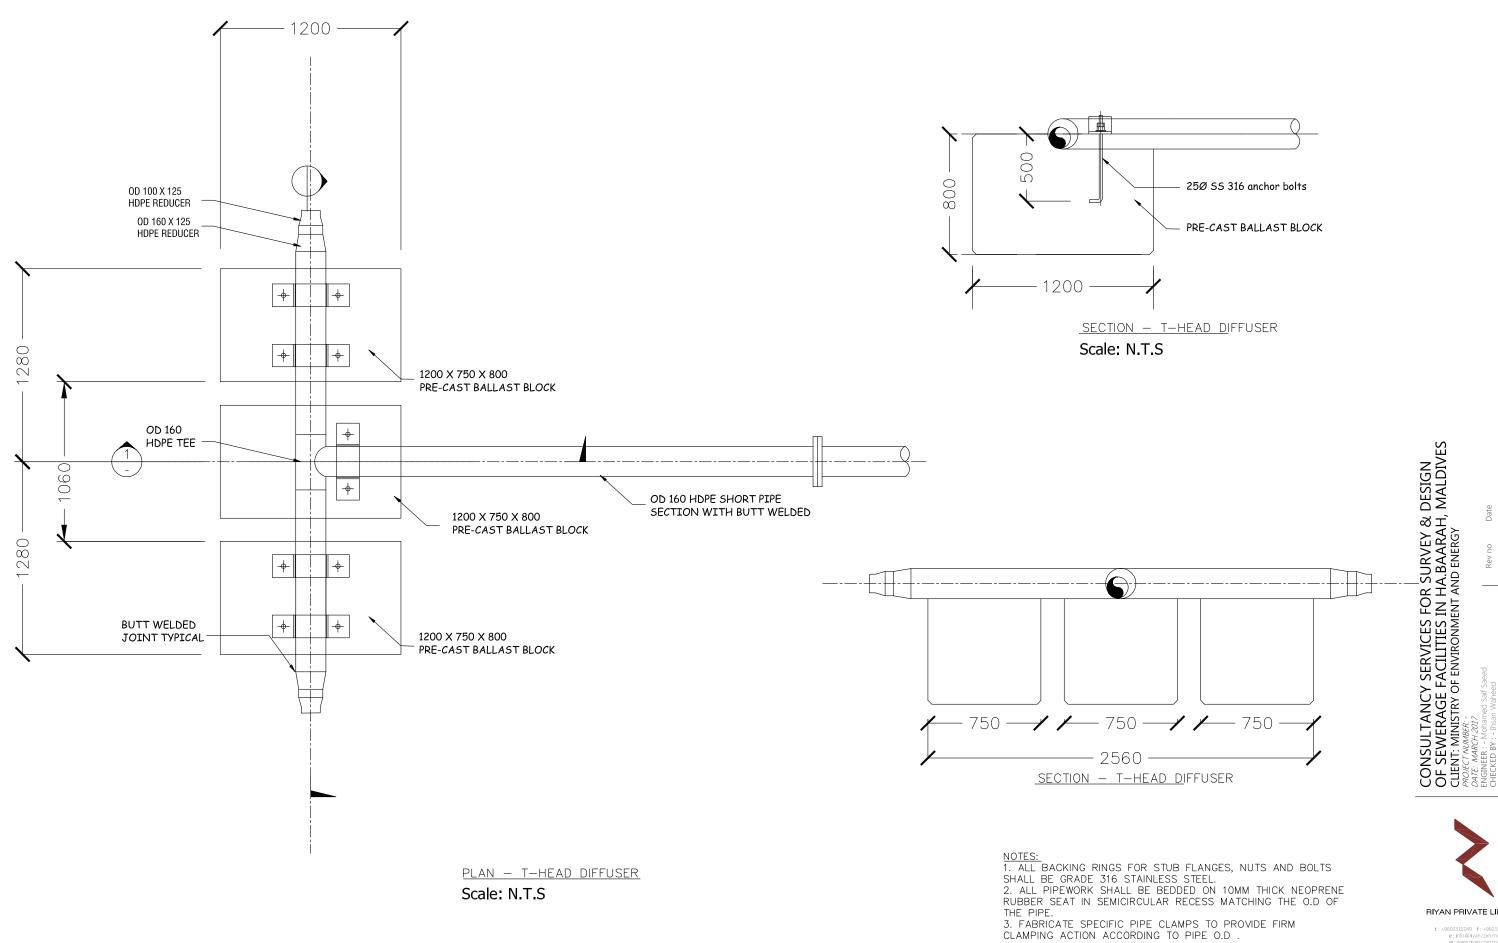



RIYAN PRIVATE LIMITED

Title: T-Head Diffuser Plan & Section Page: A -10/28

PLAN PRE-CAST BALLAST BLOCK

Scale: N.T.S

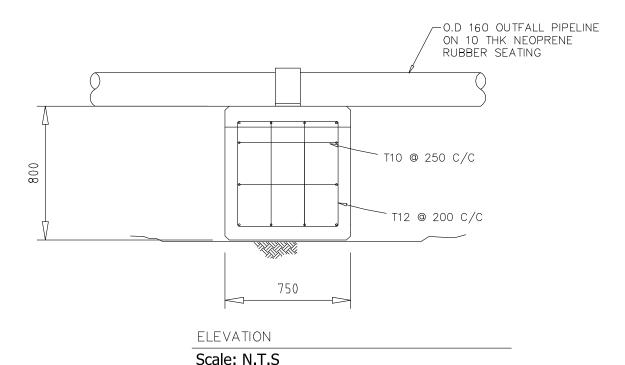


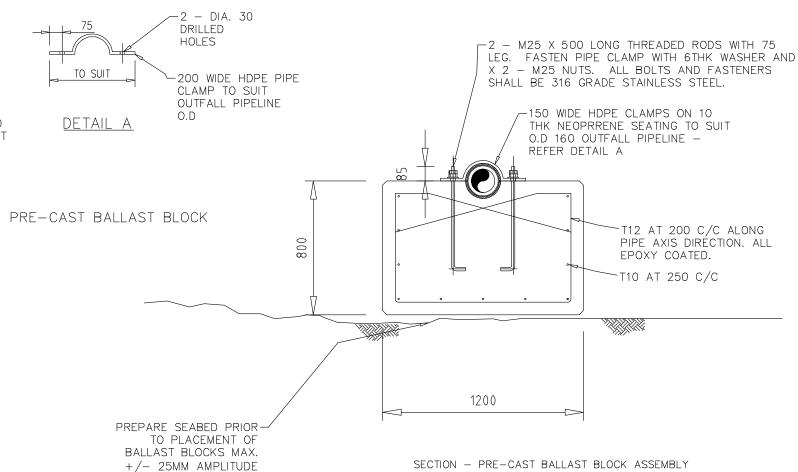


IOTES:

- 1. MIN 75MM COVER TO ALL REINFORCEMENT BARS.
- 2. ALL REINFORCEMENT SHALL BE EPOXY COATED PRIOR TO PLACEMENT OF CONCRETE.
- 3. PRE-CAST BALLAST BLOCKS SHALL BE FABRICATED WITH N40 / 20 CONCRETE.


Scale: N.T.S

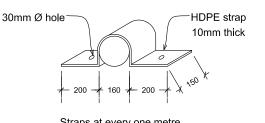

Straps at every one metre
DETAIL OF FIXING PIPE ON REEF FACE

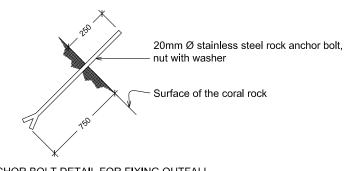

ANCHOR BOLT DETAIL FOR FIXING OUTFALL PIPE ON STEEP REEF SLOPES

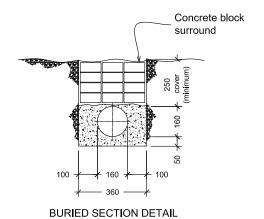

Note: To be provided where cover is not achieved and from Vegetation line to beach toe (low tide line)

SEA OUTFALL FIXING DETAIL

Scale: N.T.S




RIYAN PRIVATE LIMITED

e: Info@injan.com.mv
w: www.riyan.com.mv
floor, H. Azum, Ameeneemagu, Male*

Title: Sea Outfall Fixing Details

Page: A -11/28

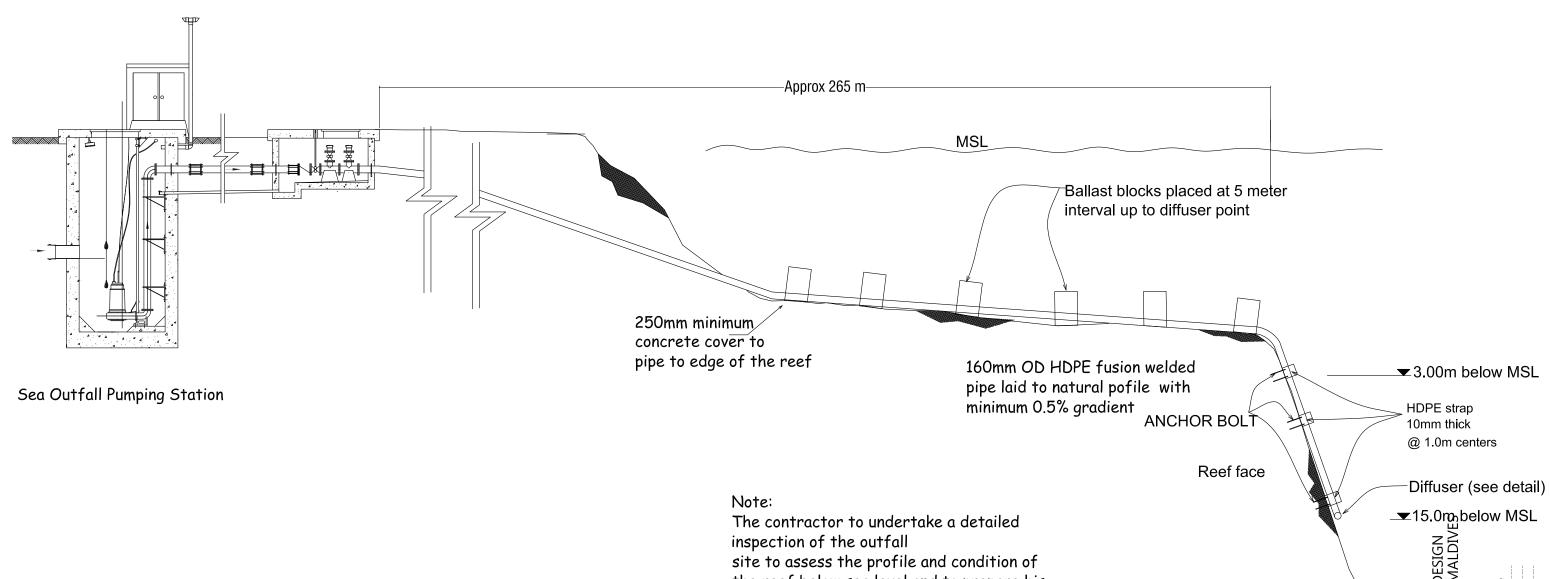


SEA OUTFALL DETAIL

Scale: N.T.S

ANCY SERVICES FOR SURVEY & Date of Manipular States of Manipular S



Page: A -12/28

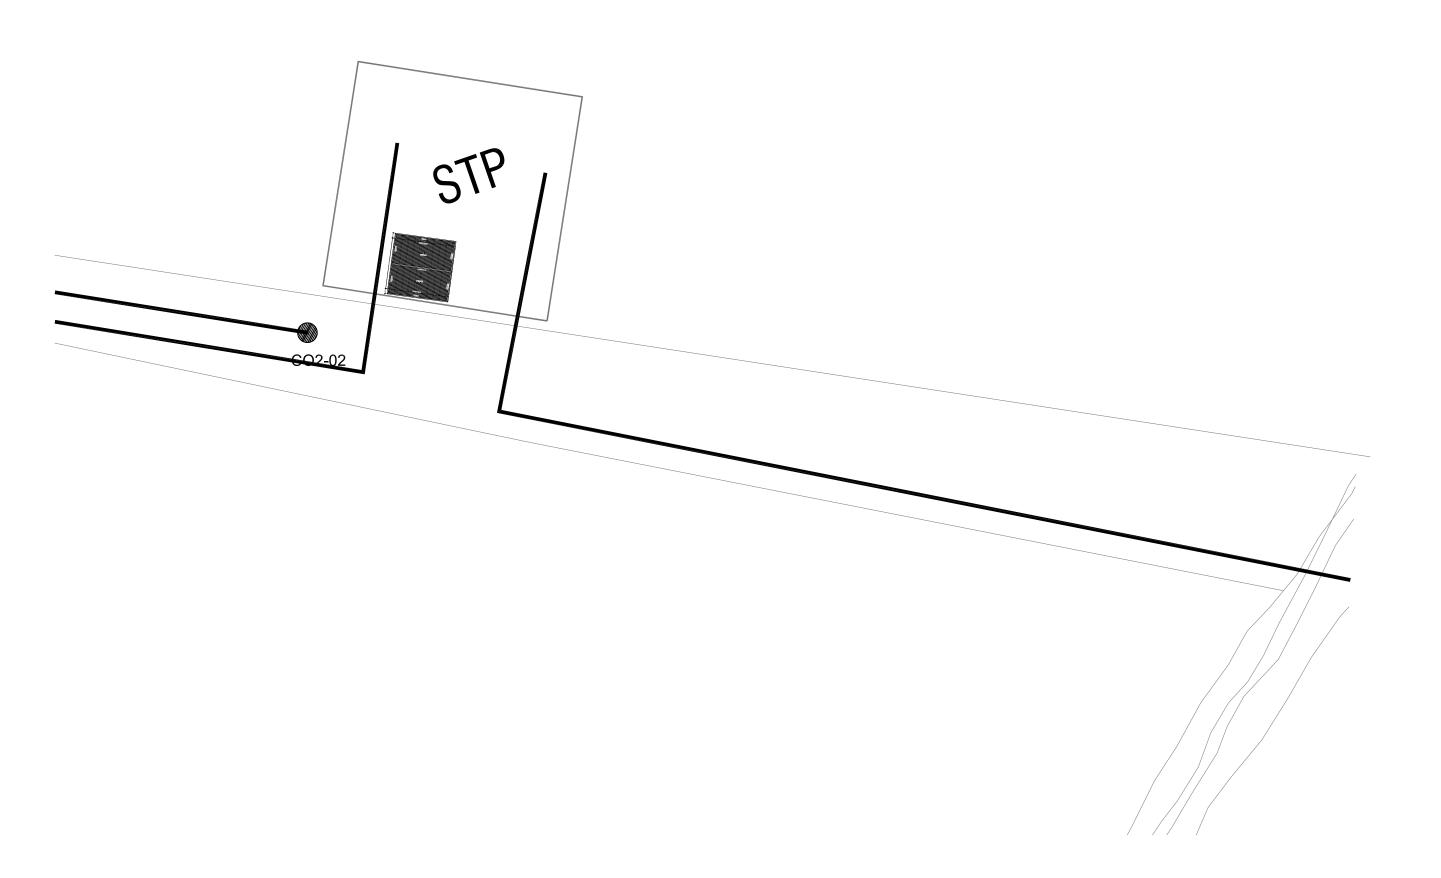

CONSULTANCY SERVICES FOR SURVEY & DESIGN
OF SEWERAGE FACILITIES IN HA.BAARAH, MALDIVES
CLIENT: MINISTRY OF ENVIRONMENT AND ENERGY
PROJECT NUMBER:DATE MARCH 2017
ENGINEER:- Mohamed Salf Saeed
CHECKED BY:- Insan Waheed
DRAWN BY:- Manyam Irasha Shareef

RIYAN PRIVATE LIMITED


t:+9603315049 f:+960331077/ e:info@riyan.com.mv w:vww.riyan.com.mv 3rd floor, H. Azum, Ameeneemagu, N

Title: Admin Building Site Plan
Page: A -13/28


SITE PLAN

SCALE 1:500

0 2.5 5 10 15 20 25

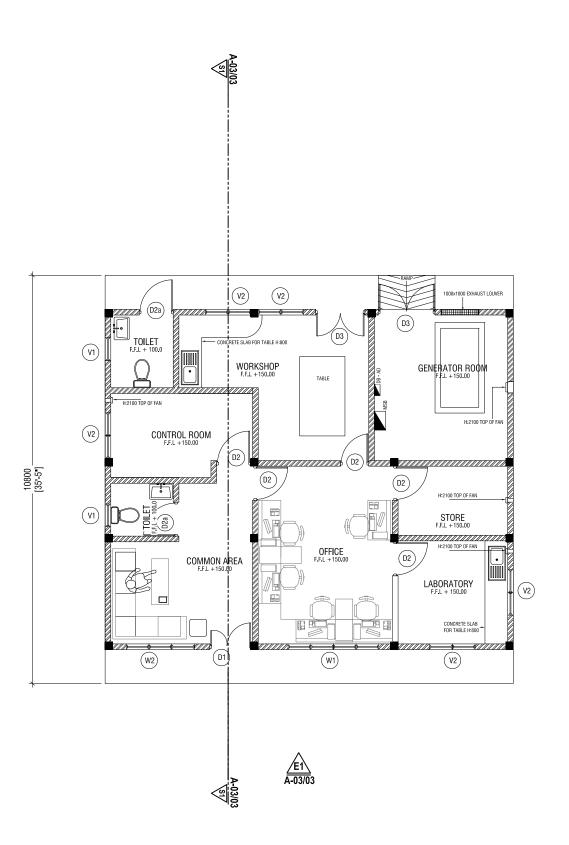



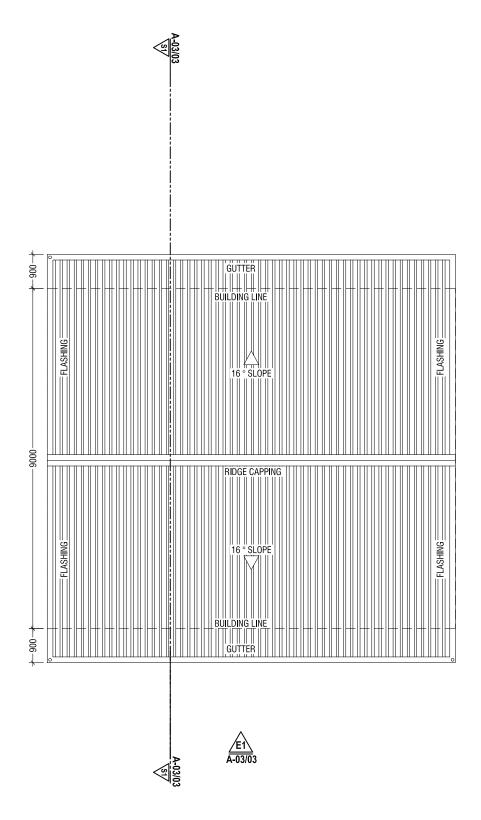







RIYAN PRIVATE LIMITED

Page: A -14/28


GROUND FLOOR PLAN & ROOF PLAN

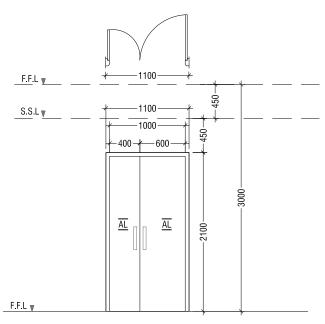


D1)	SWING-TYPE DOOR
REMARKS	AL FRAMED DOOR WITH AL PANELS
LOCATION	COMMON AREA ENTRANCE
QUANTITY	01 NO.
OPEN AREA	2.05 SQM.

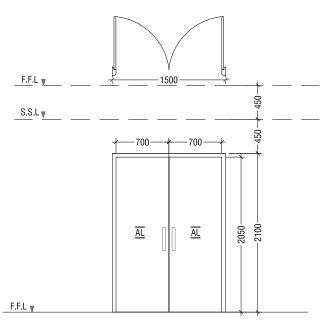

D3	SWING-TYPE DOOR
REMARKS	AL FRAMED DOOR WITH AL PANELS
LOCATION	WORKSHOP & GENERATOR ROOM ENTRANCE
QUANTITY	02 NO.
OPEN AREA	3.48 SQM.
	REMARKS LOCATION QUANTITY

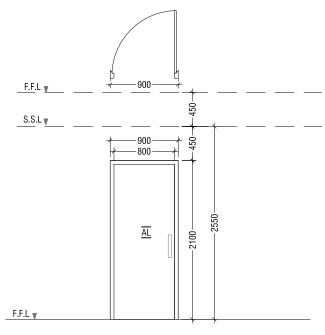

SWING-TYPE DOOR
AL FRAMED DOOR WITH AL PANELS
ENTRANCE DOOR
05 NO.
1.64 SQM.
(

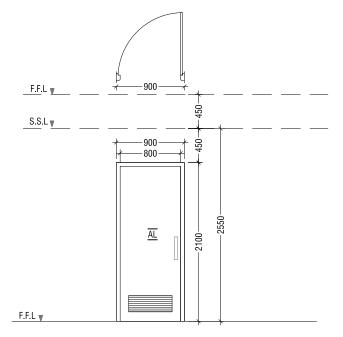

(D2a)	SWING-TYPE DOOR
REMARKS	AL FRAMED DOOR WITH AL PANELS
LOCATION	TOILET
QUANTITY	02 NO.
OPEN AREA	1.64 SQM.

DOOR WINDOW SCHEDULE 01




LEGEND:-AL - ALUMINIUM LOUVERS FR-G - FROSTED GLASS RG - REFLECTIVE GLASS FRG - FIXED REFLECTIVE GLASS

NOTE:-ALL DOORS & WINDOWS TO BE CHECKED ON SITE BEFORE
FABRICATION.
-ALL DOOR & WINDOWS VIEWED FROM EXTERIOR, FOR DOOR
SWING, REFER TO FLOOR PLANS.


-THE DOORS / WINDOWS WHICH DOES NOT TOUCH THE BEAM PLEASE PUT A LINTEL BEAM (LB) ABOVE THE DOOR / WINDOW. CONSULTANCY SERVICES FOR SURVEY & DESIGN
OF SEWERAGE FACILITIES IN HA.BAARAH, MALDIVES
CLIENT: MINISTRY OF ENVIRONMENT AND ENERGY
PROJECT NUMBER:
DATE: MARCH 2017
ENGINER: - Nohamed Saif Saeed
CHECKED BY: - Ihsan Waheed
DRAWN RV: **:

RIYAN PRIVATE LIMITED


Title: DOOR & WINDOW SCHEDULE 01 Page: A -15/28

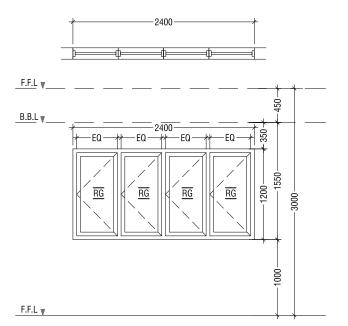


W1)	SWING TYPE WINDOW
REMARKS	WHITE POWDER COATED ALUMINIUM WINDOW WITH REFLECTIVE DOUBLE GLAZED GLASS PANELS
LOCATION	COMMOM AREA
QUANTITY	01 NOS
OPEN AREA	2.82 SQM.

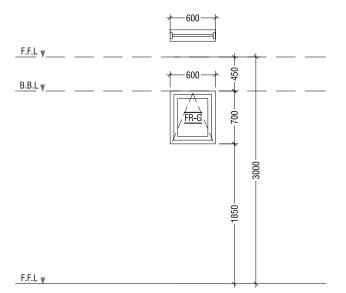

(V1)	SWING TYPE WINDOW
REMARKS	WHITE POWDER COATED ALUMINIUM WINDOW WITH FROSTED GLASS PANELS
LOCATION	TOILET
QUANTITY	01 NOS
OPEN AREA	0.35 SQM.

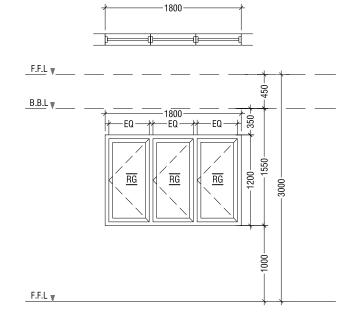

W2)	SWING TYPE WINDOW
REMAF	KS	WHITE POWDER COATED ALUMINIUM WINDOW WITH REFLECTIVE DOUBLE GLAZED GLASS PANELS
LOCATI	ON	LAB & OFFICE AREA
QUANT	ITY	04 NOS
OPEN A	REA	2.82 SQM.

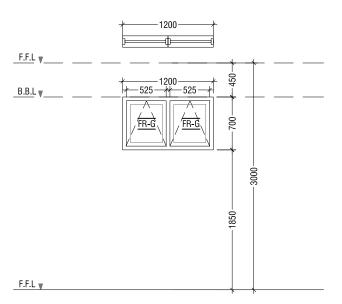

	V2	SWING TYPE WINDOW		
	REMARKS	WHITE POWDER COATED ALUMINIUM WINDOW WITH FROSTED GLASS PANELS		
	LOCATION	MACHINE / PUMP / WORKROOM		
	QUANTITY	12 NOS		
	OPEN AREA	0.64 SQM.		

DOOR WINDOW SCHEDULE 02

SCALE 1:50
0 0.25 0.5 1 1.5 2 2.5

LEGEND:-AL - ALUMINIUM LOUVERS FR-G - FROSTED GLASS RG - REFLECTIVE GLASS FRG - FIXED REFLECTIVE GLASS

NOTE:-ALL DOORS & WINDOWS TO BE CHECKED ON SITE BEFORE FABRICATION.

-ALL DOOR & WINDOWS VIEWED FROM EXTERIOR, FOR DOOR SWING, REFER TO FLOOR PLANS.
-THE DOORS / WINDOWS WHICH DOES NOT TOUCH THE BEAM PLEASE PUT A LINTEL BEAM (LB) ABOVE THE DOOR / WINDOW.

CONSULTANCY SERVICES FOR SURVEY & DESIGN
OF SEWERAGE FACILITIES IN HA BAARAH, MALDIVES
CLIENT: MINISTRY OF ENVIRONMENT AND ENERGY
PROJECT WARCH 2017
ENGINER: Mohamed Saff Saeed
CHECKED BY: Itsan Waheed
DARAWN BY: Itsan Waheed

RIYAN PRIVATE LIMITED

Title: Door window schedule 02
Page: A -16/28