

# **PROPOSED 6 CLASSROOM BLOCK & MULTI PURPOSE HALL BLOCK IN MEYNAA SCHOOL AT N.HOLHUDHOO**

**( 3 STOREY )**

**ENHANCING EDUCATION DEVELOPMENT PROJECT (EEDP)**


**DETAIL DRAWINGS**

AUGUST 2015

CLIENT : MINISTRY OF EDUCATION

DESIGN BY

**ArchEng**  
s t u d i o  
Ma Fiyajahaage, 1st floor, Male'. Republic of Maldives  
admin@archeng.biz

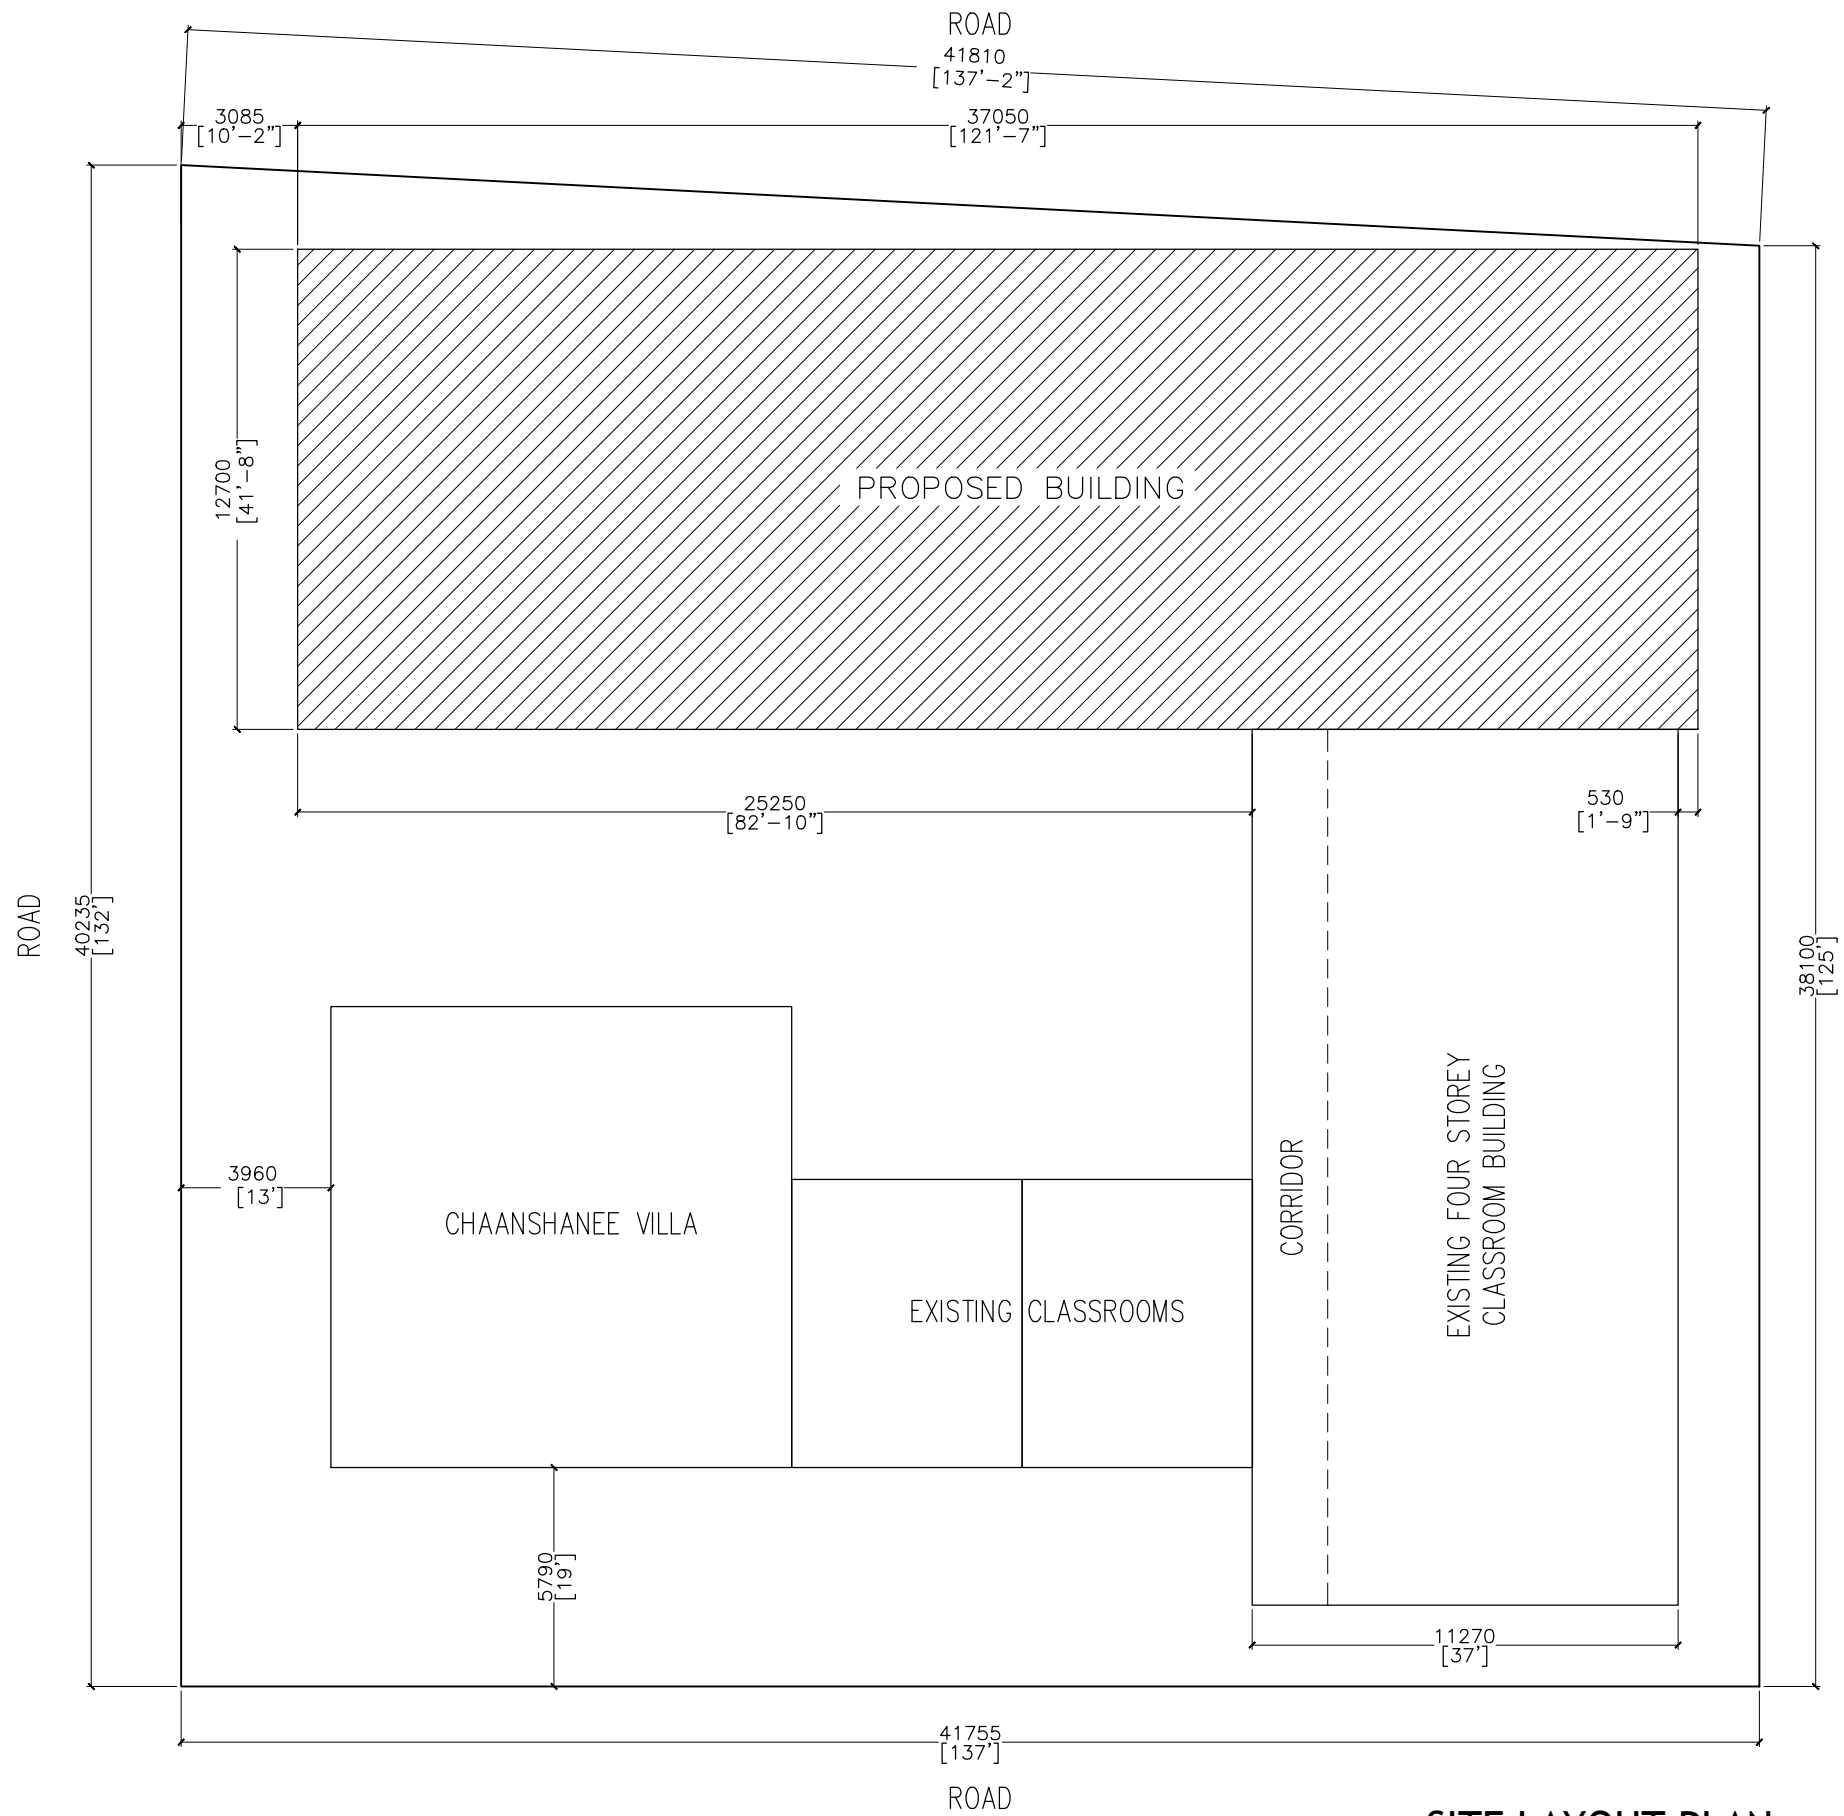

SITE LAYOUT PLAN  
SCALE 1:200

CONTRACTORS MUST  
CHECK ALL  
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DRAWINGS.FIGURED  
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SCALE READINGS




REVISION:

ARCHITECT:	MOHAMED HAMEEN
ENGINEER:	MOHAMED AHSAN
SERVICES ENG:	
ESTIMATOR:	
DRAWN BY:	

PROJECT:	6 CLASSROOM BLOCK, MULTI PURPOSE HALL BLOCK IN MEYNAA SCHOOL		
LOCATION:	HA-HOLHUDHOO		
DRAWING TITLE:	AS GIVEN		
CLIENT:	MINISTRY OF EDUCATION		
SCALE:	AS GIVEN	DIMENSION: MM	DATE: AUJUST 2015

A-01	DWG NO
	PROJECT NO.: 14-124

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GROUND FLOOR LAYOUT PLAN  
SCALE 1:100
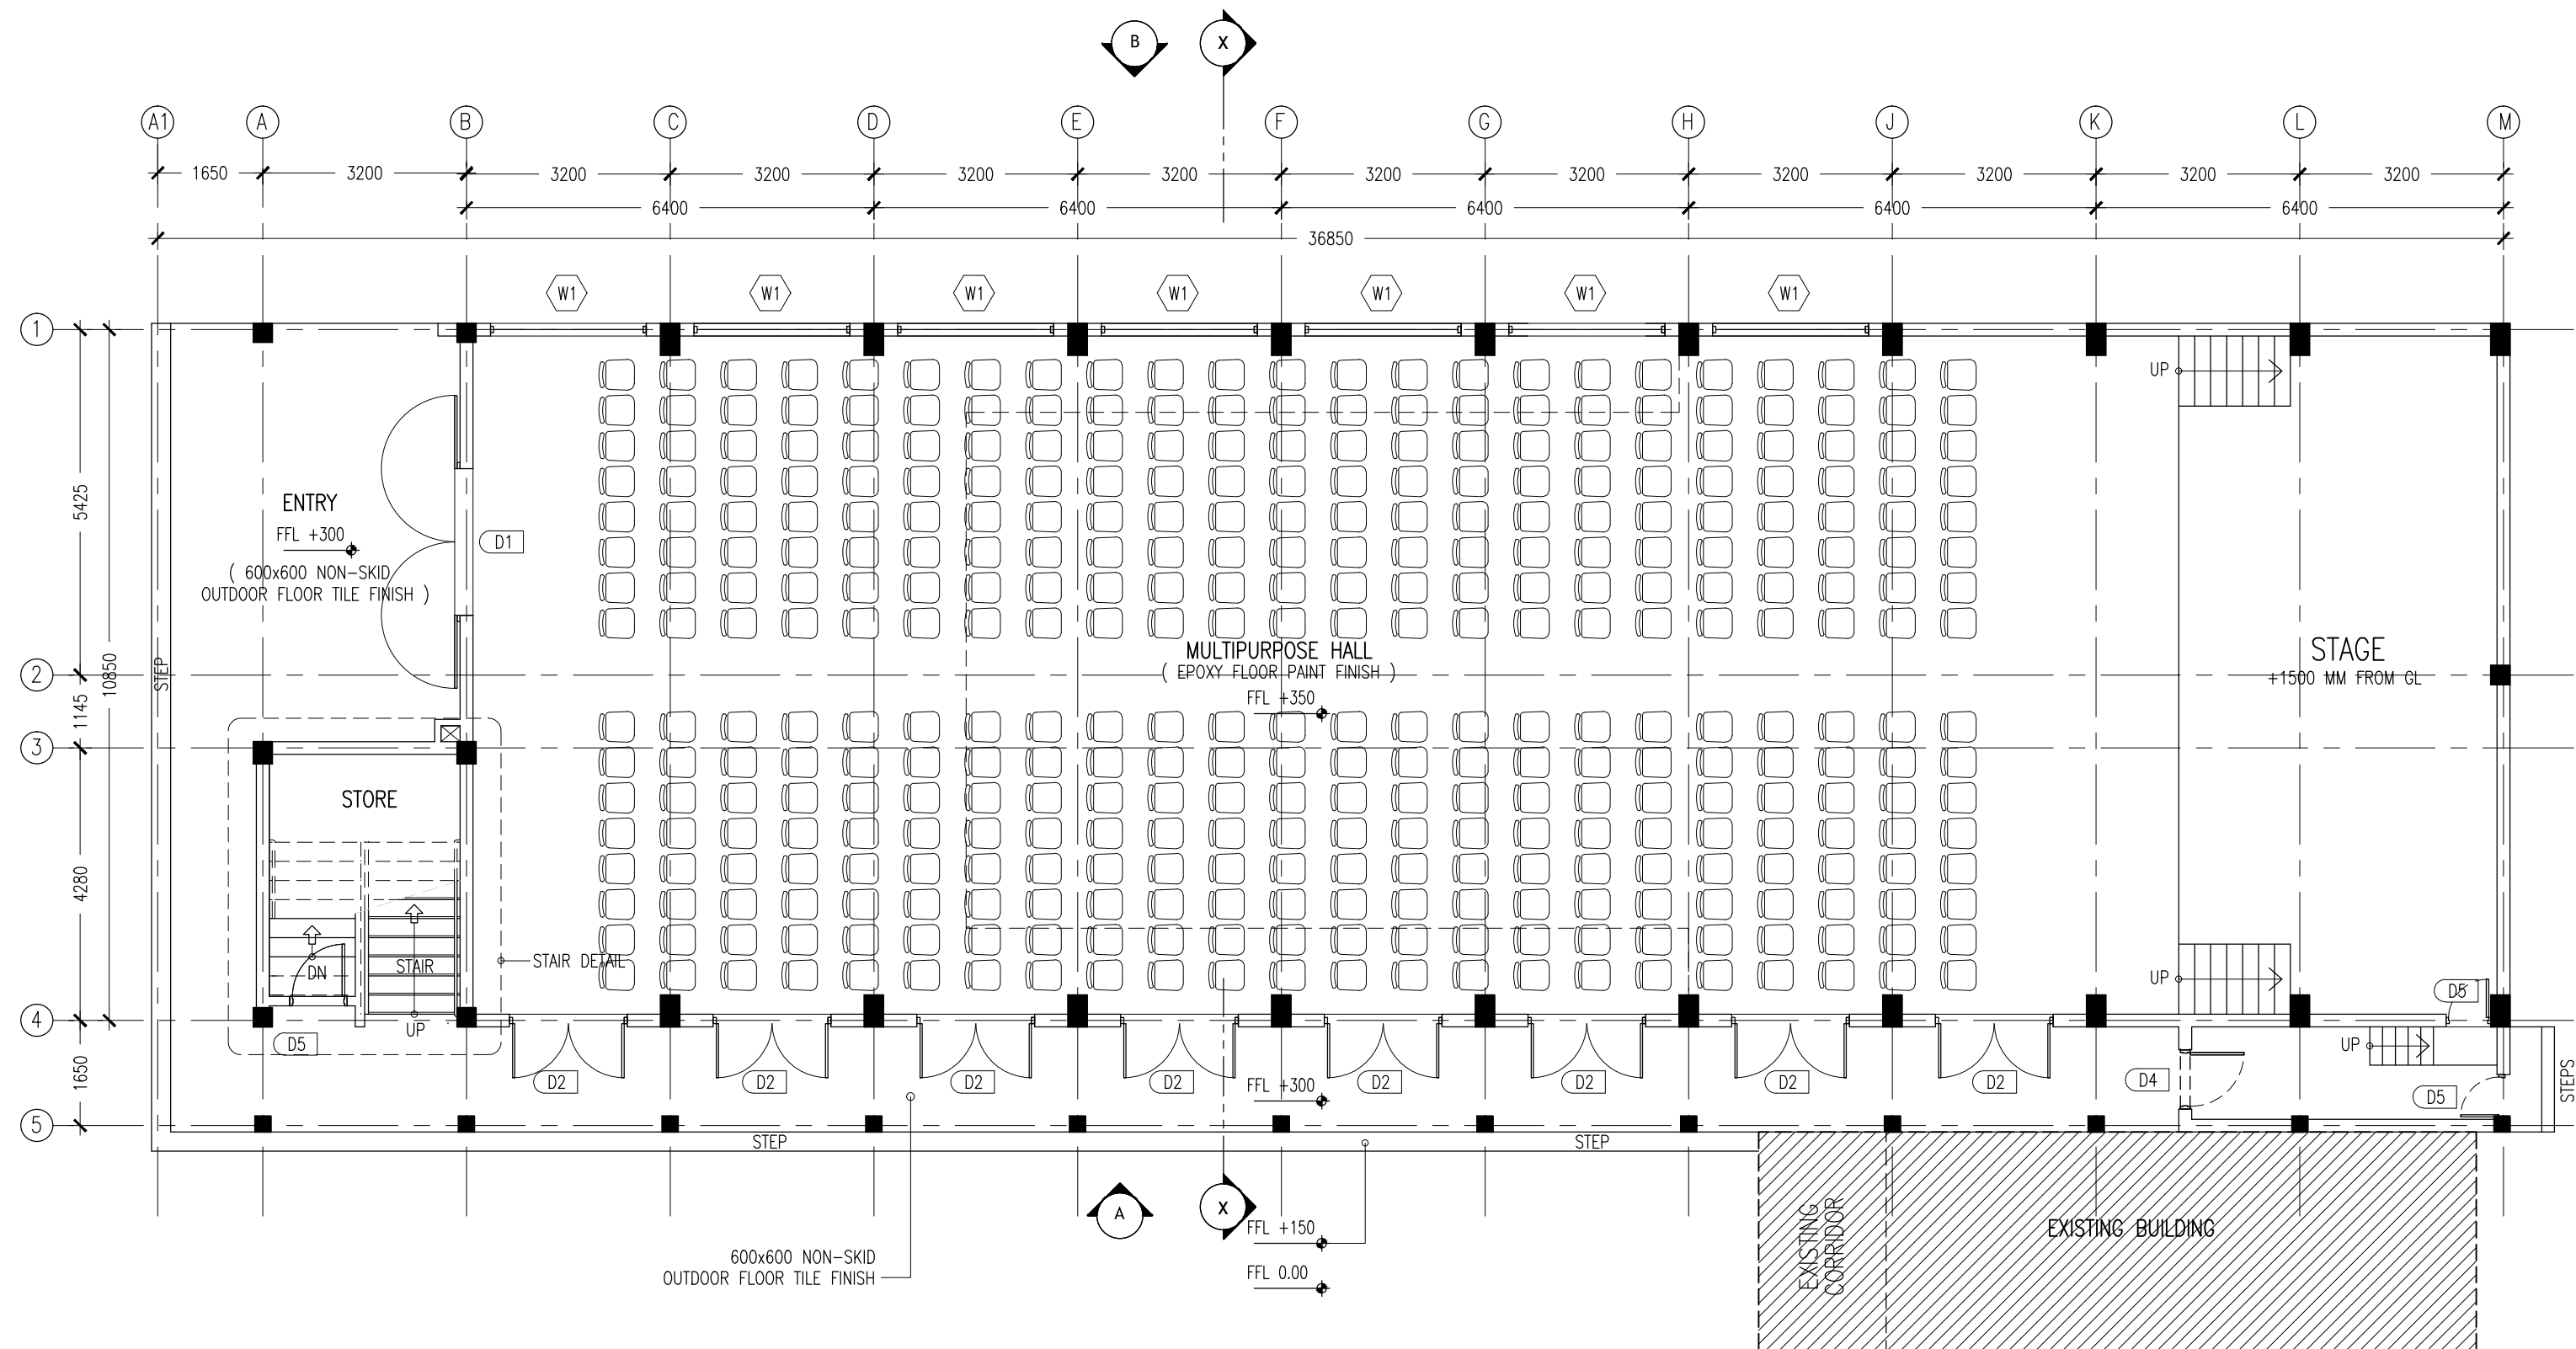
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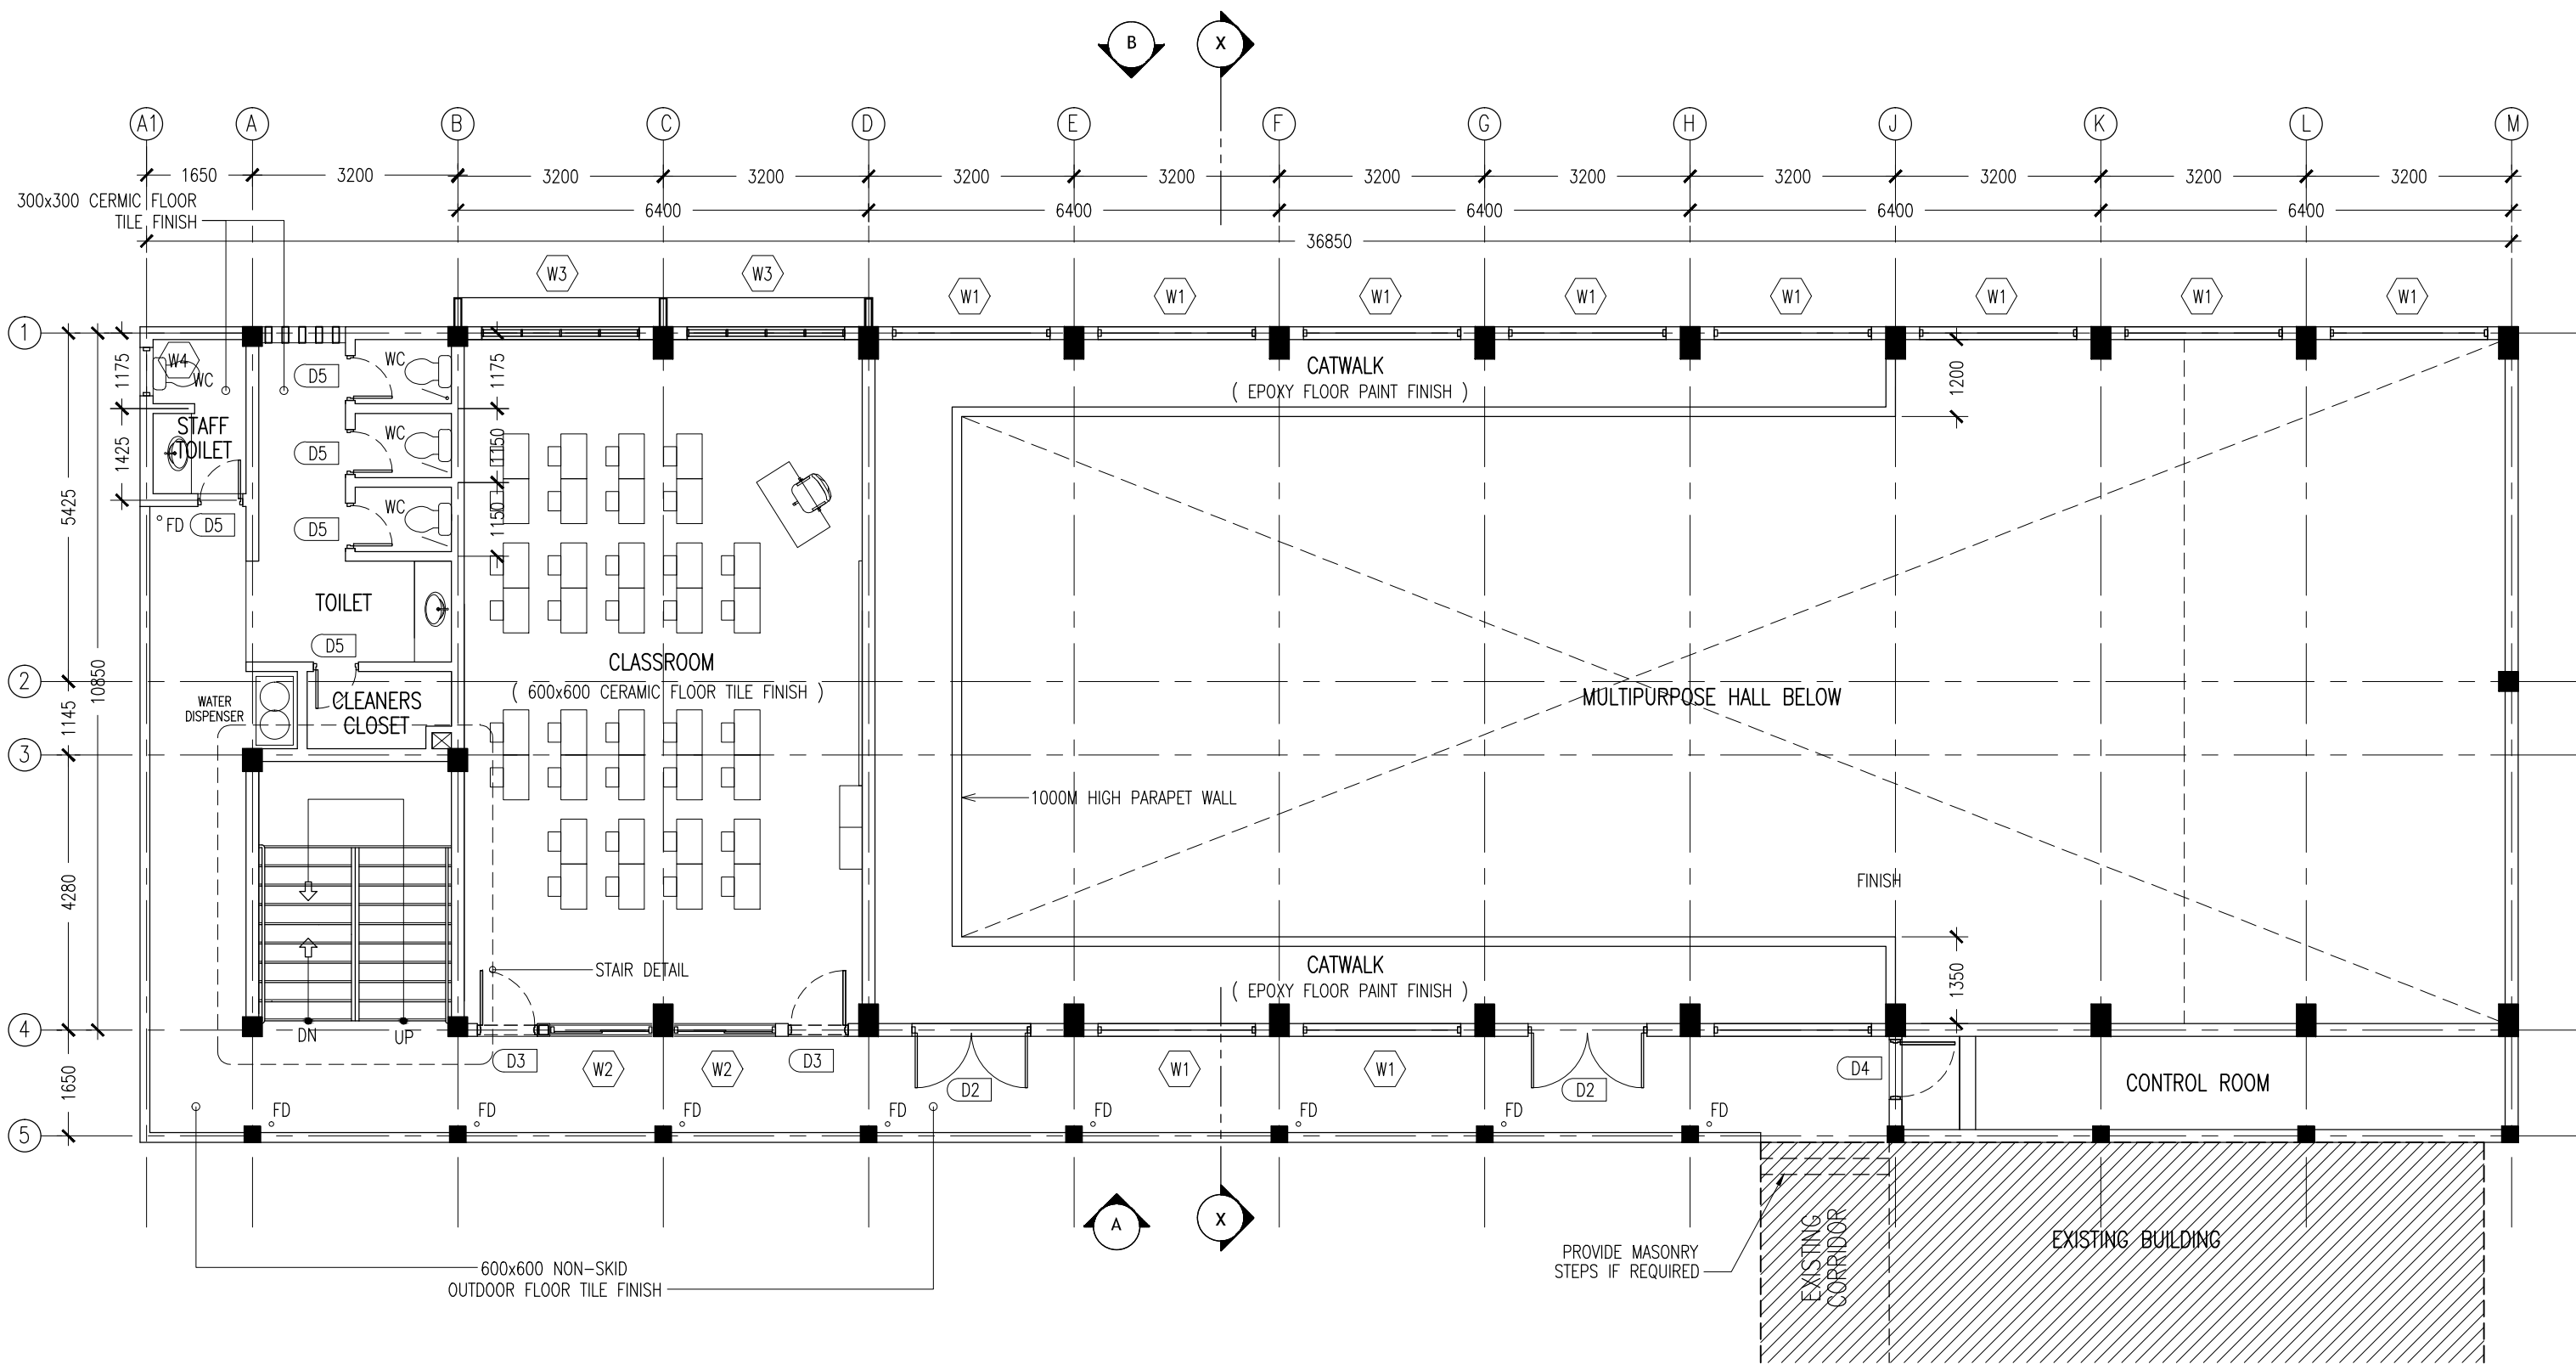
REVISION:	

ARCHITECT:	MOHAMED HAMEEN
ENGINEER:	MOHAMED AHSAN
SERVICES ENG:	
ESTIMATOR:	
DRAWN BY:	

PROJECT:	6 CLASSROOM BLOCK, MULTI PURPOSE HALL BLOCK IN MEYNAA SCHOOL
LOCATION:	HA,HOLHUDDOO
DRAWING TITLE:	AS GIVEN
CLIENT:	MINISTRY OF EDUCATION
SCALE:	AS GIVEN
DIMENSION:	MM
DATE:	AUJULY 2015

A-02  
DWG NO  
PROJECT NO.: 14-124

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1ST FLOOR LAYOUT PLAN

SCALE 1:100

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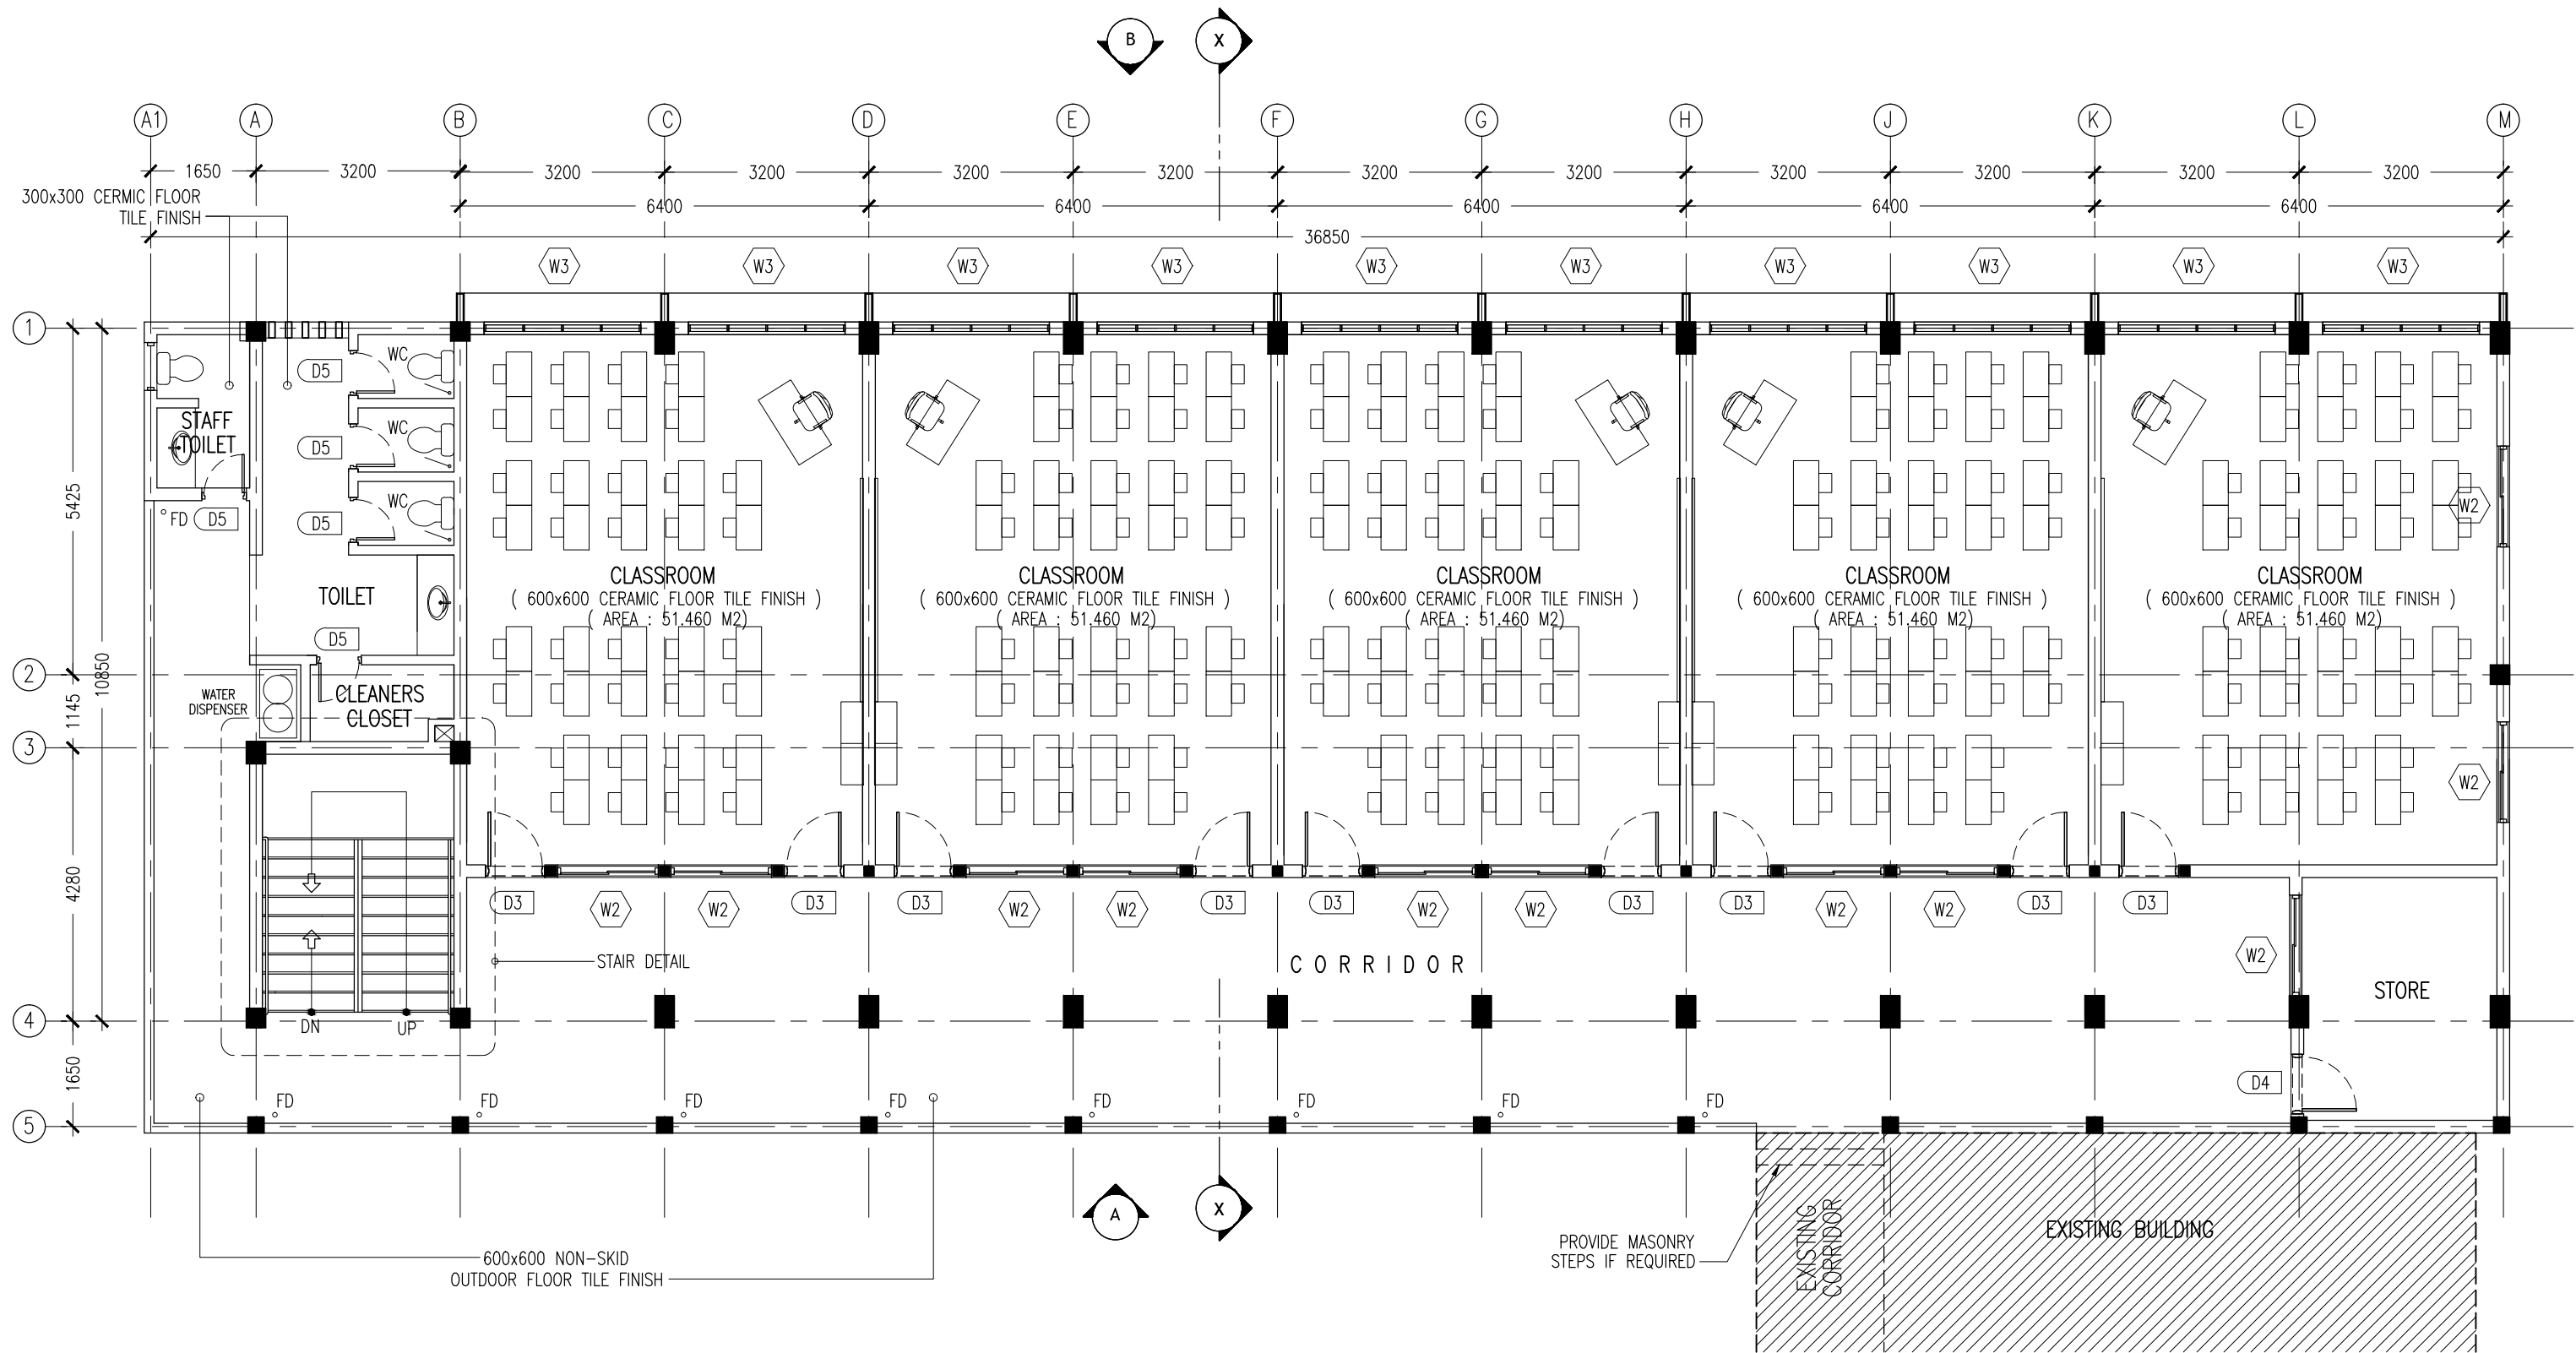
ARCHITECT:	MOHAMED HAMEEN
ENGINEER:	MOHAMED AHSAN
SERVICES ENG:	
ESTIMATOR:	
DRAWN BY:	

PROJECT:	6 CLASSROOM BLOCK, MULTI PURPOSE HALL BLOCK IN MEYNAA SCHOOL
LOCATION:	HA, HOLHUDHOO
DRAWING TITLE:	AS GIVEN
CLIENT:	MINISTRY OF EDUCATION
SCALE:	AS GIVEN
DIMENSION:	MM
DATE:	AUGUST 2015

A-03

DWG NO  
PROJECT NO.: 14-124

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## 2ND FLOOR LAYOUT PLAN

SCALE 1:100

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**ArchEng**  
s t u d i o  
Ma Fiyajahaage, 1st floor, Male', Republic of Maldives  
admin@archeng.biz

REVISION:  
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\_\_\_\_\_  
\_\_\_\_\_  
\_\_\_\_\_


ARCHITECT: MOHAMED HAMEEN  
ENGINEER: MOHAMED AHSAN  
SERVICES ENG:  
ESTIMATOR:  
DRAWN BY:

PROJECT: 6 CLASSROOM BLOCK, MULTI PURPOSE HALL BLOCK IN MEYNAA SCHOOL  
LOCATION: HA.HOLHUDHOO  
DRAWING TITLE: AS GIVEN  
CLIENT: MINISTRY OF EDUCATION  
SCALE: AS GIVEN DIMENSION: MM DATE: AUJUG 2015

**A-04**

DWG NO  
PROJECT NO.: 14-124

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## ROOF LAYOUT PLAN

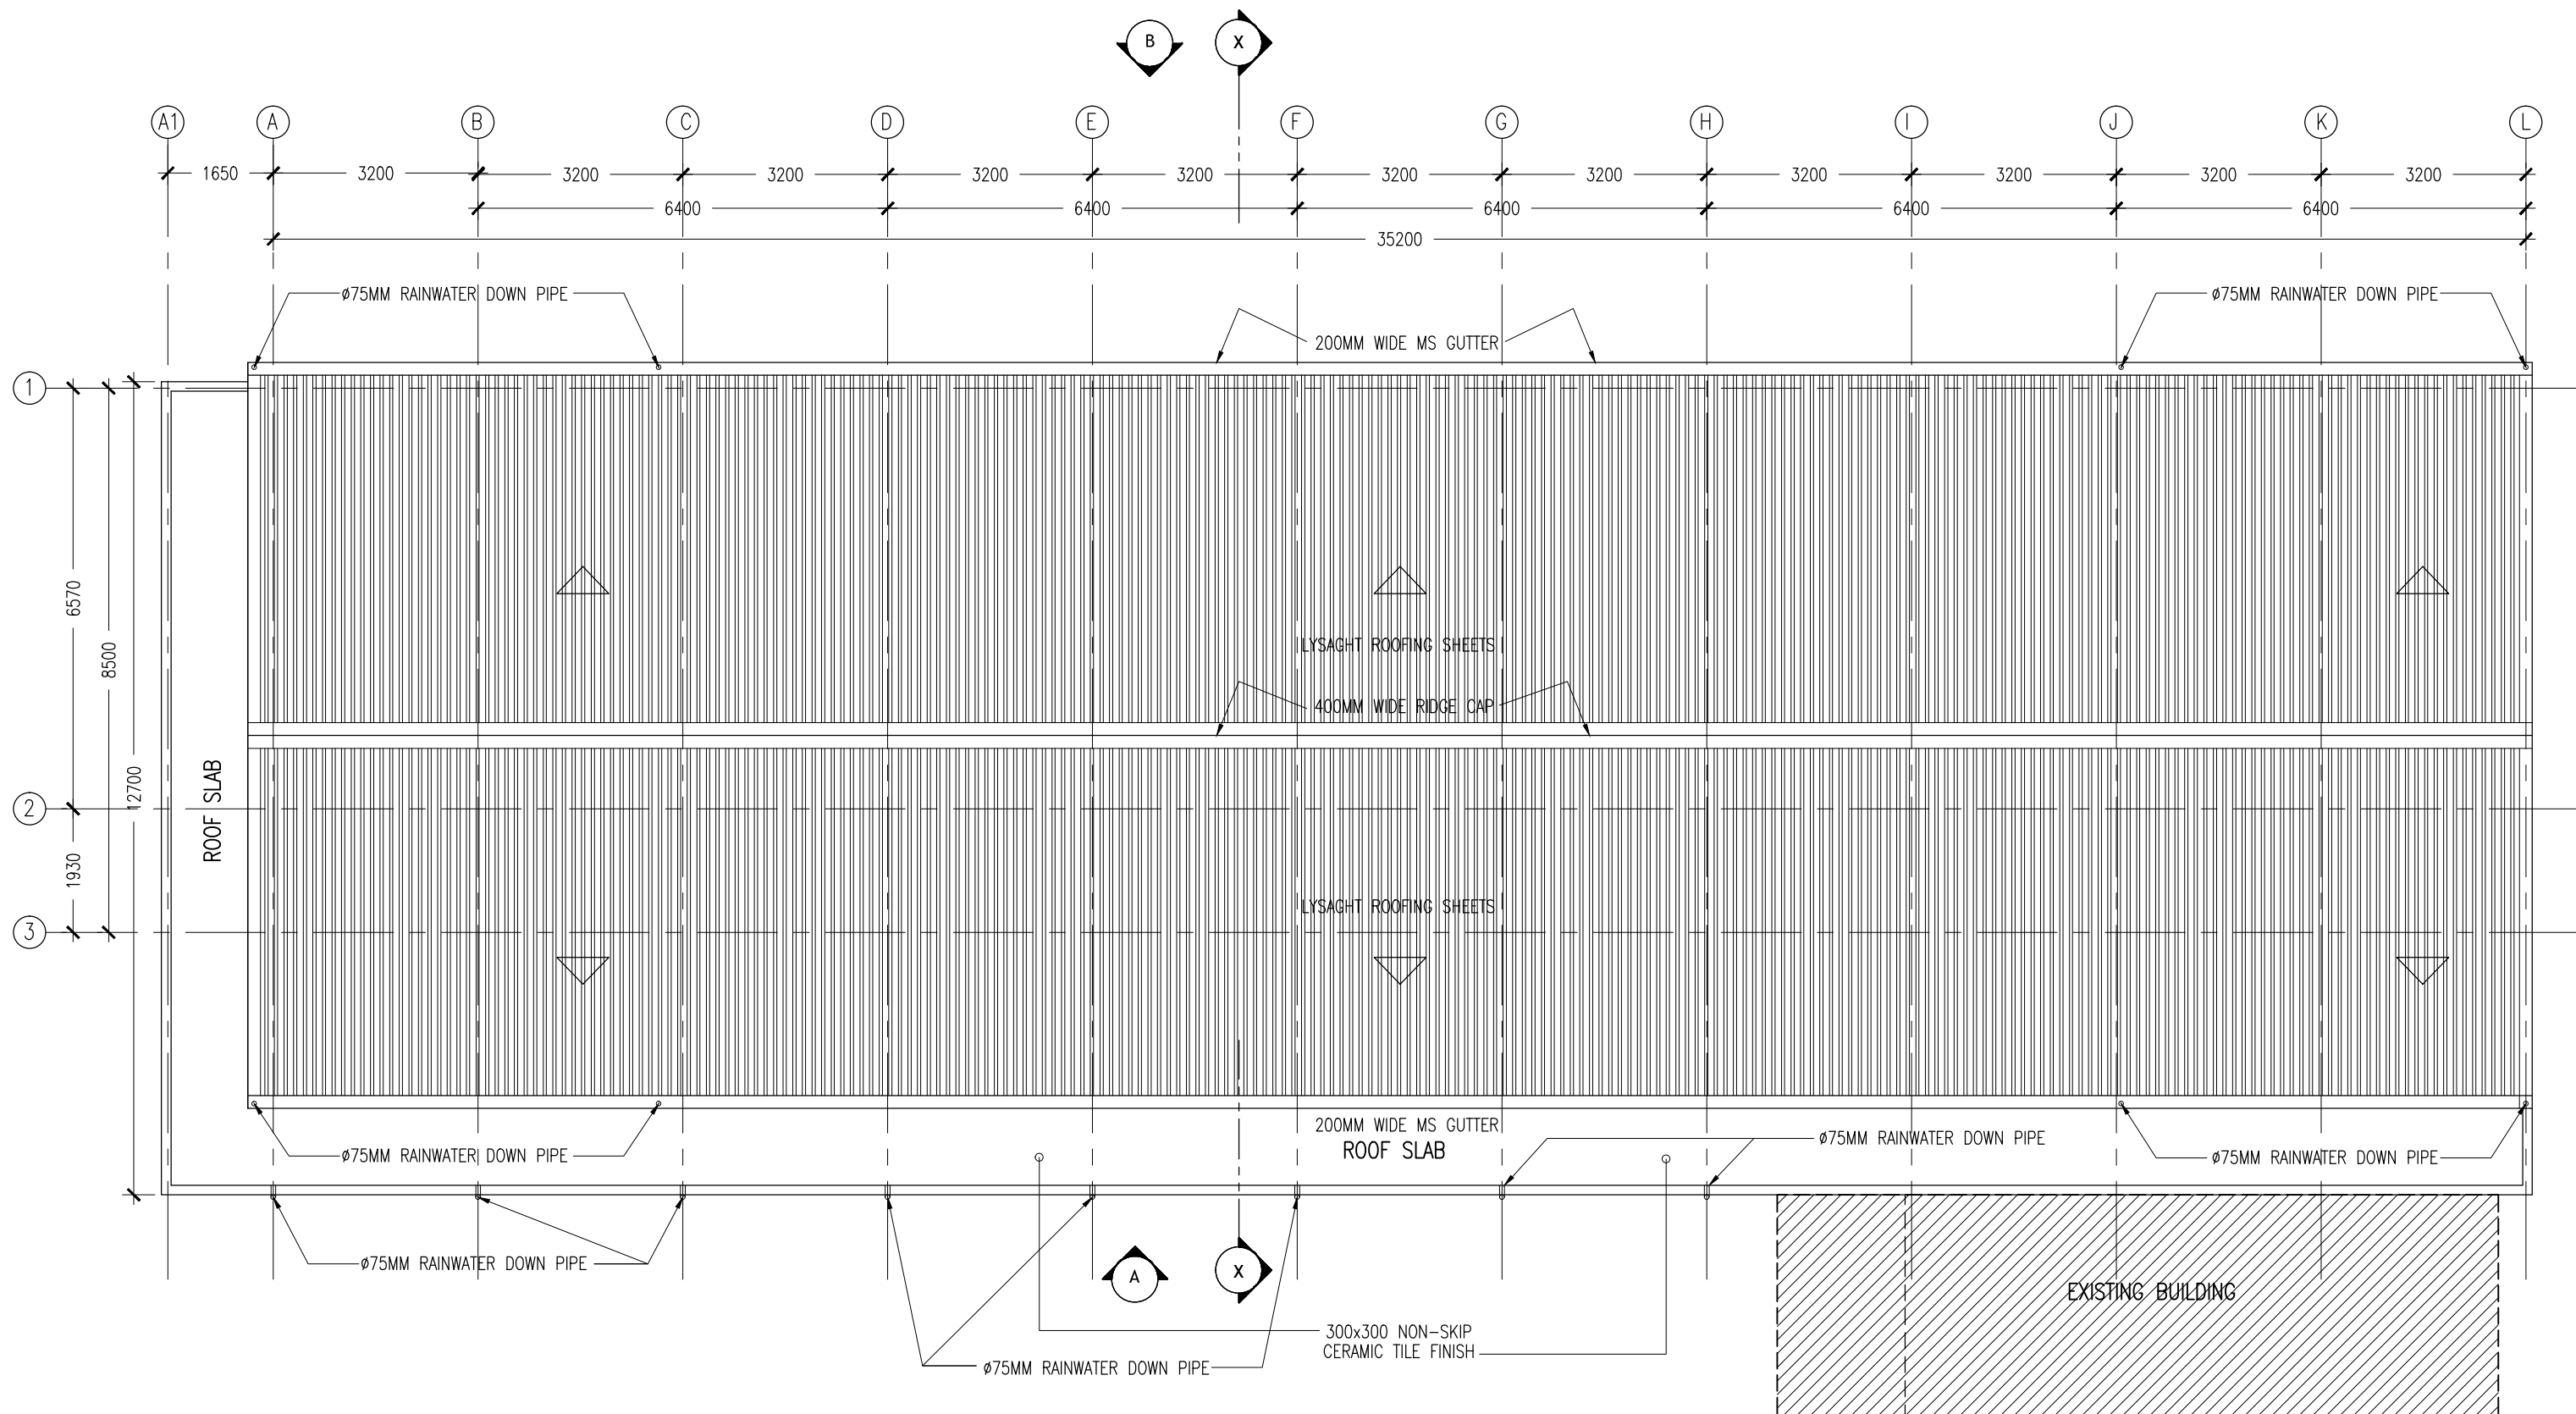SCALE 1:100

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**ArchEng**  
studio  
Ma Fiyajahaage, 1st floor, Male', Republic of Maldives  
admin@archeng.biz

REVISION:

\_\_\_\_\_  
\_\_\_\_\_  
\_\_\_\_\_  
\_\_\_\_\_

ARCHITECT: MOHAMED HAMEEN

ENGINEER: MOHAMED AHSAN

SERVICES ENG:

ESTIMATOR:

DRAWN BY:

PROJECT: 6 CLASSROOM BLOCK, MULTI PURPOSE HALL BLOCK IN MEYNAA SCHOOL

LOCATION: HA, HOLHUDHOO

DRAWING TITLE: AS GIVEN

CLIENT: MINISTRY OF EDUCATION

SCALE: AS GIVEN

DIMENSION: MM

DATE: AUGUST 2015

**A-05**

DWG NO

PROJECT NO.: 14-124

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ELEVATION -A  
SCALE 1:100

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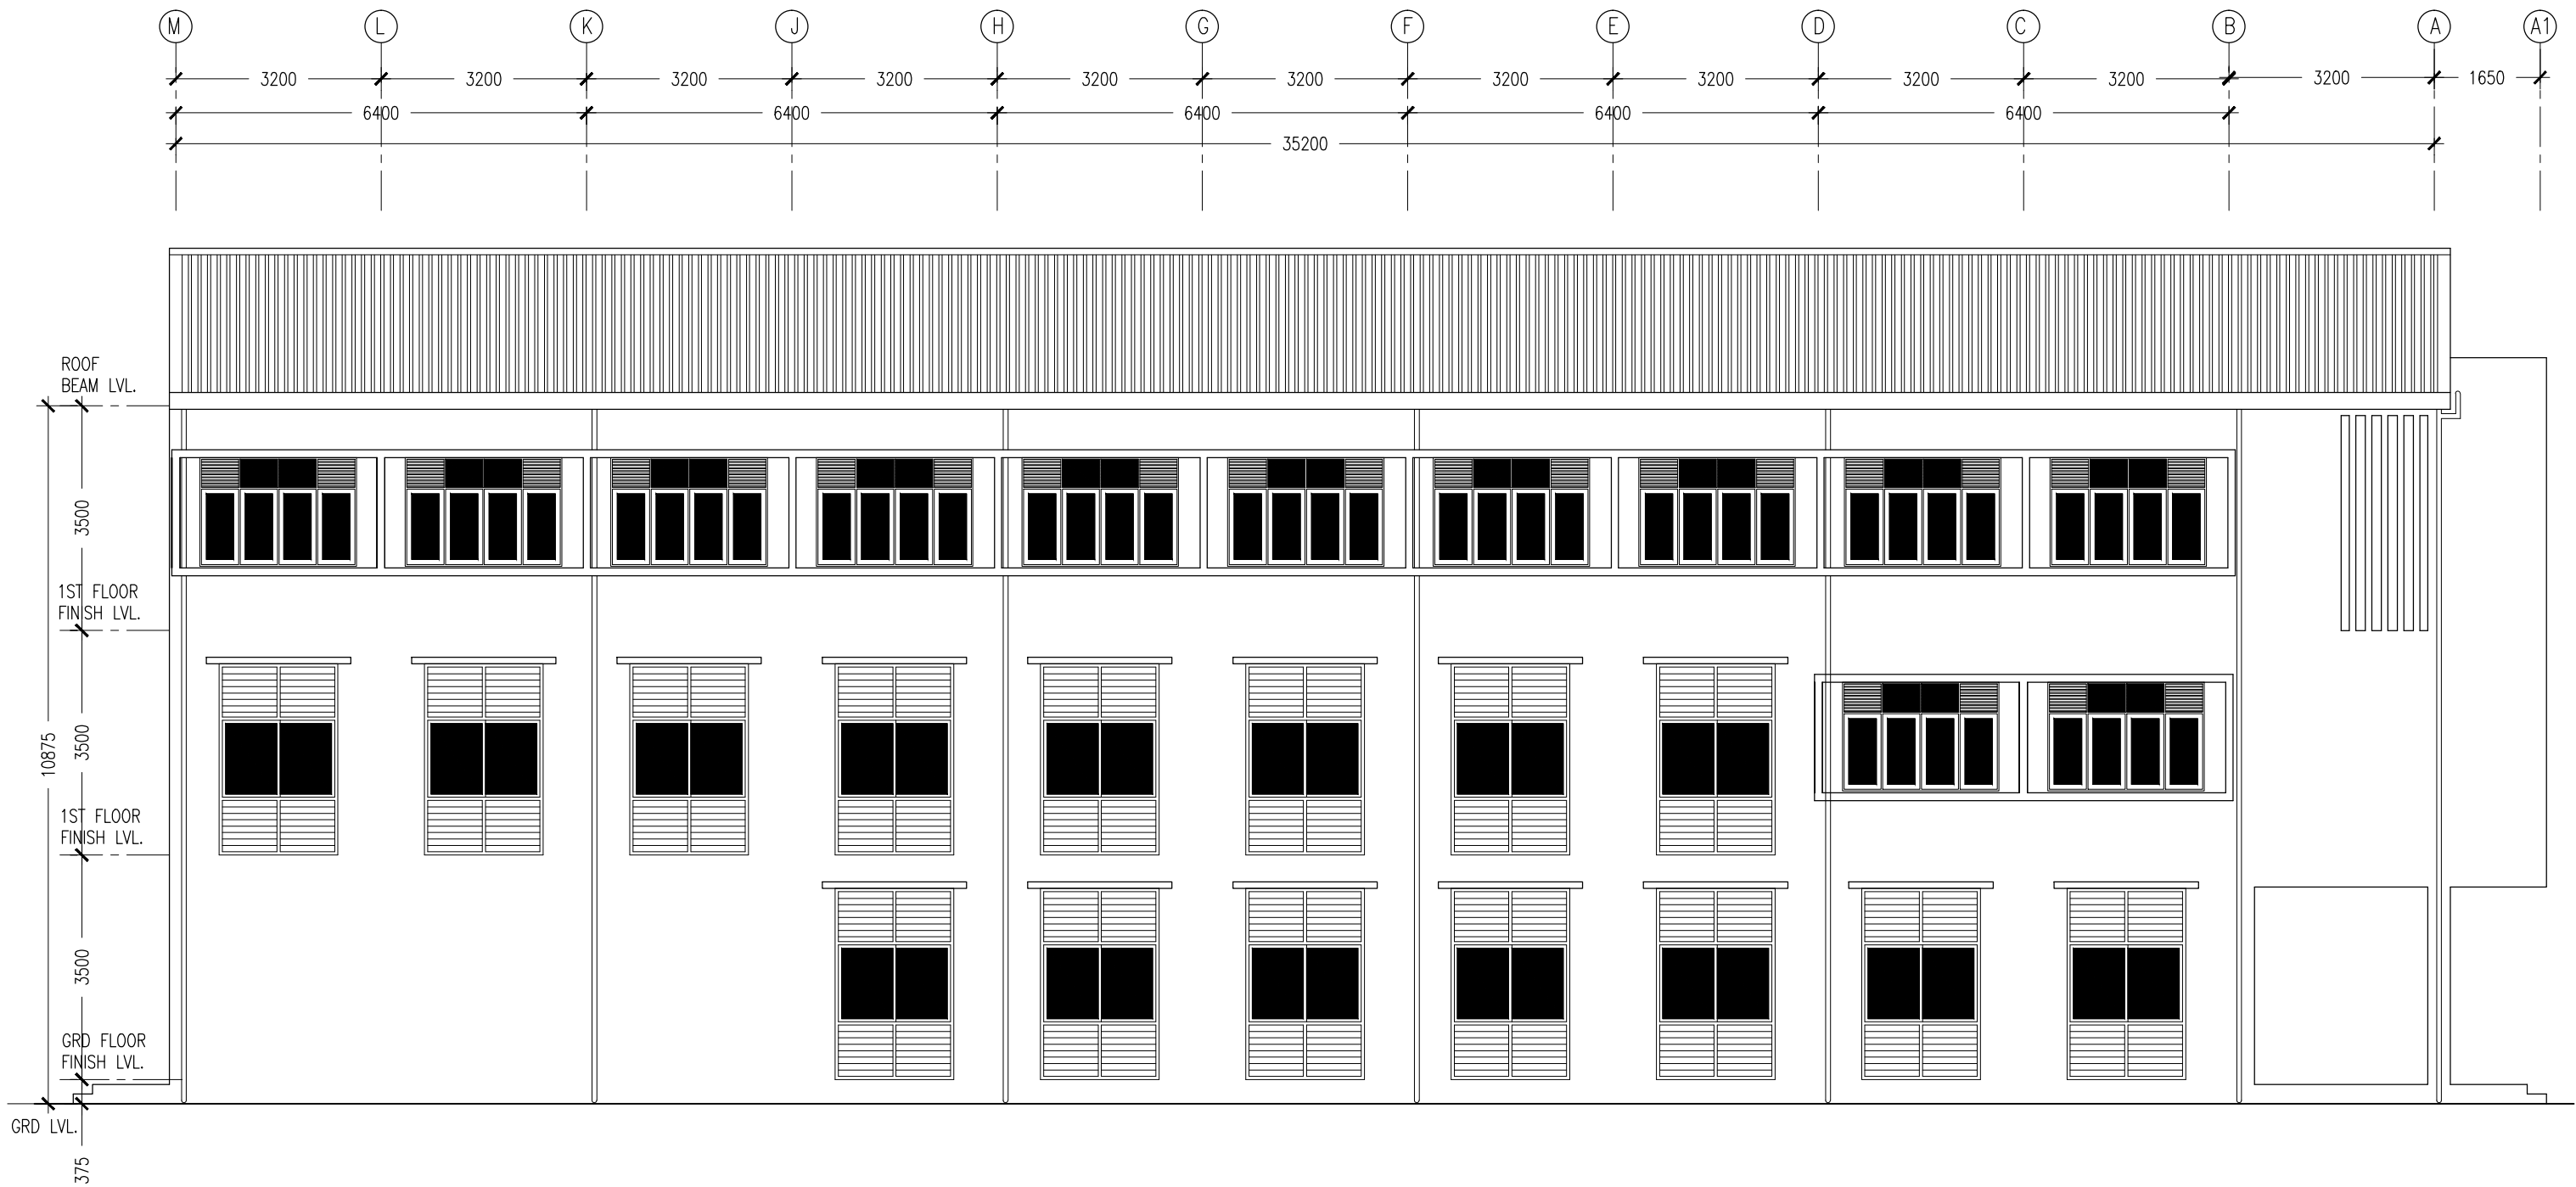
REVISION:  
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ARCHITECT: MOHAMED HAMEEN  
ENGINEER: MOHAMED AHSAN  
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ESTIMATOR:  
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PROJECT: 6 CLASSROOM BLOCK, MULTI PURPOSE HALL BLOCK IN MEYNAA SCHOOL  
LOCATION: HA.HOLHUDHOO  
DRAWING TITLE: AS GIVEN  
CLIENT: MINISTRY OF EDUCATION  
SCALE: AS GIVEN    DIMENSION: MM    DATE: AUJUS 2015

A-06  
DWG NO  
PROJECT NO.: 14-124

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ELEVATION -B  
SCALE 1:100

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REVISION:

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ENGINEER: MOHAMED AHSAN  
SERVICES ENG:  
ESTIMATOR:  
DRAWN BY:


PROJECT: 6 CLASSROOM BLOCK, MULTI PURPOSE HALL BLOCK IN MEYNAA SCHOOL  
LOCATION: HA-HOLHUDHOO  
DRAWING TITLE: AS GIVEN  
CLIENT: MINISTRY OF EDUCATION  
SCALE: AS GIVEN DIMENSION: MM DATE: AUJUST 2015

A-07

DWG NO  
PROJECT NO.: 14-124

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SECTION X-X  
SCALE 1:100

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**ArchEng**  
studio  
Ma Fiyajahaage, 1st floor, Male', Republic of Maldives  
admin@archeng.biz

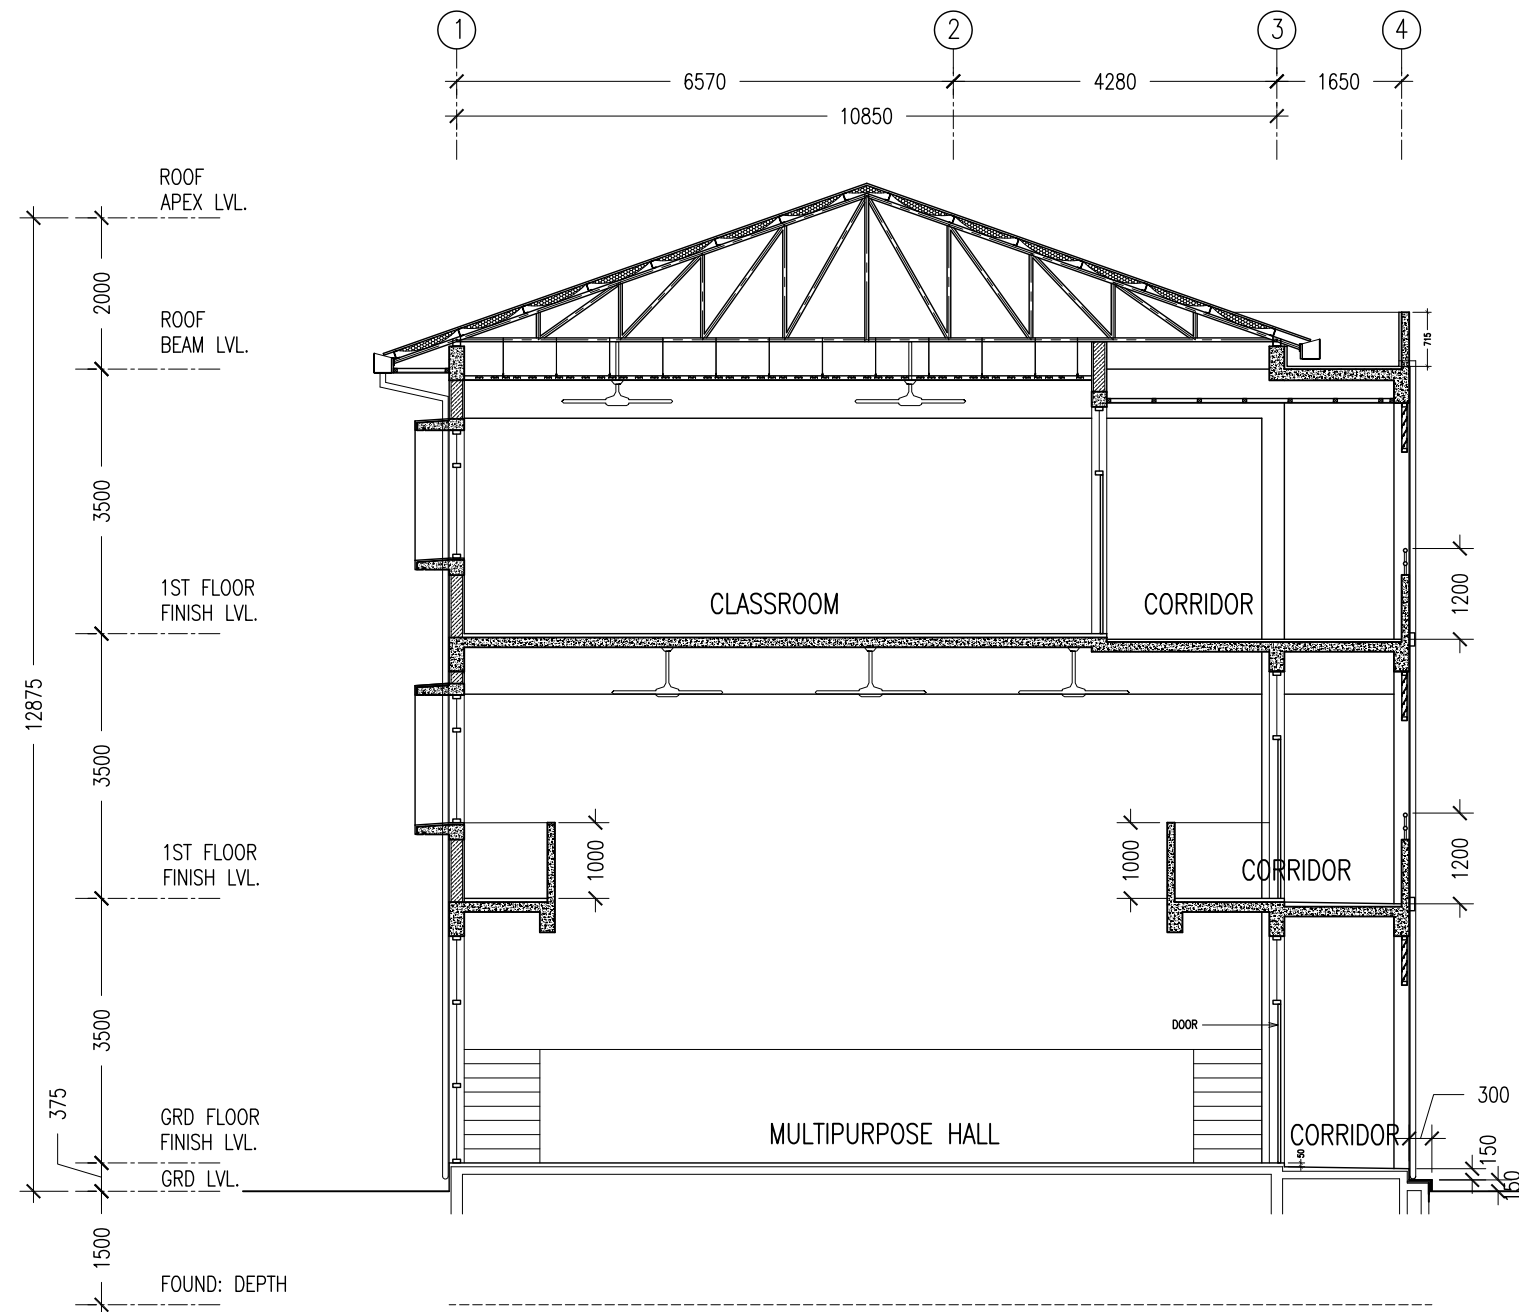
REVISION:  
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ARCHITECT: MOHAMED HAMEEN  
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ESTIMATOR:  
DRAWN BY:

PROJECT: 6 CLASSROOM BLOCK, MULTIPURPOSE HALL BLOCK IN MEYNAA SCHOOL  
LOCATION: HA.HOLHUDHOO  
DRAWING TITLE: AS GIVEN  
CLIENT: MINISTRY OF EDUCATION  
SCALE: AS GIVEN DIMENSION: MM DATE: AUUGUST 2015

**A-07a**  
DWG NO  
PROJECT NO.: 14-124

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**ArchEng**  
studio

Ma Fiyajahaage, 1st floor, Male, Republic of Maldives  
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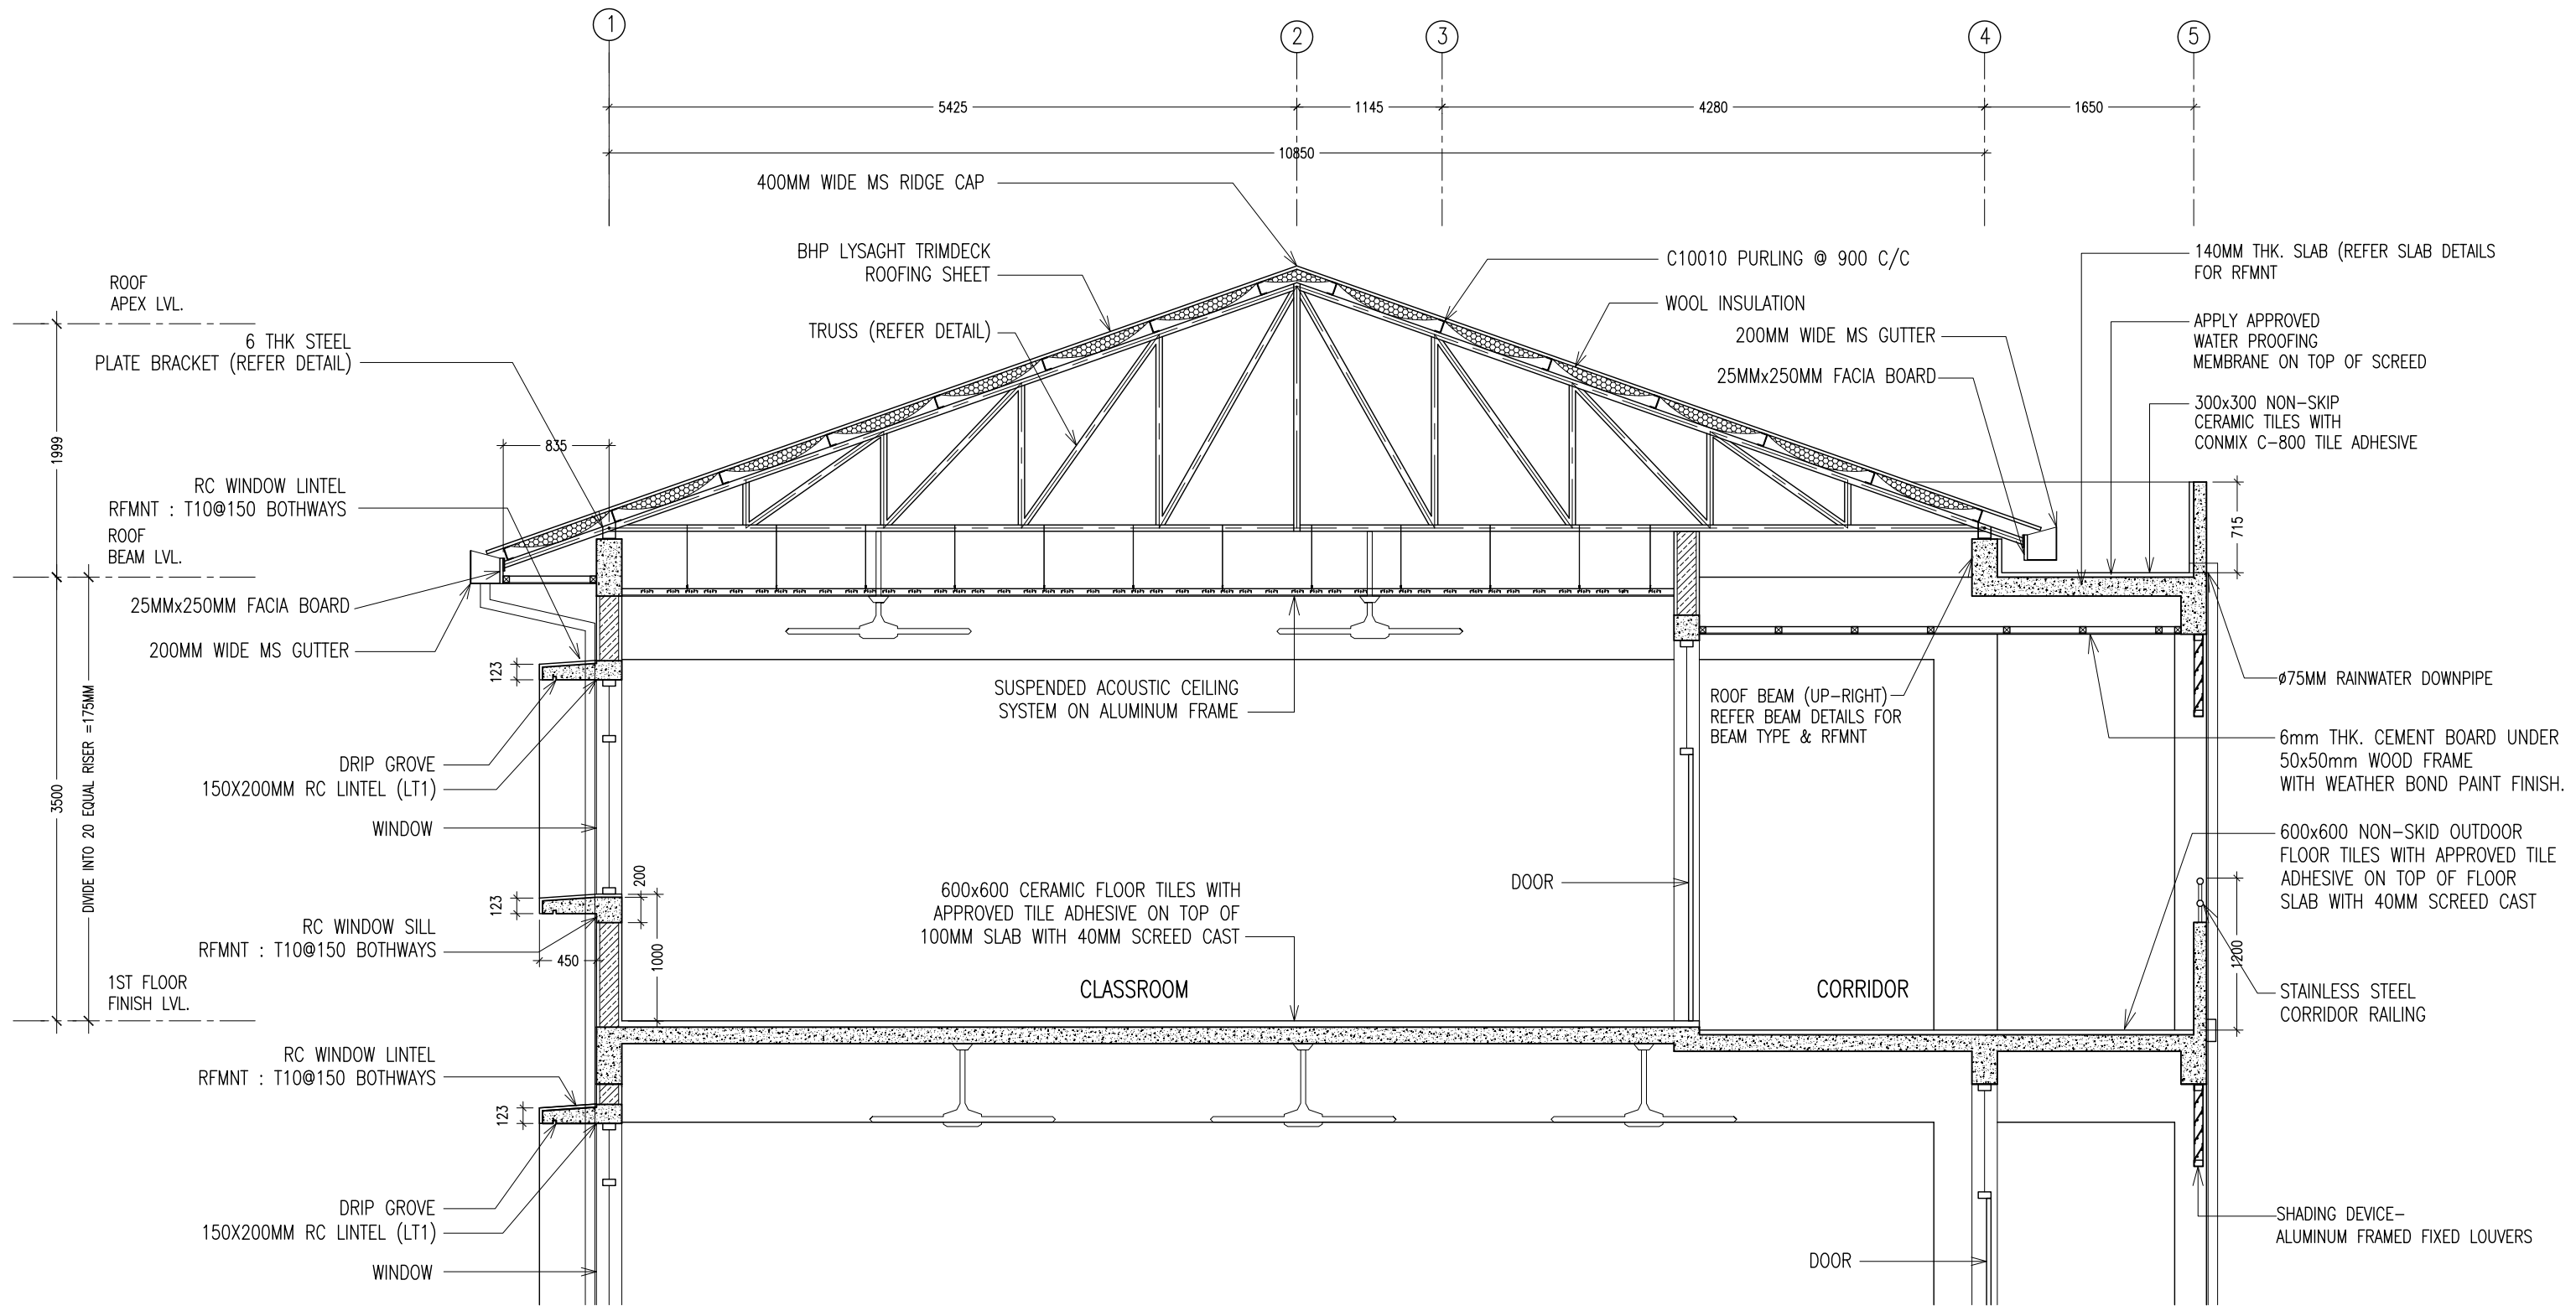
PROJECT:	6 CLASSROOM BLOCK, MULTI PURPOSE HALL BLOCK IN MEYNAA SCHOOL		
LOCATION:	HAJOLHUDHOO		
DRAWING TITLE:	AS GIVEN		
CLIENT:	MINISTRY OF EDUCATION		
SCALE:	AS GIVEN	DIMENSION:	MM
DATE:	AUGUST 2015		

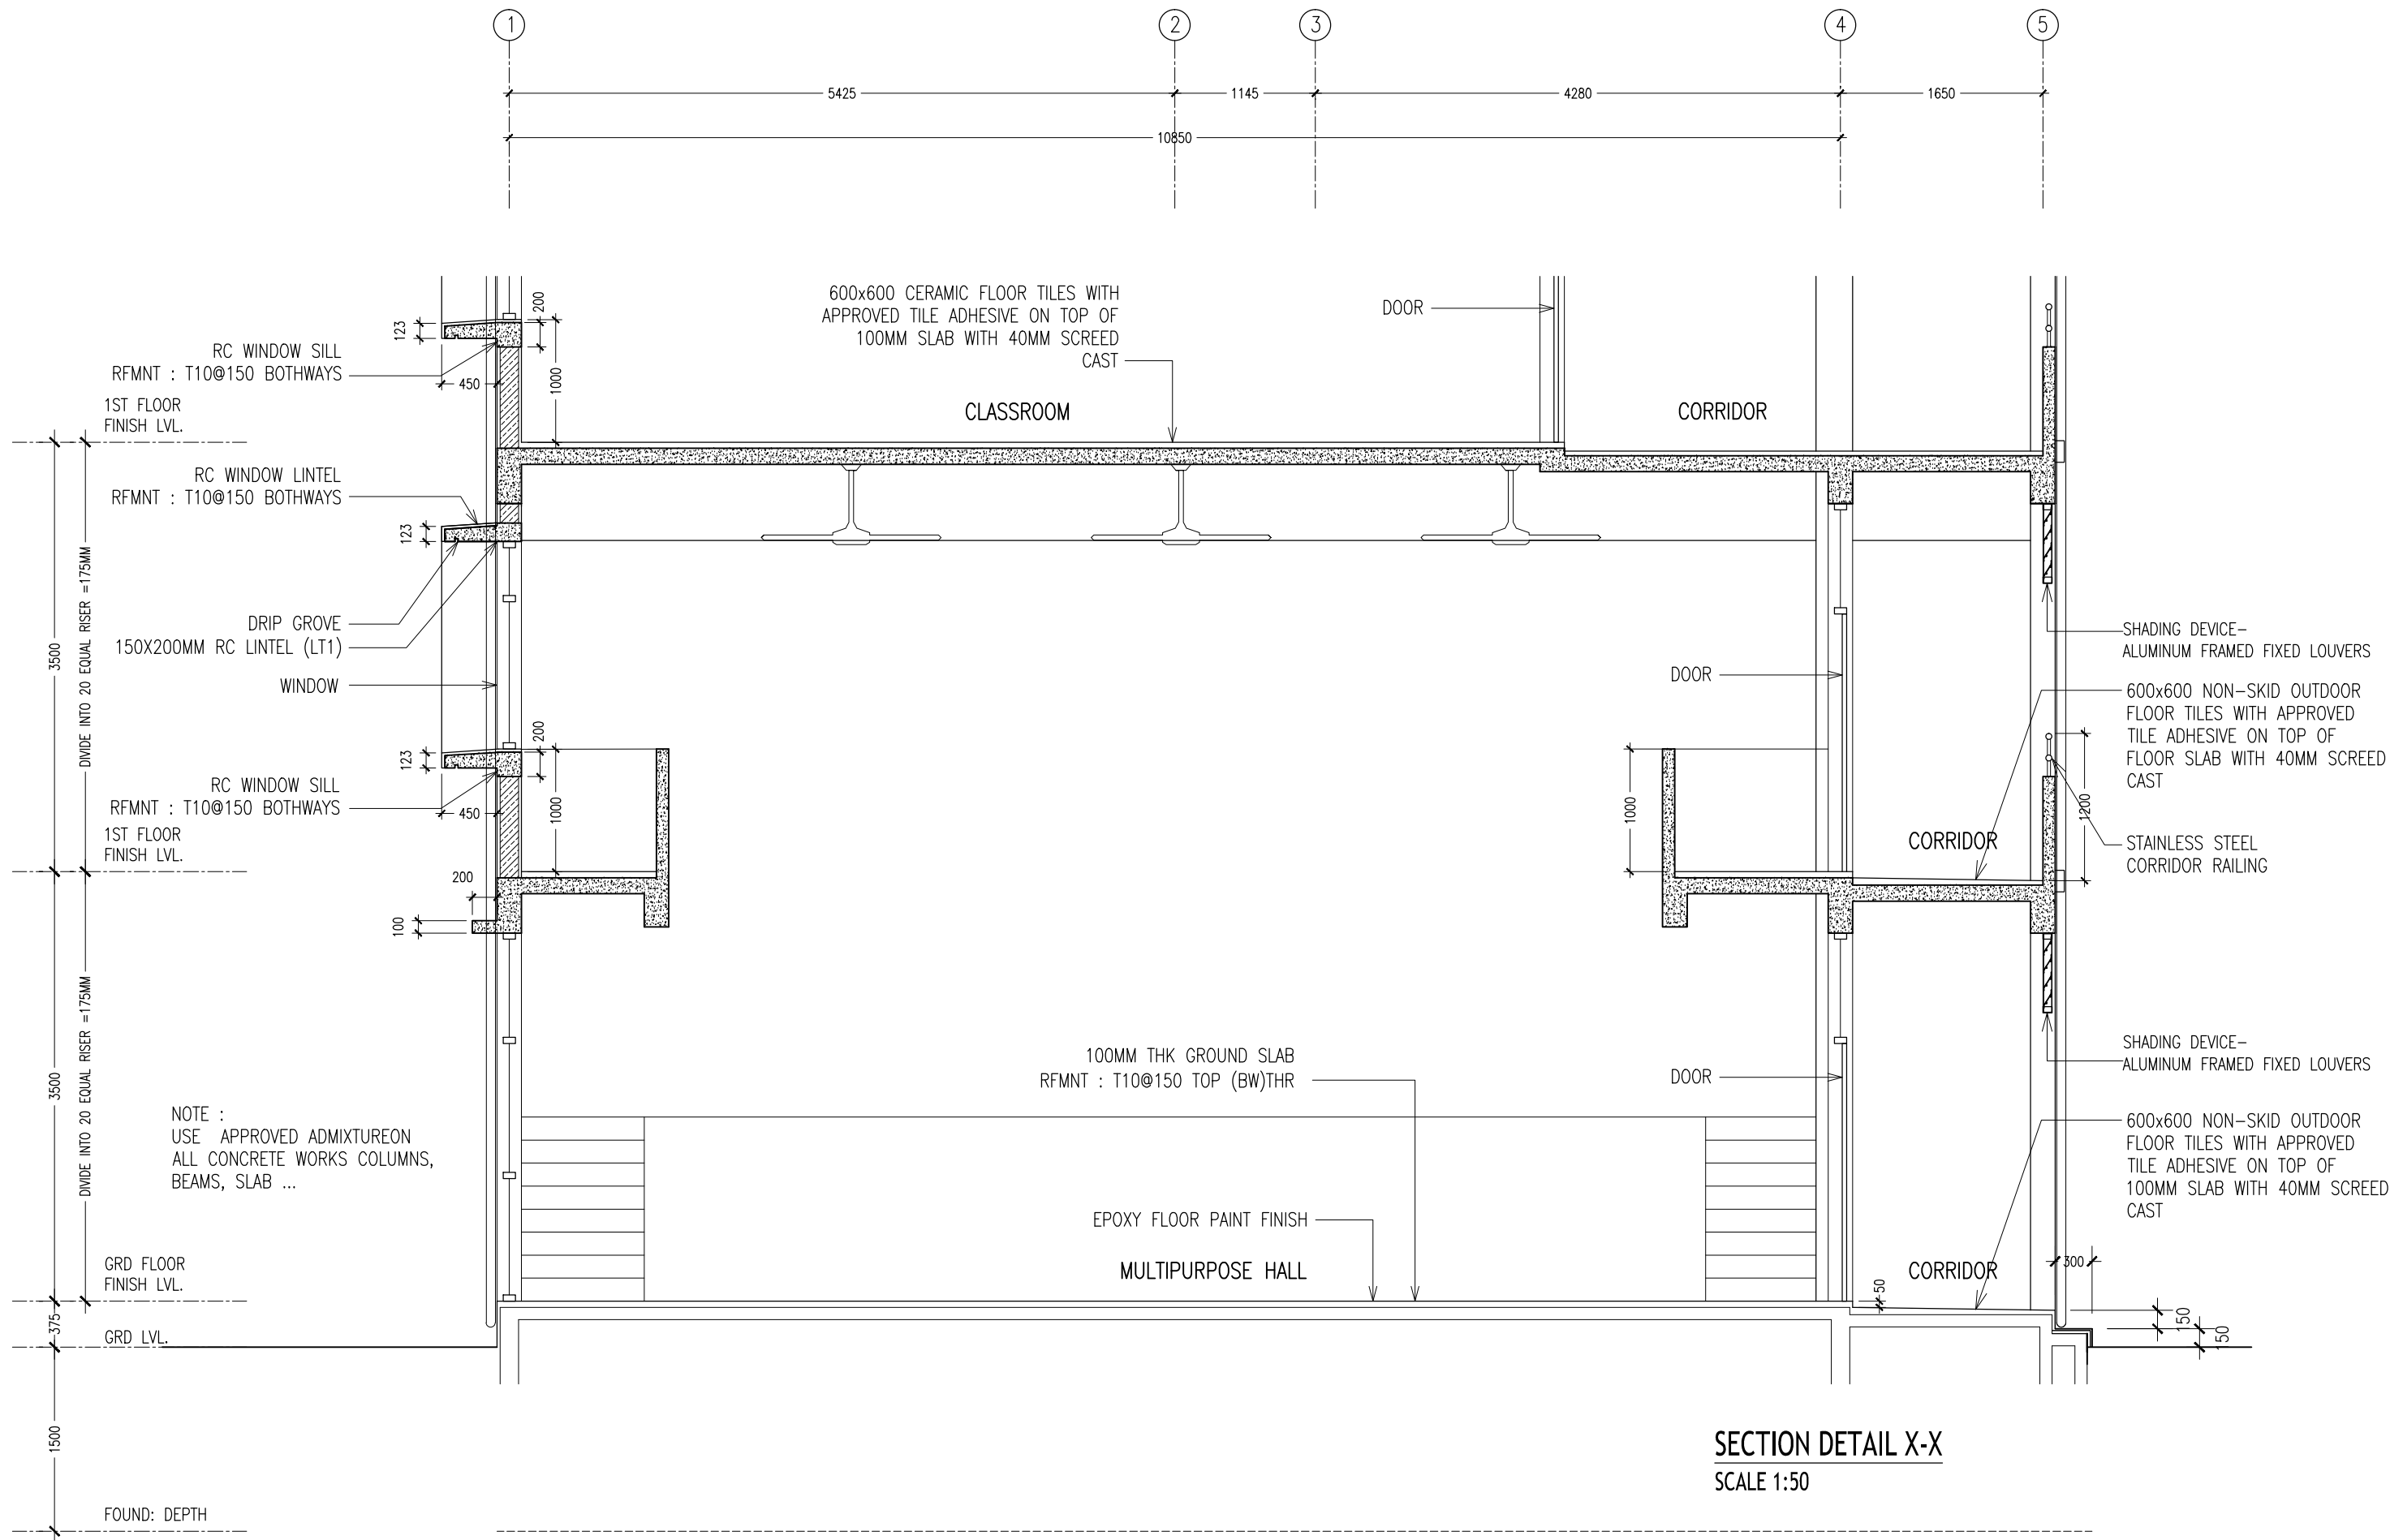**A-08**

DWG NO

PROJECT NO.: 14-124

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studio  
Ma Fiyajahaage, 1st floor, Male', Republic of Maldives  
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**A-09**  
DWG NO  
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ELEVATIONS :						
DR / WD NO.	D1	D2	D3	D4	D5	W1
DESCRIPTION :	ALUMINUM FRAMED OPENABLE DOOR PANEL	ALUMINUM FRAMED OPENABLE DOOR PANEL	40MM THICK OPENABLE SOLID TIMBER DOOR PANEL	40MM THICK OPENABLE ALUMINIUM DOOR PANEL	40MM THICK OPENABLE ALUMINIUM DOOR PANEL	ALUMINUM FRAMED SLIDING WINDOW PANEL WITH FIXED ALUMINUM LOUVERS
FRAME :	40 MICRON WHITE POWDER COATED ALUMINIUM FRAME	40 MICRON WHITE POWDER COATED ALUMINIUM FRAME	120MM TIMBER FRAME	40 MICRON WHITE POWDER COATED ALUMINIUM FRAME	40 MICRON WHITE POWDER COATED ALUMINIUM FRAME	40 MICRON WHITE POWDER COATED ALUMINIUM FRAME
HARDWARE :	DOOR CLOSER CYLINDRICAL LOCK BUTT HINGE STOPPER HOLDER	DOOR CLOSER CYLINDRICAL LOCK BUTT HINGE STOPPER HOLDER	DOOR CLOSER CYLINDRICAL LOCK BUTT HINGE STOPPER HOLDER	DOOR CLOSER CYLINDRICAL LOCK BUTT HINGE STOPPER HOLDER	DOOR CLOSER CYLINDRICAL LOCK BUTT HINGE STOPPER HOLDER	
GLAZING :	6MM THICK CLEAR GLASS	6MM THICK CLEAR GLASS	C-4MM	C-4MM	C-4MM	6MM THICK CLEAR GLASS

ELEVATIONS :				
DR / WD NO.	W2	W3	W4	SHADING DEVICE ( TYPICAL )
DESCRIPTION :	ALUMINUM FRAMED SLIDING WINDOW PANEL	ALUMINUM FRAMED WINDOW PANEL	ALUMINUM FRAMED FIXED WINDOW PANEL WITH FIXED ALUMINUM LOUVERS	ALUMINUM FRAMED FIXED LOUVERS
FRAME :	40 MICRON WHITE POWDER COATED ALUMINIUM FRAME	40 MICRON WHITE POWDER COATED ALUMINIUM FRAME	40 MICRON WHITE POWDER COATED ALUMINIUM FRAME	40 MICRON WHITE POWDER COATED ALUMINIUM FRAME
HARDWARE :				
GLAZING :	6MM THICK CLEAR GLASS	6MM THICK CLEAR GLASS		

GENERAL NOTES:

SHOP DRAWINGS FOR ALL DOORS AND WINDOWS SHALL BE PROVIDED SHOWING LOCATION AND TYPE OF IRONMONGERIES

ALL DIMENSIONS TO BE CHECKED ON SITE PRIOR TO FABRICATION

ALL TIMBER FOR WOODEN DOORS SHALL BE TREATED FOR THE USE IN INDOORS.

FG : FIXED GLASS  
FTL : FIXED TIMBER LOUVERS  
FAL : FIXED ALUMINUM LOUVERS

DOOR / WINDOW SCHEDULE

SCALE 1:50

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Ha Fiyajahaage, 1st floor, Male, Republic of Maldives  
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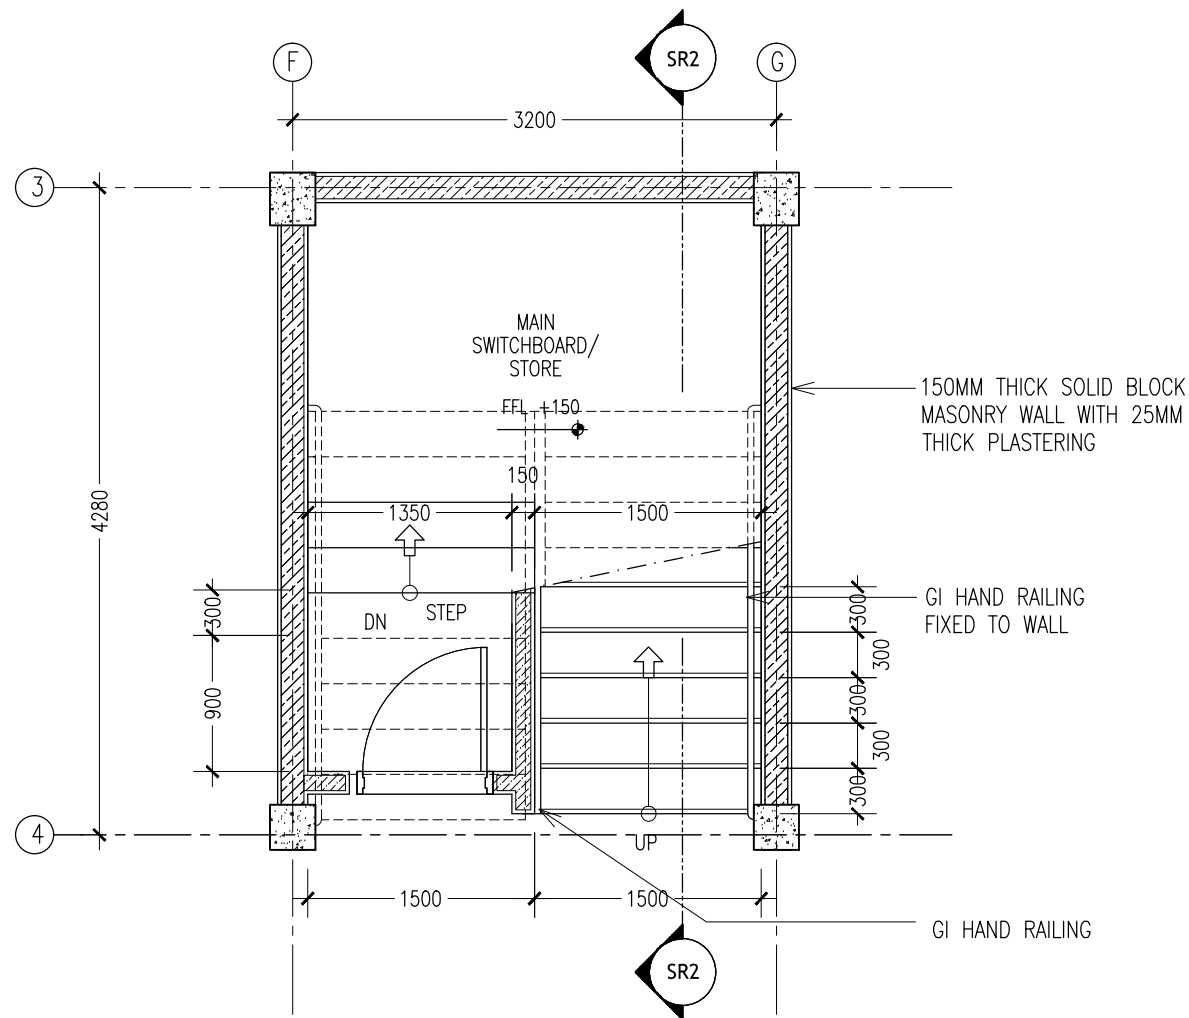
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SCALE: AS GIVEN DIMENSION: MM DATE: AUJULY 2015


DWG NO  
PROJECT NO.: 14-124

A-10



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GROUND FLOOR STAIR PLAN  
SCALE 1:50



1ST-2ND FLOOR STAIR PLAN  
SCALE 1:50

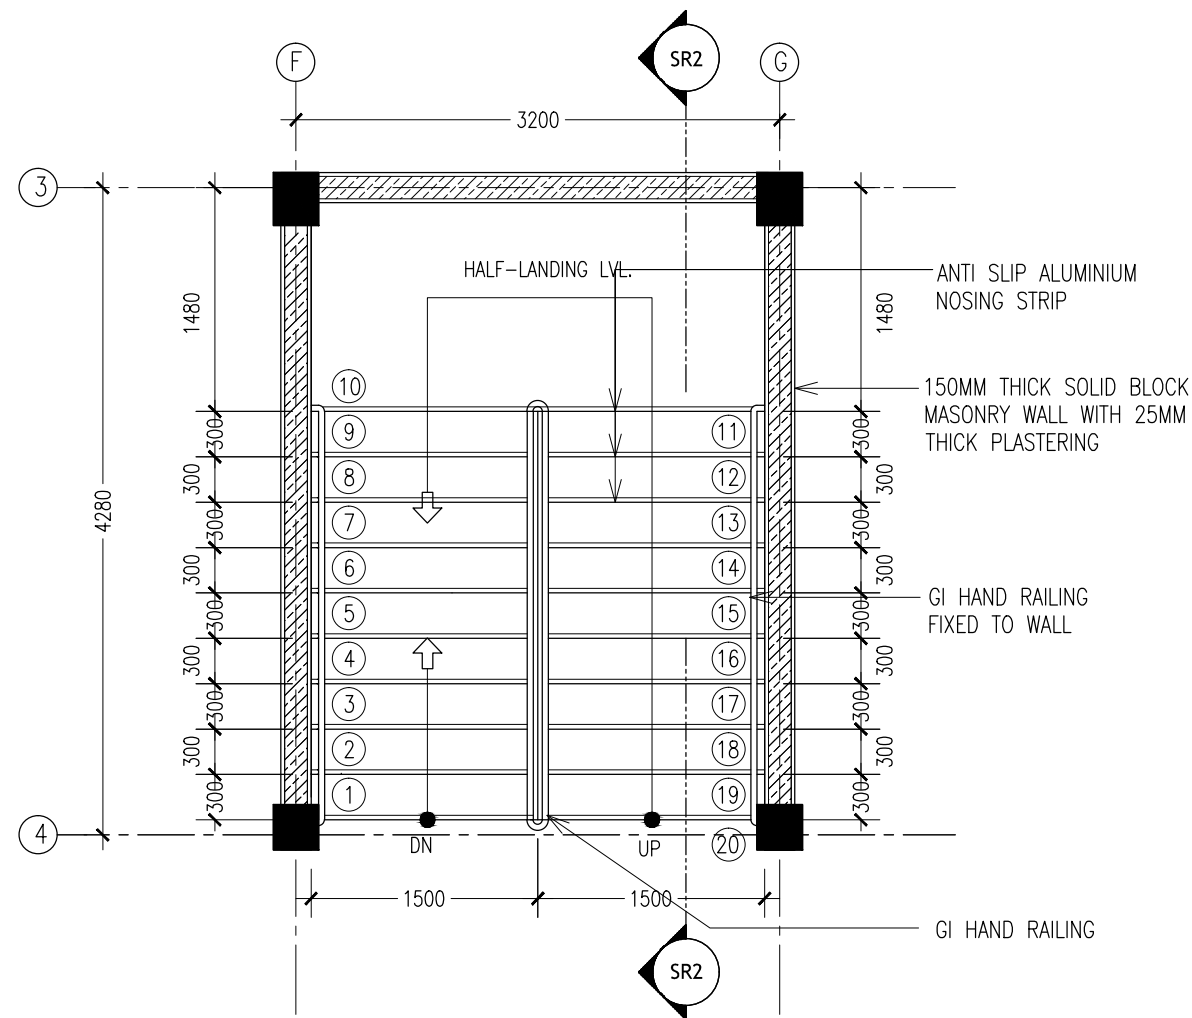

RC FIN FRONT ELEVATION  
SCALE 1:50
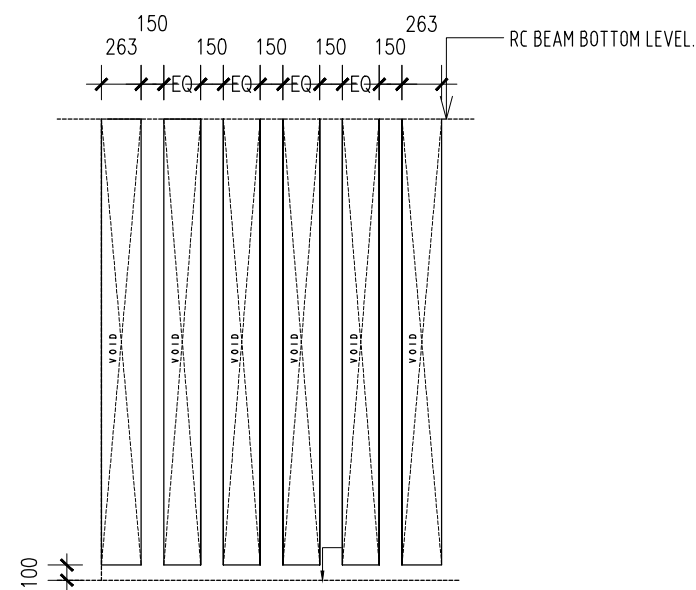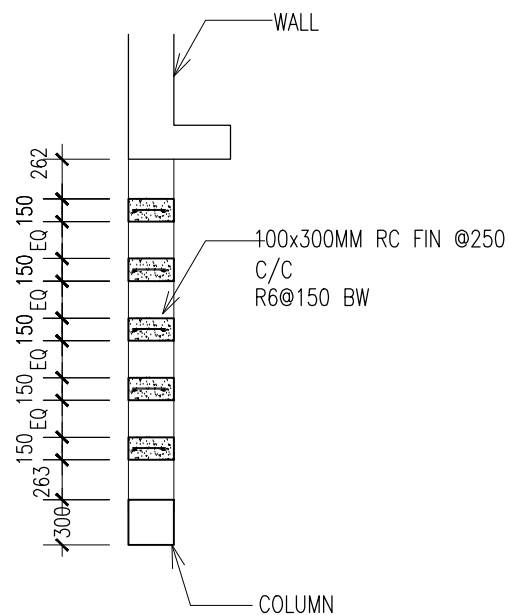
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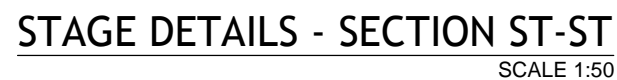
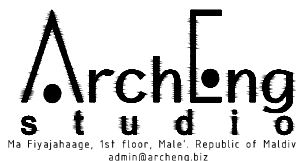
**ArchEng**  
studio  
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REVISION:	ARCHITECT: MOHAMED HAMEEN	PROJECT: 6 CLASSROOM BLOCK, MULTI PURPOSE HALL BLOCK IN MEYNAA SCHOOL	A-11
	ENGINEER: MOHAMED AHSAN	LOCATION: HA.HOLHUDHOO	
	SERVICES ENG:	DRAWING TITLE: AS GIVEN	
	ESTIMATOR:	CLIENT: MINISTRY OF EDUCATION	
	DRAWN BY:	SCALE: AS GIVEN      DIMENSION: MM      DATE: AUJULY 2015	
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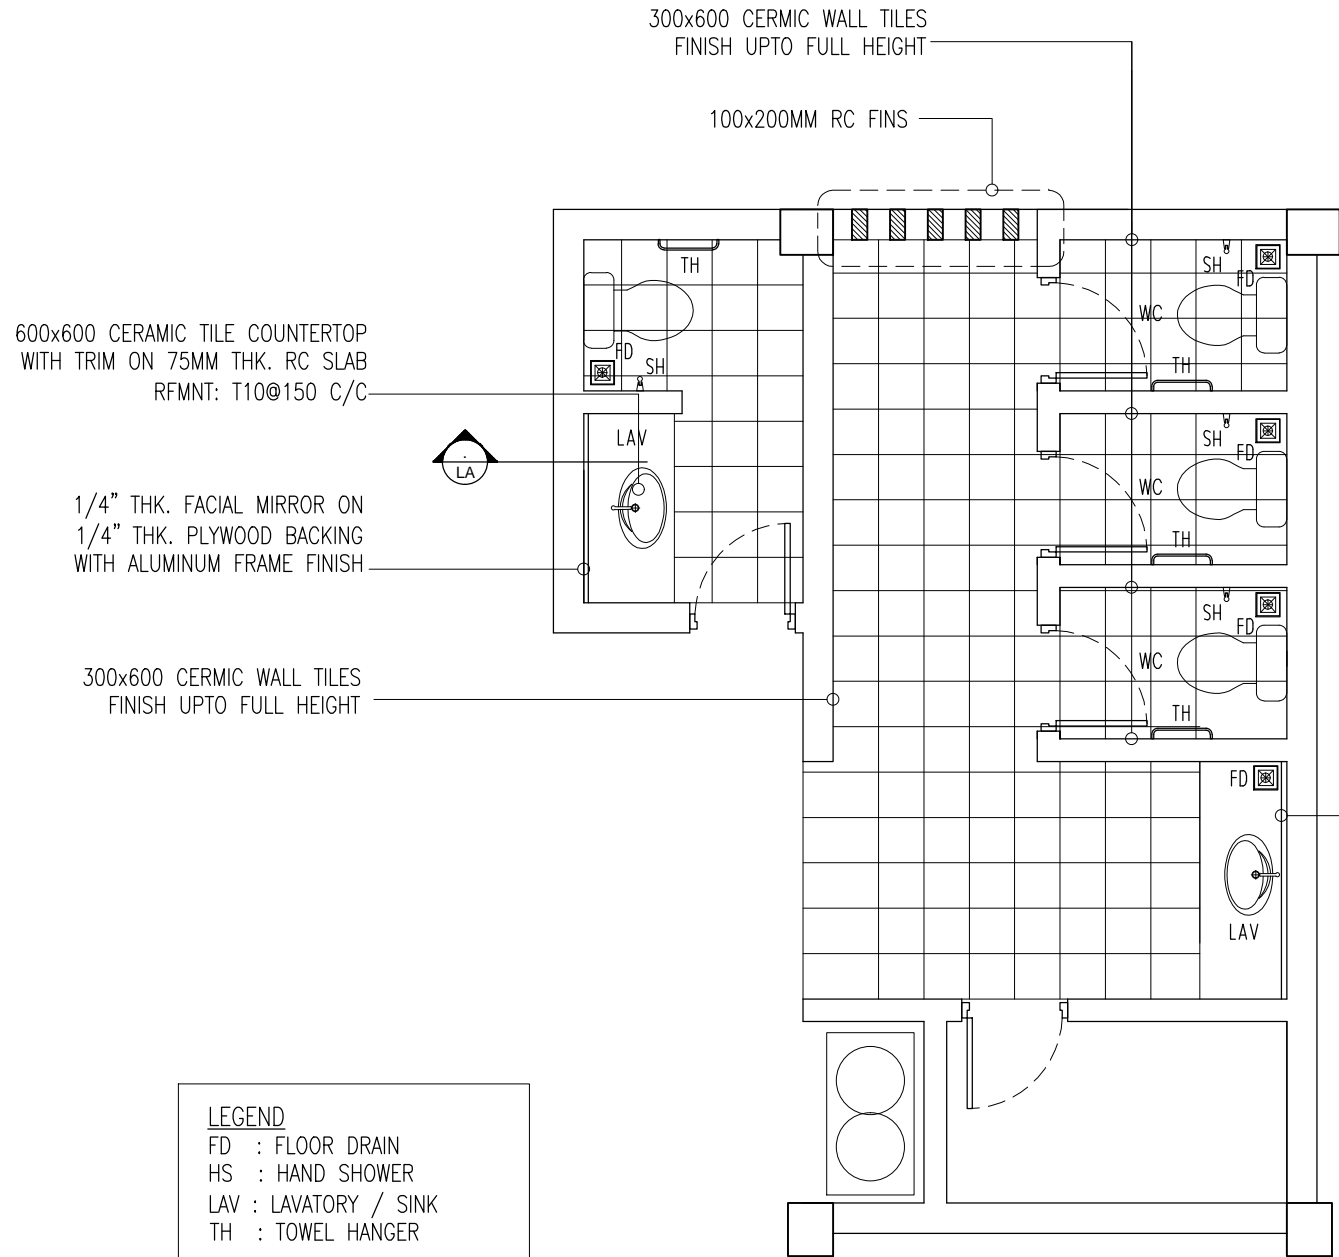


REVISION:	ARCHITECT: MOHAMED HAMEEN	PROJECT: 6 CLASSROOM BLOCK, MULTI PURPOSE HALL BLOCK IN MEYNAA SCHOOL	<div style="font-size: 48px; font-weight: bold; text-align: center;">A-12</div> <div style="text-align: center;">DWG NO</div> <div style="text-align: center;">PROJECT NO.: 14-124</div>
	ENGINEER: MOHAMED AHSAN	LOCATION: HA: HOLHUDDOO	
	SERVICES ENG:	DRAWING TITLE: AS GIVEN	
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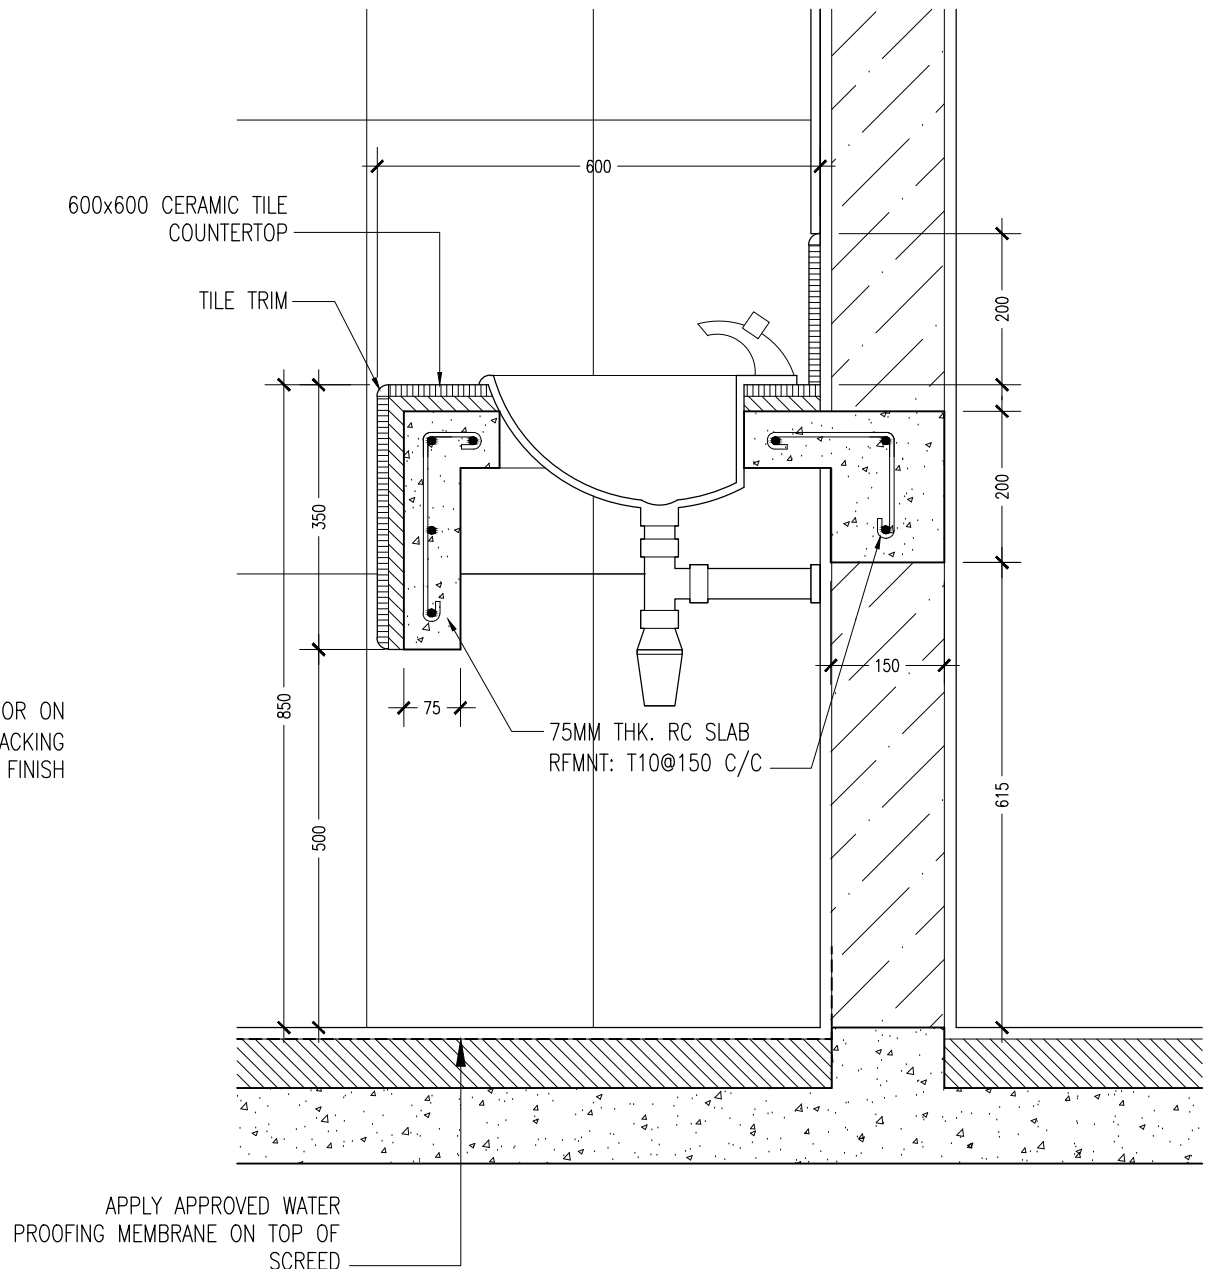
A-12

DWG NO

PROJECT NO: 14-134



**TOILET BLOCK -1 ( TYPICAL ) 1ST AND 2ND  
FLOOR**  
SCALE 1:50




**SECTION DETAILS LA**  
SCALE 1:10

NOTE :  
ALL TOILETS FLOOR TO BE WATER PROOF BY  
APPROVED WATER PROOFING

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	ENGINEER: MOHAMED AHSAN	LOCATION: HA, HOLHUDHOO	
	SERVICES ENG:	DRAWING TITLE: AS GIVEN	
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TYPICAL BALCONY PARAPET WALL  
SCALE 1:20

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LOCATION: HA, HOLHUDHOO

DRAWING TITLE: AS GIVEN

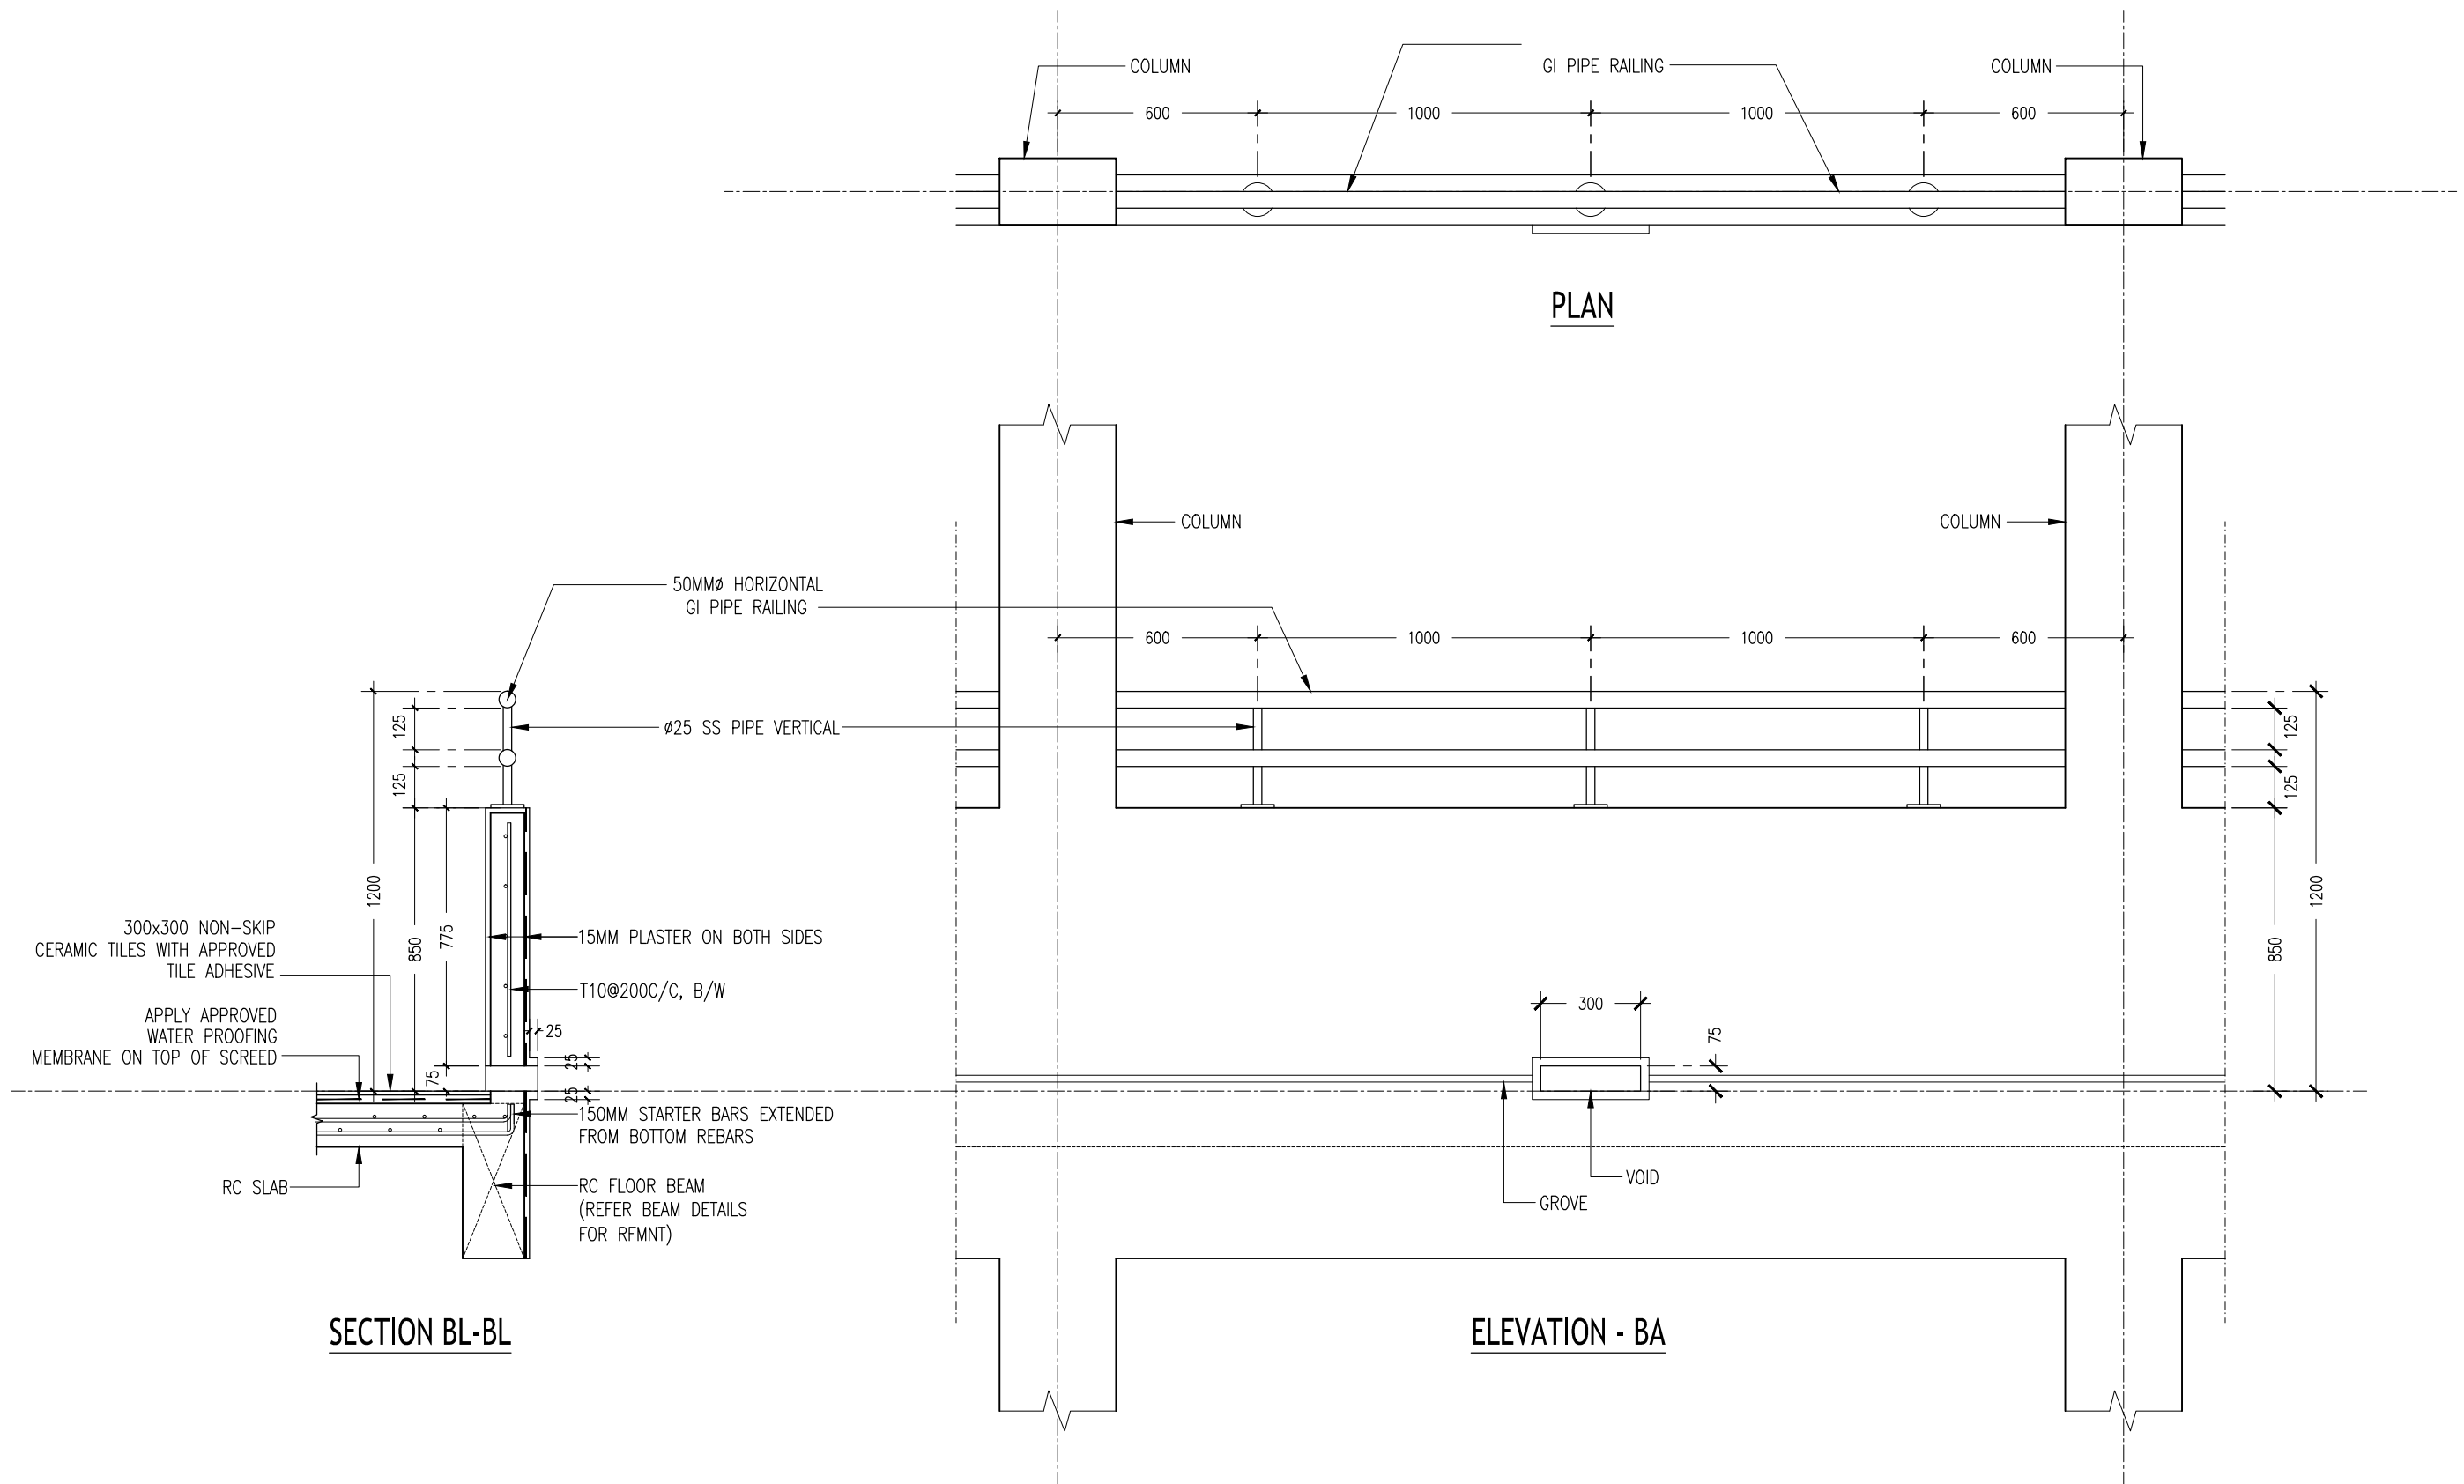CLIENT: MINISTRY OF EDUCATION

SCALE: AS GIVEN

DIMENSION: MM

DATE: AUJUGST 2015


A-14

DWG NO

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COLUMN SETTING PLAN  
SCALE 1:100

CONTRACTORS MUST  
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DIMENSIONS ON SITE  
BEFORE STARTING  
ANY WORK OR SHOP  
DRAWINGS, FIGURED  
DIMENSIONS TO TAKE  
PRECEDENCE OVER  
SCALE READINGS

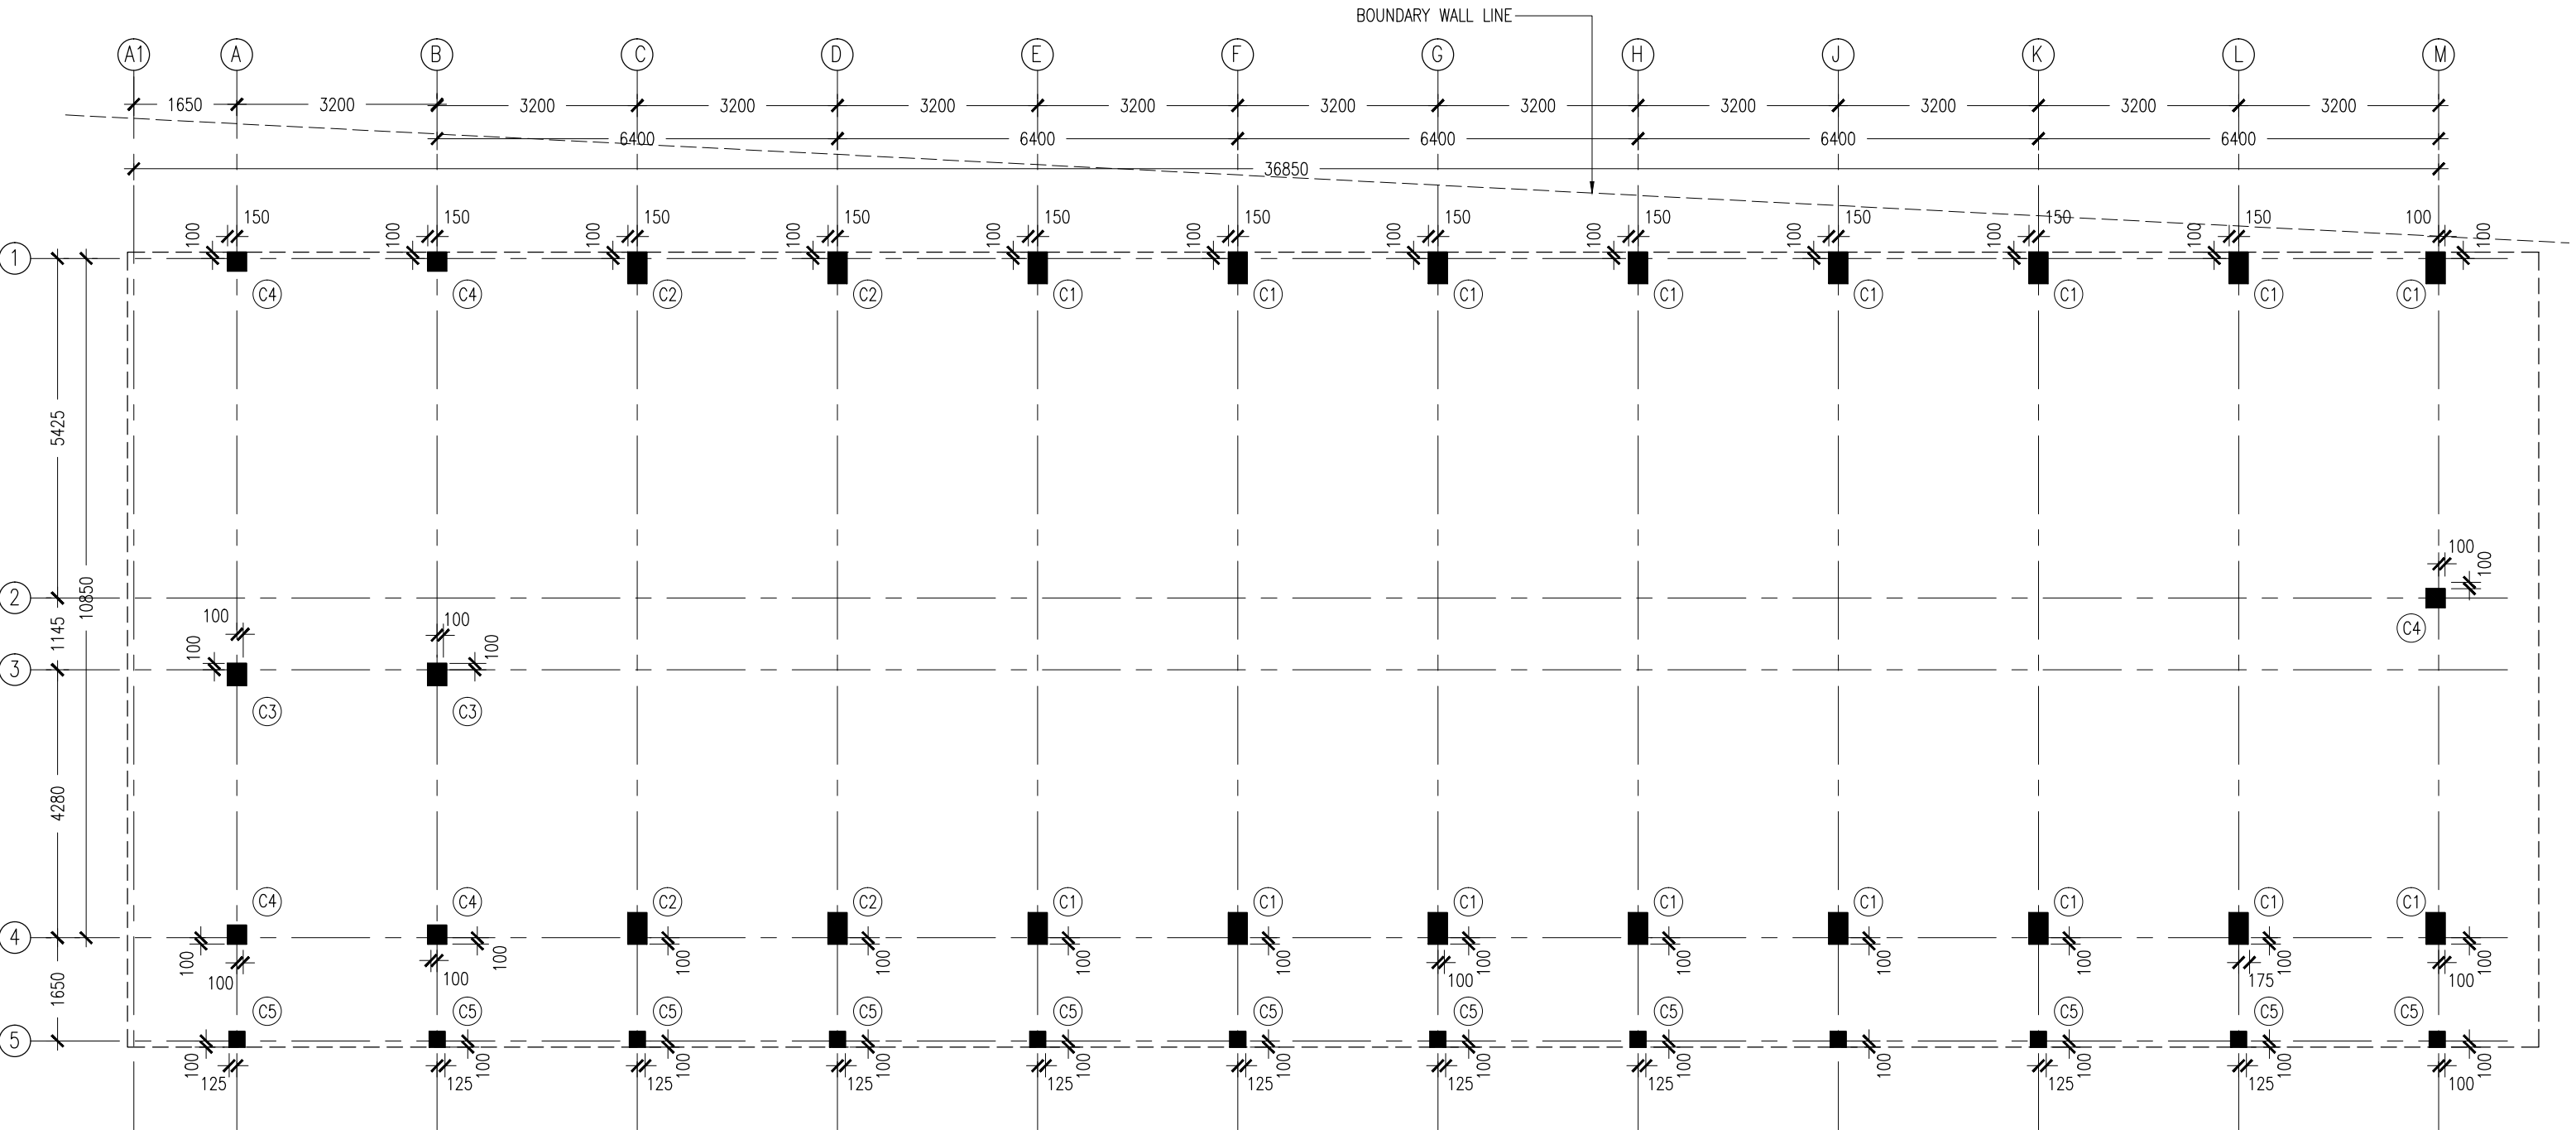


REVISION:	ARCHITECT: MOHAMED HAMEEN	PROJECT: 6 CLASSROOM BLOCK, MULTI PURPOSE HALL BLOCK IN MEYNAA SCHOOL	S-01
	ENGINEER: MOHAMED AHSAN	LOCATION: HA, HOLHUDHOO	
	SERVICES ENG:	DRAWING TITLE: AS GIVEN	
	ESTIMATOR:	CLIENT: MINISTRY OF EDUCATION	
	DRAWN BY:	SCALE: AS GIVEN   DIMENSION: MM   DATE: AUJULY 2015	
CONCEPT AND DESIGN IN THIS DRAWING ARE THE PROPERTIES OF ARCHENG STUDIO PVT LTD. UNAUTHORIZED USE OR REPRODUCTION OF PART OF THE DESIGN, DRAWINGS OR CONCEPT TO USE IN OTHER PROJECTS OR SITES OTHER THAN SPECIFIED ON THIS DRAWING IS PROHIBITED			DWG NO PROJECT NO.: 14-124



PROJECT NO.: 14-124

CONCEPT AND DESIGN IN THIS DRAWING ARE THE PROPERTIES OF ARCHENG STUDIO PVT LTD. UNAUTHORIZED USE OR REPRODUCTION OF PART OF THE DESIGN DRAWINGS OR CONCEPT TO USE IN OTHER PROJECTS OR SITES OTHER THAN SPECIFIED ON THIS DRAWING IS PROHIBITED.

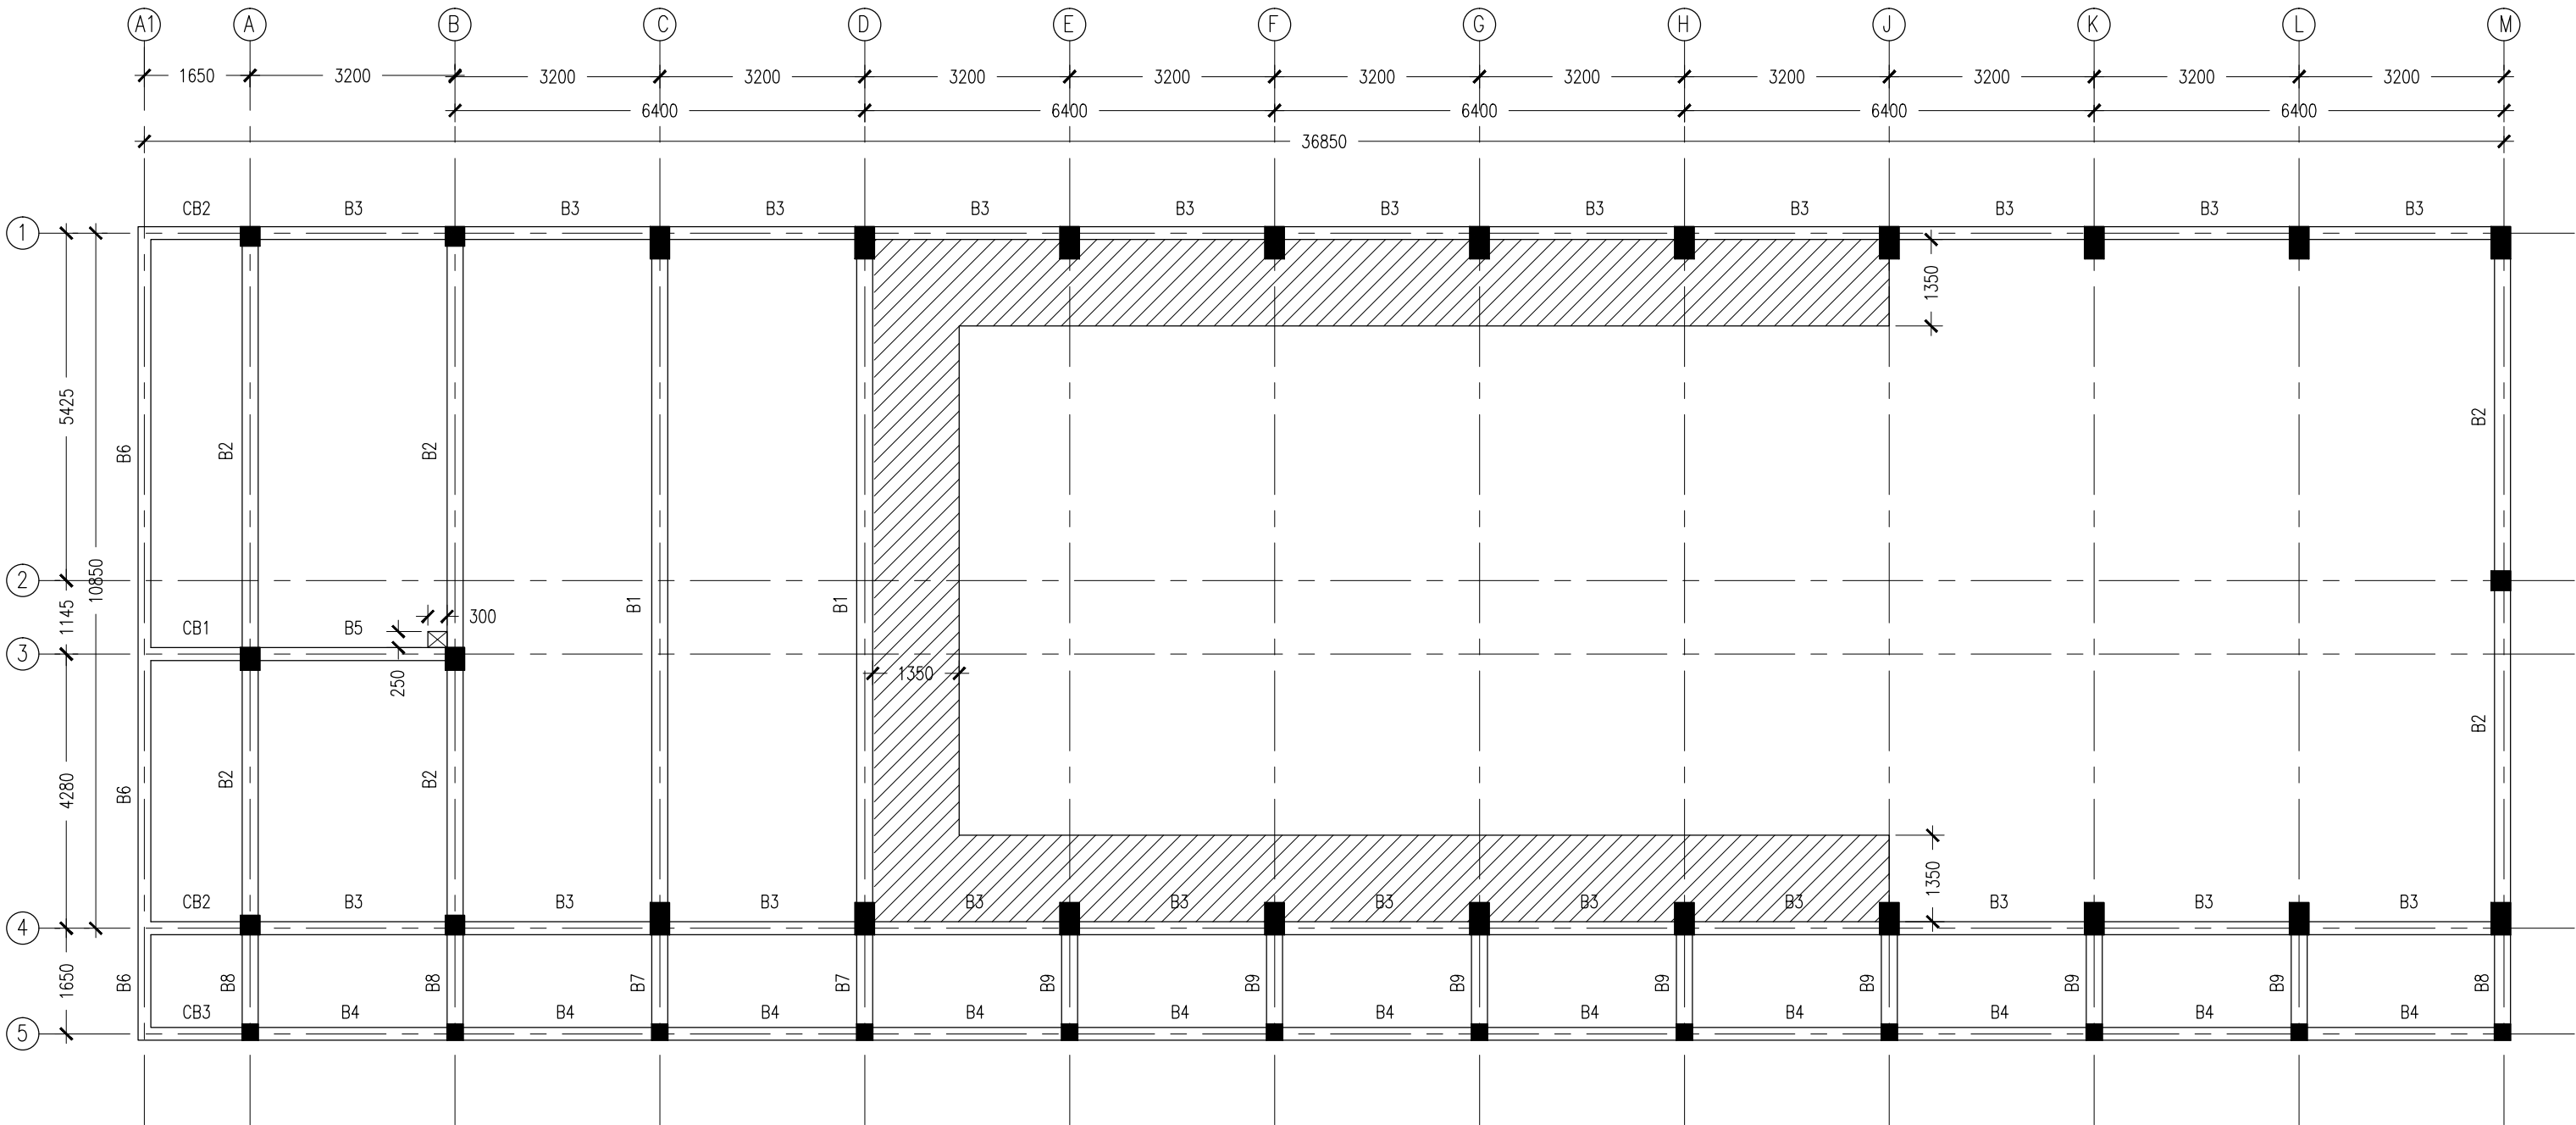

- SLAB THICKNESS : 140MM  
ACCPET WHERE STATED
- SHADED AREA SLAB THICKNESS : 160MM
- SLAB BOTTOM COVER: 30MM
- SLAB TOP COVER: 25MM
- COVER TO BEAMS : 35MM
- COVER TO COLUMNS : 40MM
- CONCRETE MIX : 1:2:3  
UNLESS STATED
- ADD CONMIX MEGAFLW MP TO ALL EXTERNAL PLASTER &  
FOR WET AREA PLASTER
- ADD CONMIX MEGA FLOW P TO ALL SUPER STRUCTURE CONCRETE.

1ST FLOOR BEAM PLAN  
SCALE 1:100

CONTRACTORS MUST  
CHECK ALL  
DIMENSIONS ON SITE  
BEFORE STARTING  
ANY WORK OR SHOP  
DRAWINGS, FIGURED  
DIMENSIONS TO TAKE  
PRECEDENCE OVER  
SCALE READINGS




REVISION:	

ARCHITECT:	MOHAMED HAMEEN
ENGINEER:	MOHAMED AHSAN
SERVICES ENG:	
ESTIMATOR:	
DRAWN BY:	

PROJECT:	6 CLASSROOM BLOCK, MULTI PURPOSE HALL BLOCK IN MEYNAA SCHOOL		
LOCATION:	HA,HOLHUDHOO		
DRAWING TITLE:	AS GIVEN		
CLIENT:	MINISTRY OF EDUCATION		
SCALE:	AS GIVEN	DIMENSION:	MM
		DATE:	AUJJUST 2015

S-03	DWG NO
	PROJECT NO.: 14-124

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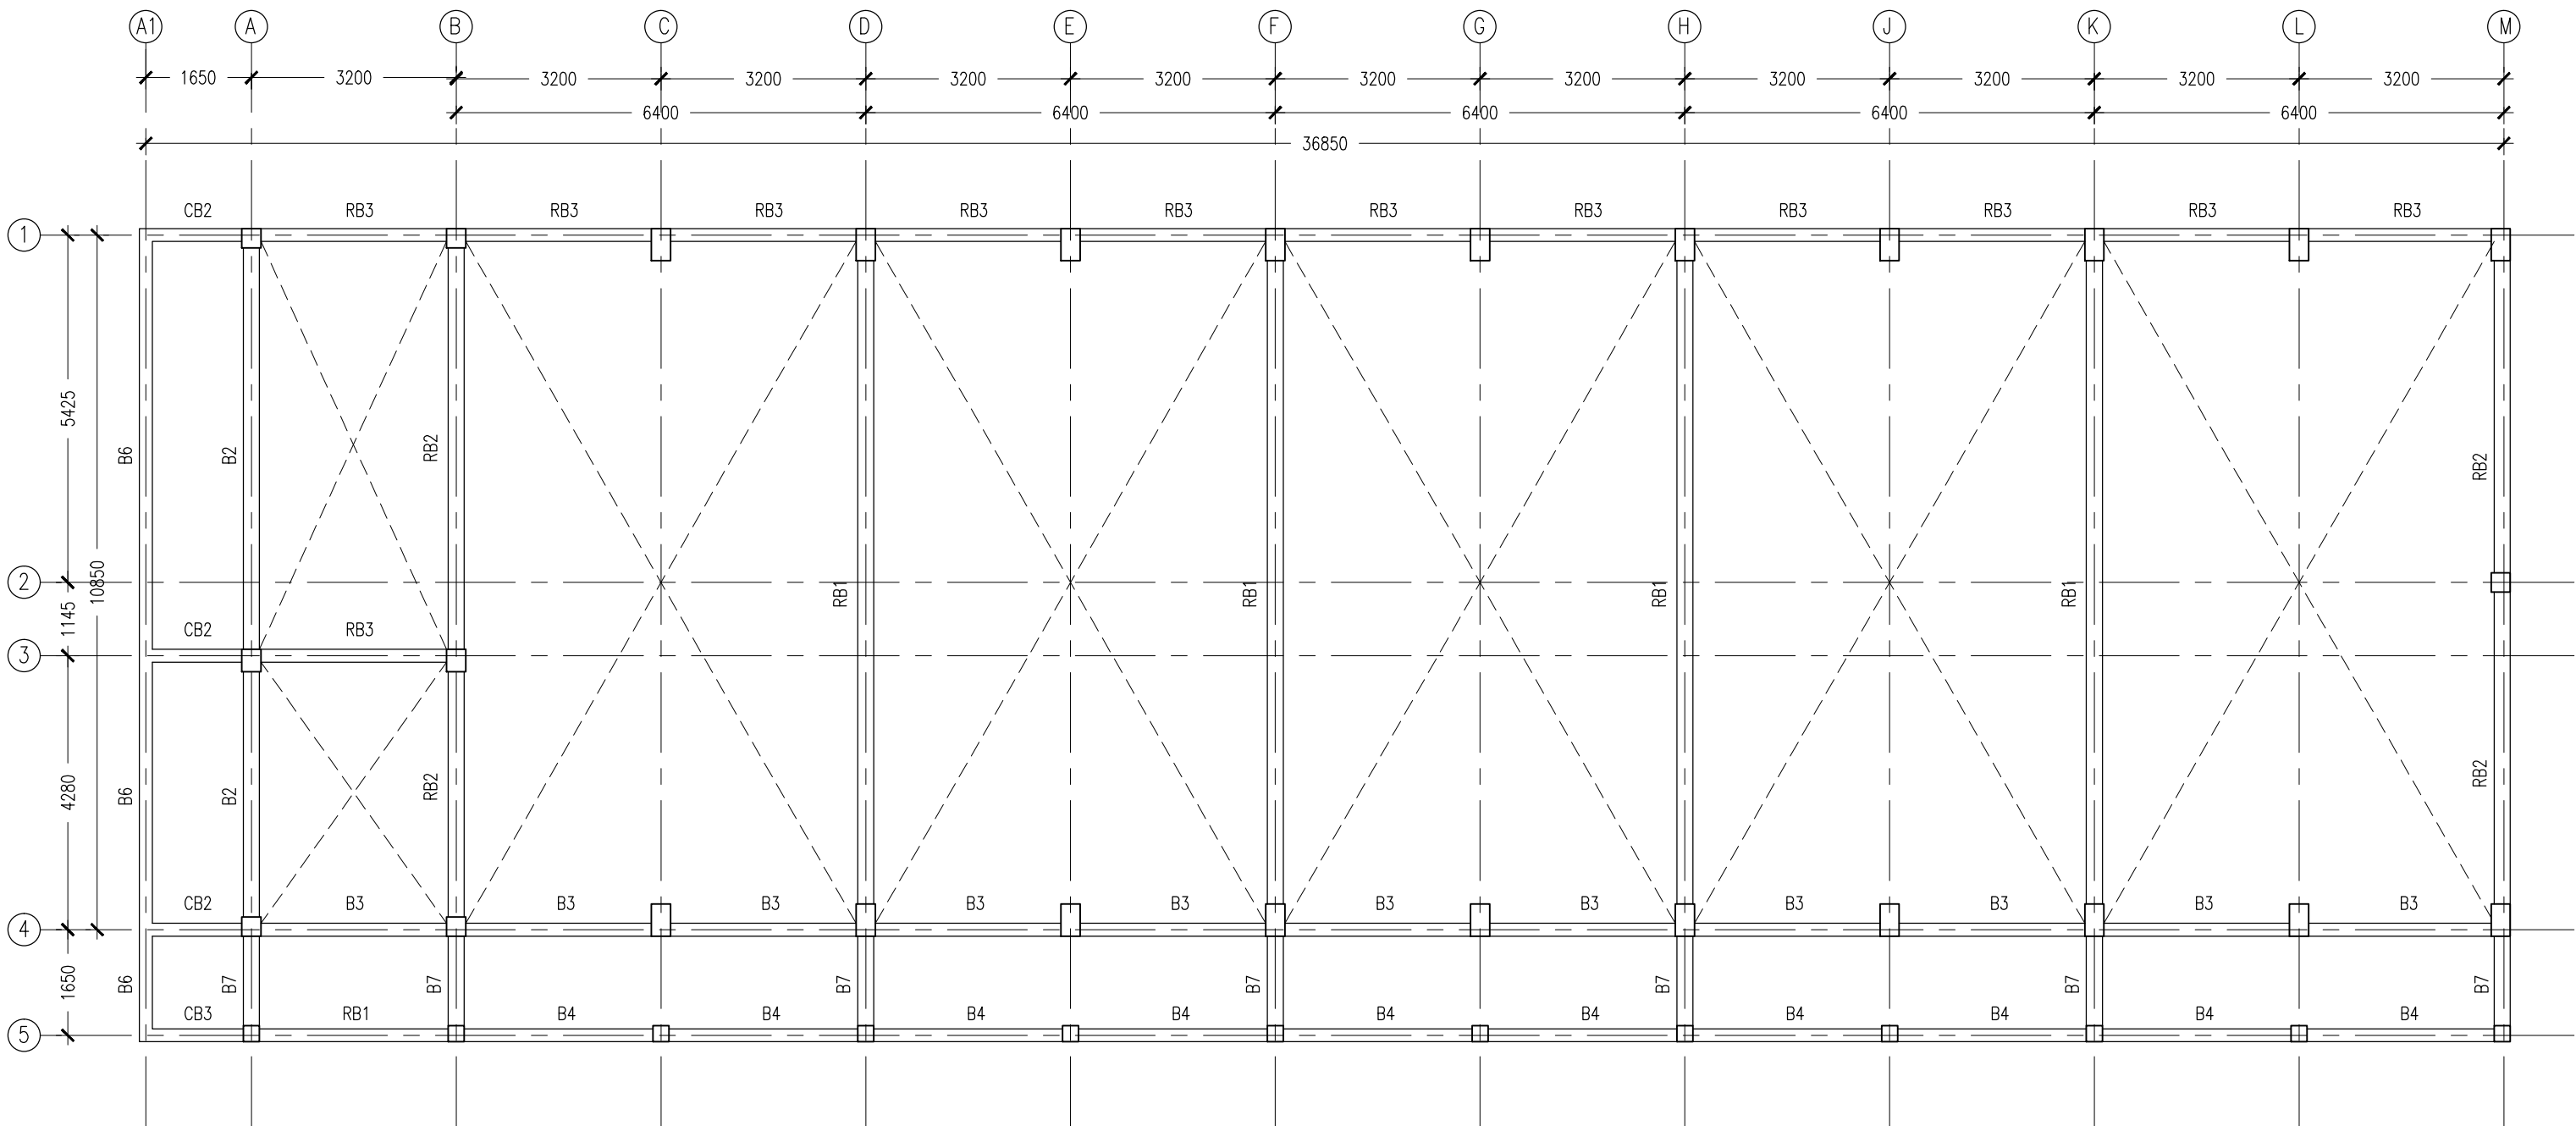
- SLAB THICKNESS : 140MM  
ACCPET WHERE STATED
- SLAB BOTTOM COVER: 30MM
- SLAB TOP COVER: 25MM
- COVER TO BEAMS : 35MM
- COVER TO COLUMNS : 40MM
- CONCRETE MIX : 1:2:3  
UNLESS STATED
- ADD CONMIX MEGAFLW MP TO ALL EXTERNAL PLASTER &  
FOR WET AREA PLASTER
- ADD CONMIX MEGA FLOW P TO ALL SUPER STRUCTURE CONCRETE.

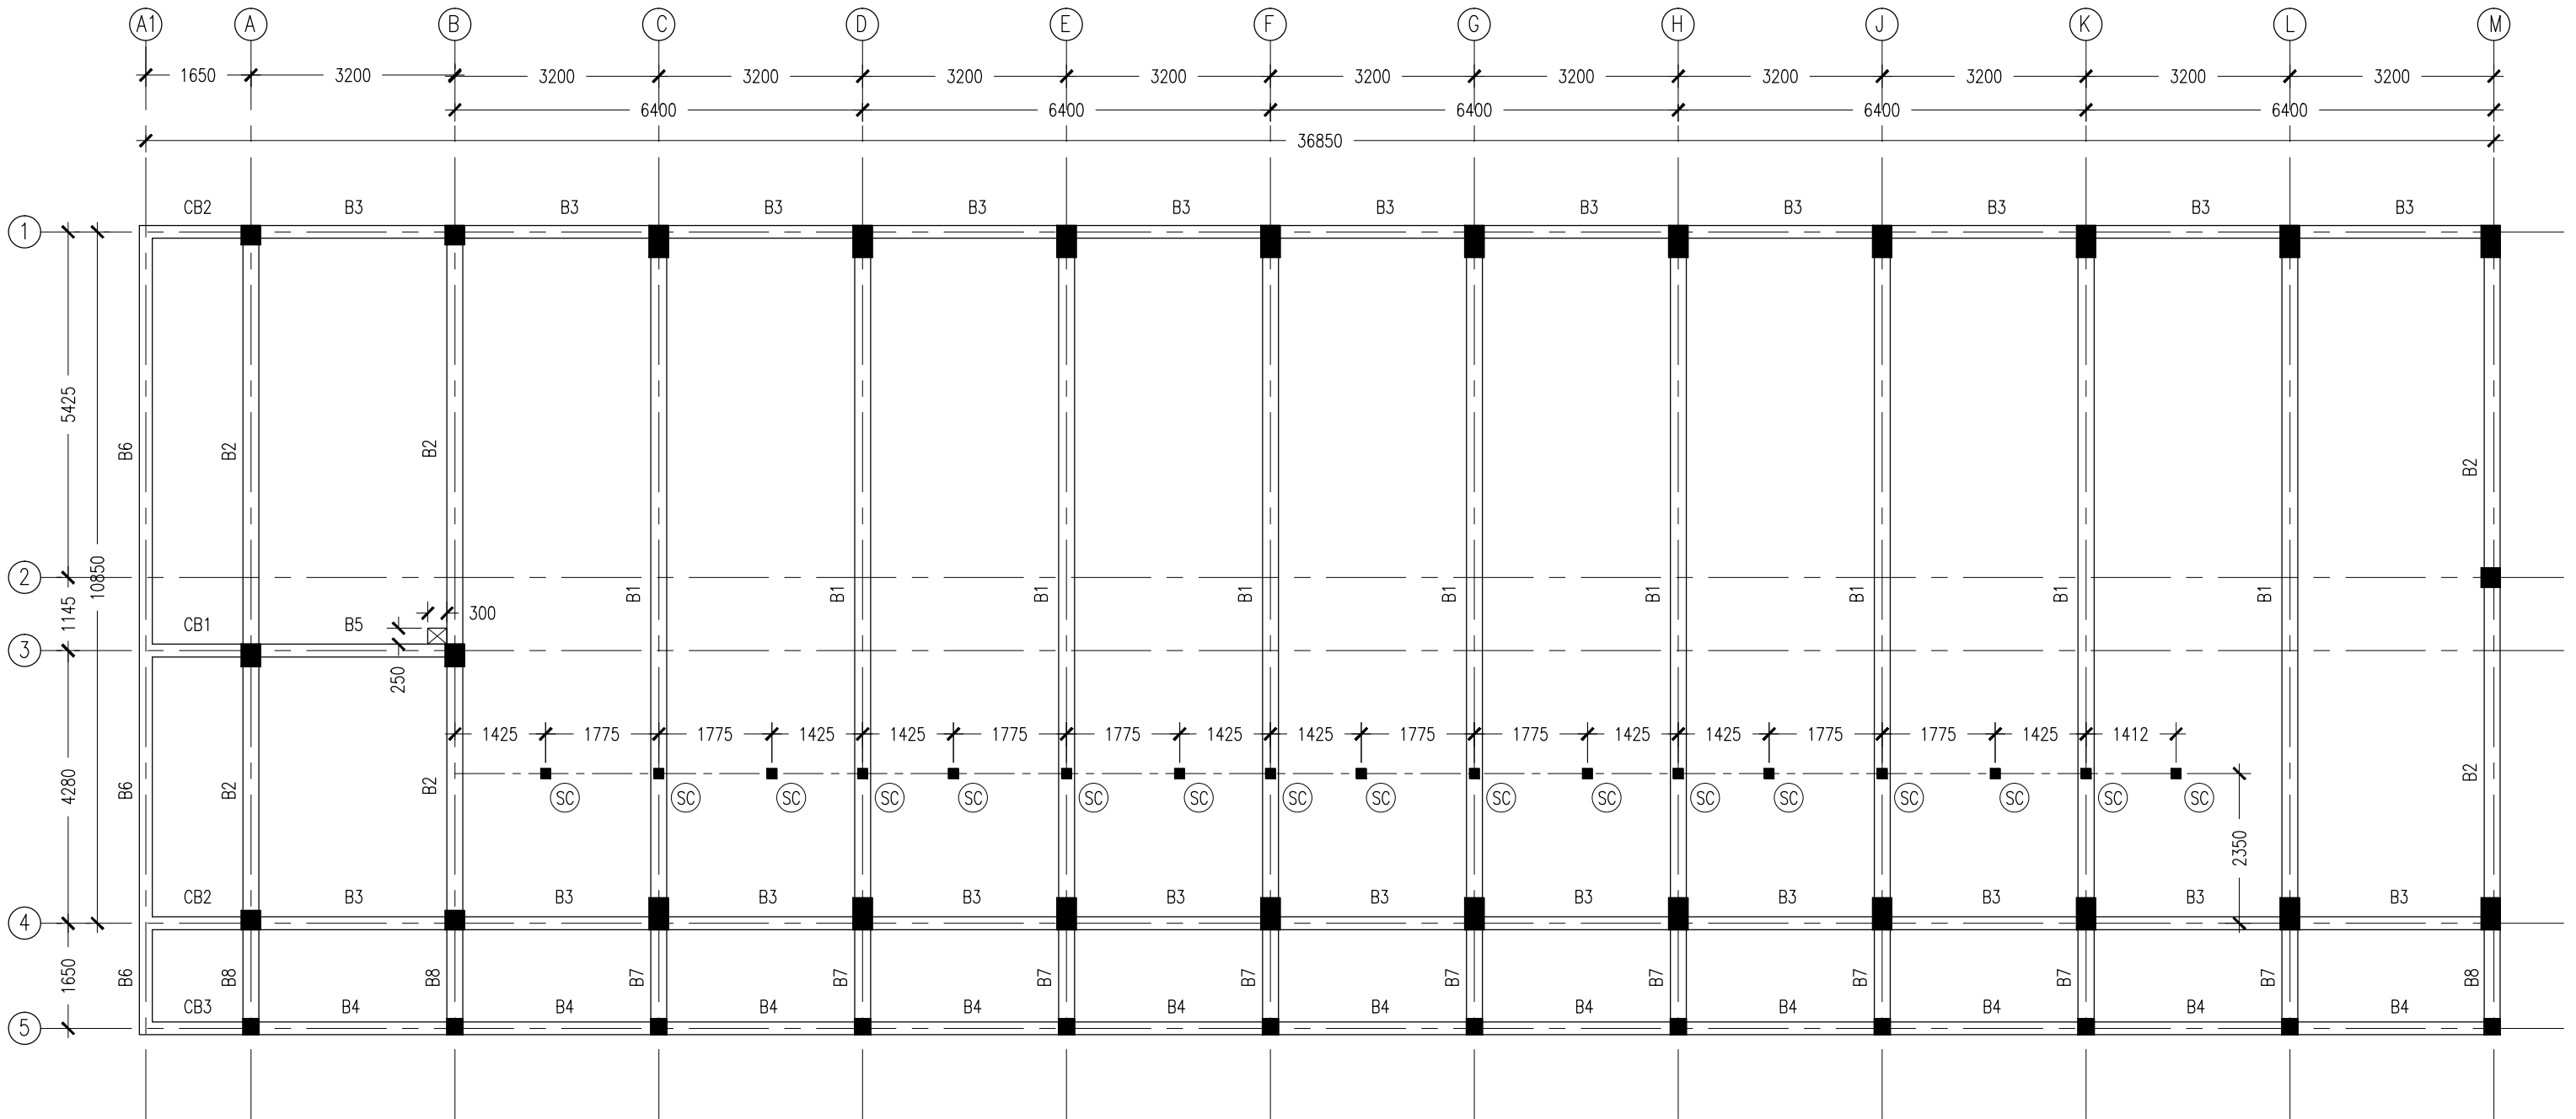2ND FLOOR BEAM PLAN  
SCALE 1:100

CONTRACTORS MUST  
CHECK ALL  
DIMENSIONS ON SITE  
BEFORE STARTING  
ANY WORK OR SHOP  
DRAWINGS, FIGURED  
DIMENSIONS TO TAKE  
PRECEDENCE OVER  
SCALE READINGS



REVISION:	ARCHITECT: MOHAMED HAMEEN	PROJECT: 6 CLASSROOM BLOCK, MULTI PURPOSE HALL BLOCK IN MEYNAA SCHOOL	S-04
	ENGINEER: MOHAMED AHSAN	LOCATION: HA,HOLHUDHOO	
	SERVICES ENG:	DRAWING TITLE: AS GIVEN	
	ESTIMATOR:	CLIENT: MINISTRY OF EDUCATION	
	DRAWN BY:	SCALE: AS GIVEN	
CONCEPT AND DESIGN IN THIS DRAWING ARE THE PROPERTIES OF ARCHENG STUDIO PVT LTD. UNAUTHORIZED USE OR REPRODUCTION OF PART OF THE DESIGN,DRAWINGS OR CONCEPT TO USE IN OTHER PROJECTS OR SITES OTHER THAN SPECIFIED ON THIS DRAWING IS PROHIBITED			DWG NO
			PROJECT NO.: 14-124



- SLAB THICKNESS : 140MM  
ACCPET WHERE STATED
- SLAB BOTTOM COVER: 30MM
- SLAB TOP COVER: 25MM
- COVER TO BEAMS : 35MM
- COVER TO COLUMNS : 40MM
- CONCRETE MIX : 1:2:3  
UNLESS STATED
- ADD CONMIX MEGAFLOW MP TO ALL EXTERNAL PLASTER &  
FOR WET AREA PLASTER
- ADD CONMIX MEGA FLOW P TO ALL SUPER STRUCTURE CONCRETE.

**ROOF BEAM PLAN**  
SCALE 1:100

CONTRACTORS MUST  
CHECK ALL  
DIMENSIONS ON SITE  
BEFORE STARTING  
ANY WORK OR SHOP  
DRAWINGS.FIGURED  
DIMENSIONS TO TAKE  
PRECEDENCE OVER  
SCALE READINGS



REVISION:


ARCHITECT: MOHAMED HAMEEN  
ENGINEER: MOHAMED AHSAN  
SERVICES ENG:  
ESTIMATOR:  
DRAWN BY:

PROJECT: 6 CLASSROOM BLOCK, MULTI PURPOSE HALL BLOCK IN MEYNAA SCHOOL  
LOCATION: HA,HOLHUDHOO  
DRAWING TITLE: AS GIVEN  
CLIENT: MINISTRY OF EDUCATION  
SCALE: AS GIVEN DIMENSION: MM DATE: AUJUST 2015

**S-05**  
DWG NO

PROJECT NO.: 14-124


CONCEPT AND DESIGN IN THIS DRAWING ARE THE PROPERTIES OF ARCHENG STUDIO PVT LTD. UNAUTHORIZED USE OR REPRODUCTION OF PART OF THE DESIGN,DRAWINGS OR CONCEPT TO USE IN OTHER PROJECTS OR SITES OTHER THAN SPECIFIED ON THIS DRAWING IS PROHIBITED

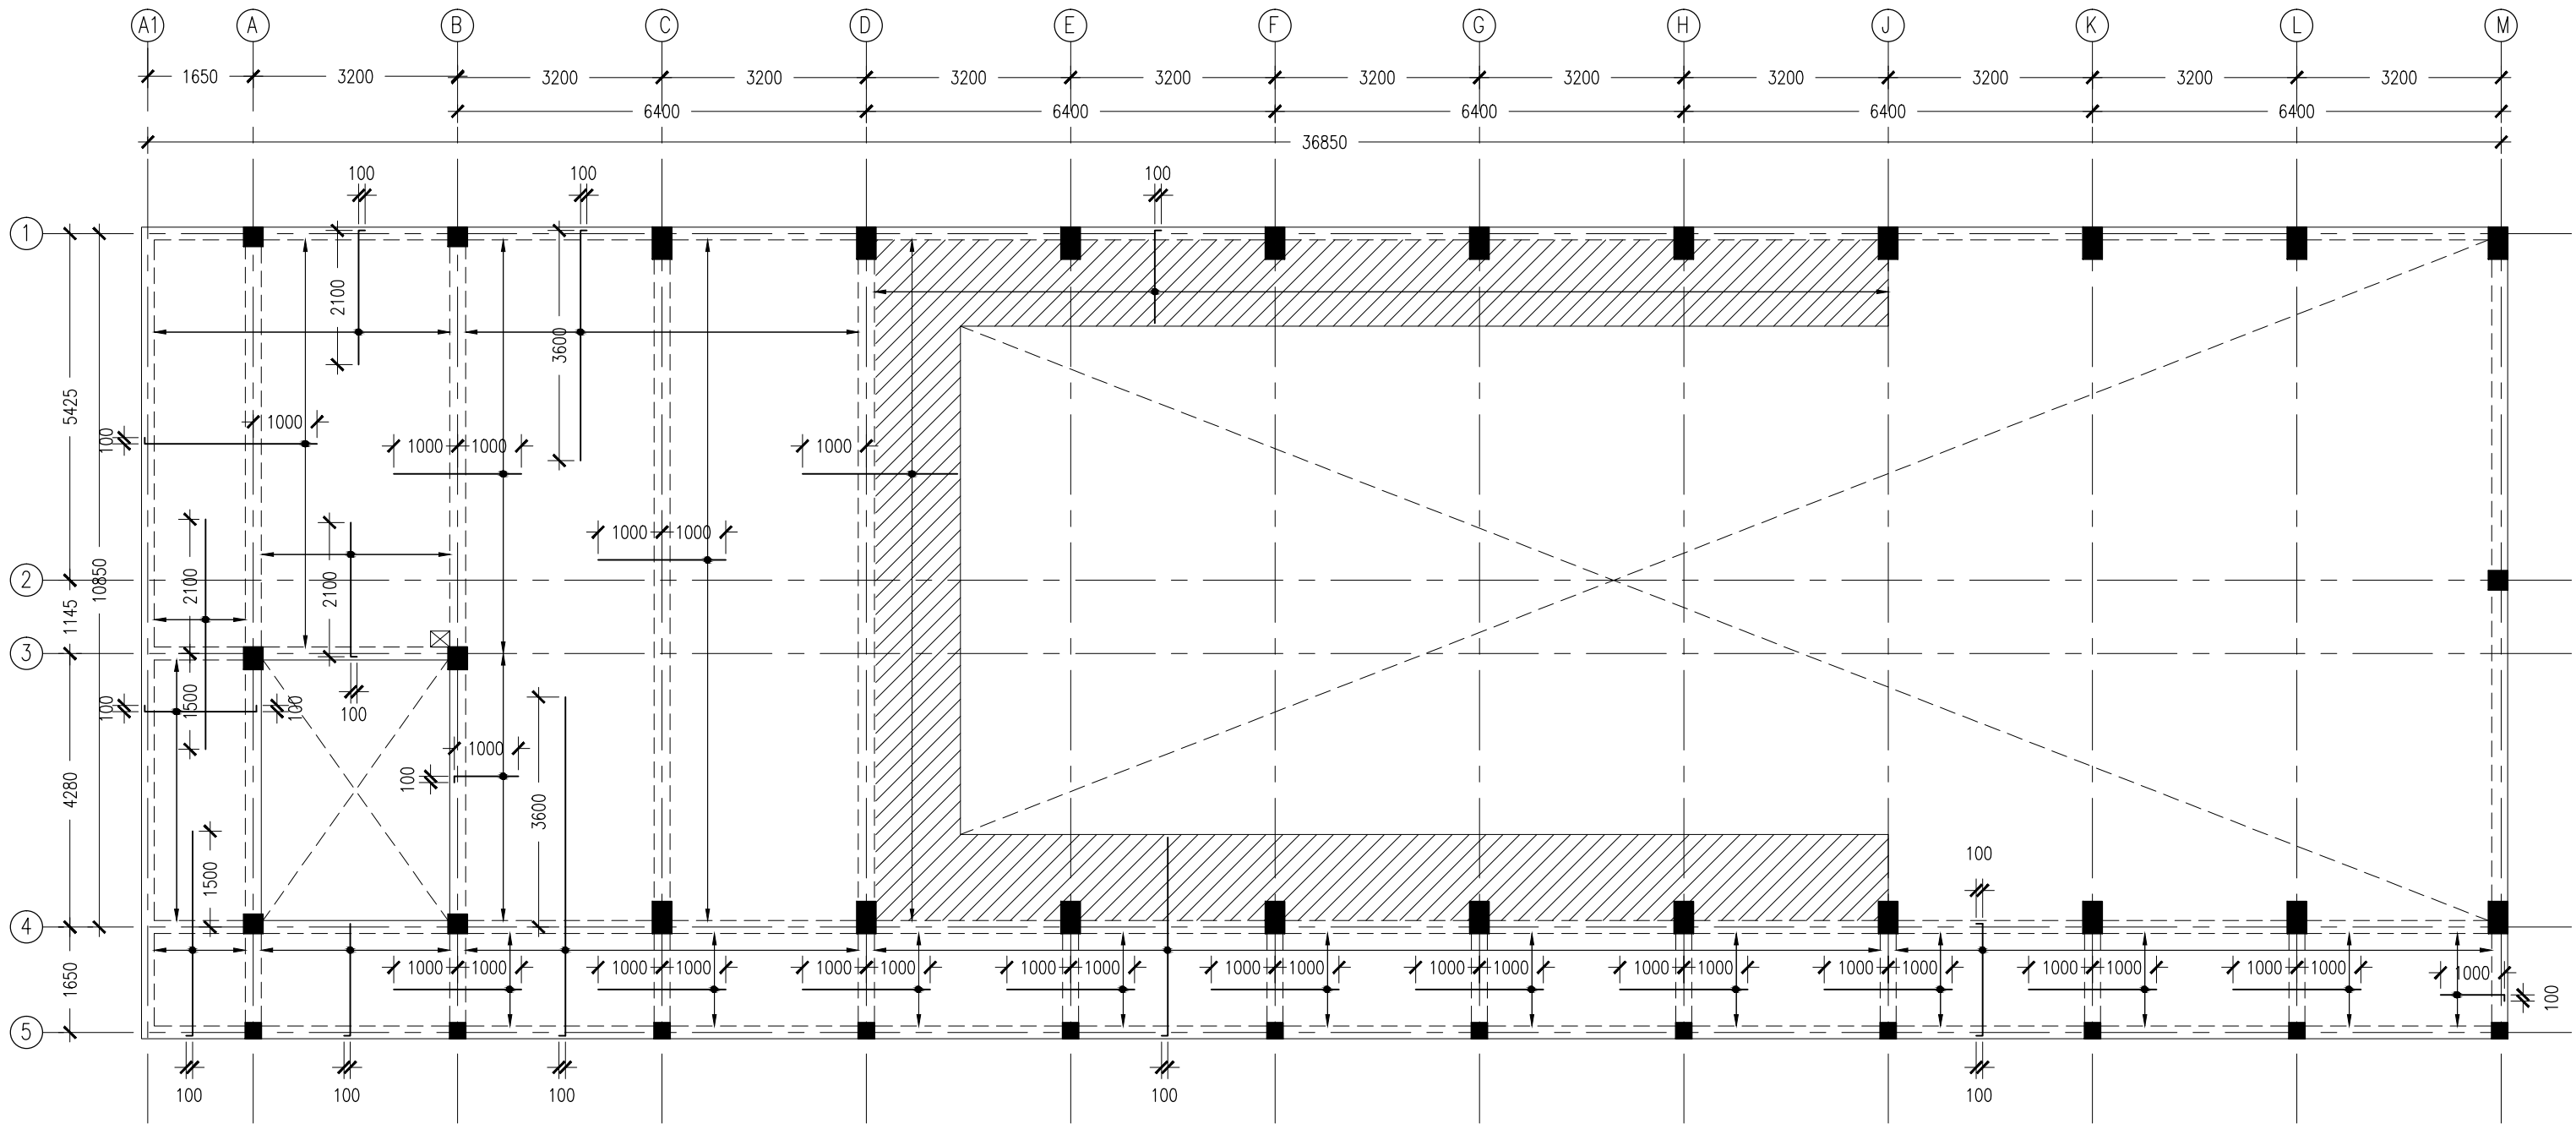

NOTE:

- \*SLAB THICKNESS: 140MM  
EXCEPT WHERE STATED
- \*SHADED AREA SLAB THICKNESS: 160MM  
EXCEPT WHERE STATED
- \*SLAB BOTTOM COVER: 30MM
- \*SLAB TOP COVER: 25MM
- \*SLAB TOP MAIN REINFORCEMENT : T12-100MM C/C  
AS SHOWN (UNLESS STATED OTHERWISE)
- \*SLAB BOTTOM REINFORCEMENT : T12-100MM BW C/C  
(THROUGHOUT) NOT SHOWN
- \*CURTAIL REBARS OVER OPENINGS
- \*PROVIDE EXTRA ADDITIONAL REINFORCEMENT

\*TYPICAL TOP REBAR

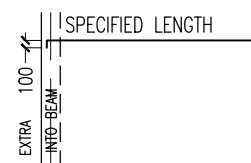

\*FCU=25N/MM2  
\*ADD CONMIX MegaFlow P TO ALL  
STRUCTURE CONCRETE

CONTRACTORS MUST  
CHECK ALL  
DIMENSIONS ON SITE  
BEFORE STARTING  
ANY WORK OR SHOP  
DRAWINGS, FIGURED  
DIMENSIONS TO TAKE  
PRECEDENCE OVER  
SCALE READINGS



REVISION:	ARCHITECT: MOHAMED HAMEEN
	ENGINEER: MOHAMED AHSAN
	SERVICES ENG:
	ESTIMATOR:
	DRAWN BY:

PROJECT:	6 CLASSROOM BLOCK, MULTI PURPOSE HALL BLOCK IN MEYNAA SCHOOL
LOCATION:	HA,HOLHUDHOO
DRAWING TITLE:	AS GIVEN
CLIENT:	MINISTRY OF EDUCATION
SCALE:	AS GIVEN
DIMENSION:	MM
DATE:	AUJUST 2015


PROJECT:	6 CLASSROOM BLOCK, MULTI PURPOSE HALL BLOCK IN MEYNAA SCHOOL
LOCATION:	HA,HOLHUDHOO
DRAWING TITLE:	AS GIVEN
CLIENT:	MINISTRY OF EDUCATION
SCALE:	AS GIVEN
DIMENSION:	MM
DATE:	AUJUST 2015

S-06
DWG NO
PROJECT NO.: 14-124

## 1ST FLOOR SLAB REINFORCEMENT PLAN

SCALE 1:100


CONCEPT AND DESIGN IN THIS DRAWING ARE THE PROPERTIES OF ARCHENG STUDIO PVT LTD. UNAUTHORIZED USE OR REPRODUCTION OF PART OF THE DESIGN,DRAWINGS OR CONCEPT TO USE IN OTHER PROJECTS OR SITES OTHER THAN SPECIFIED ON THIS DRAWING IS PROHIBITED

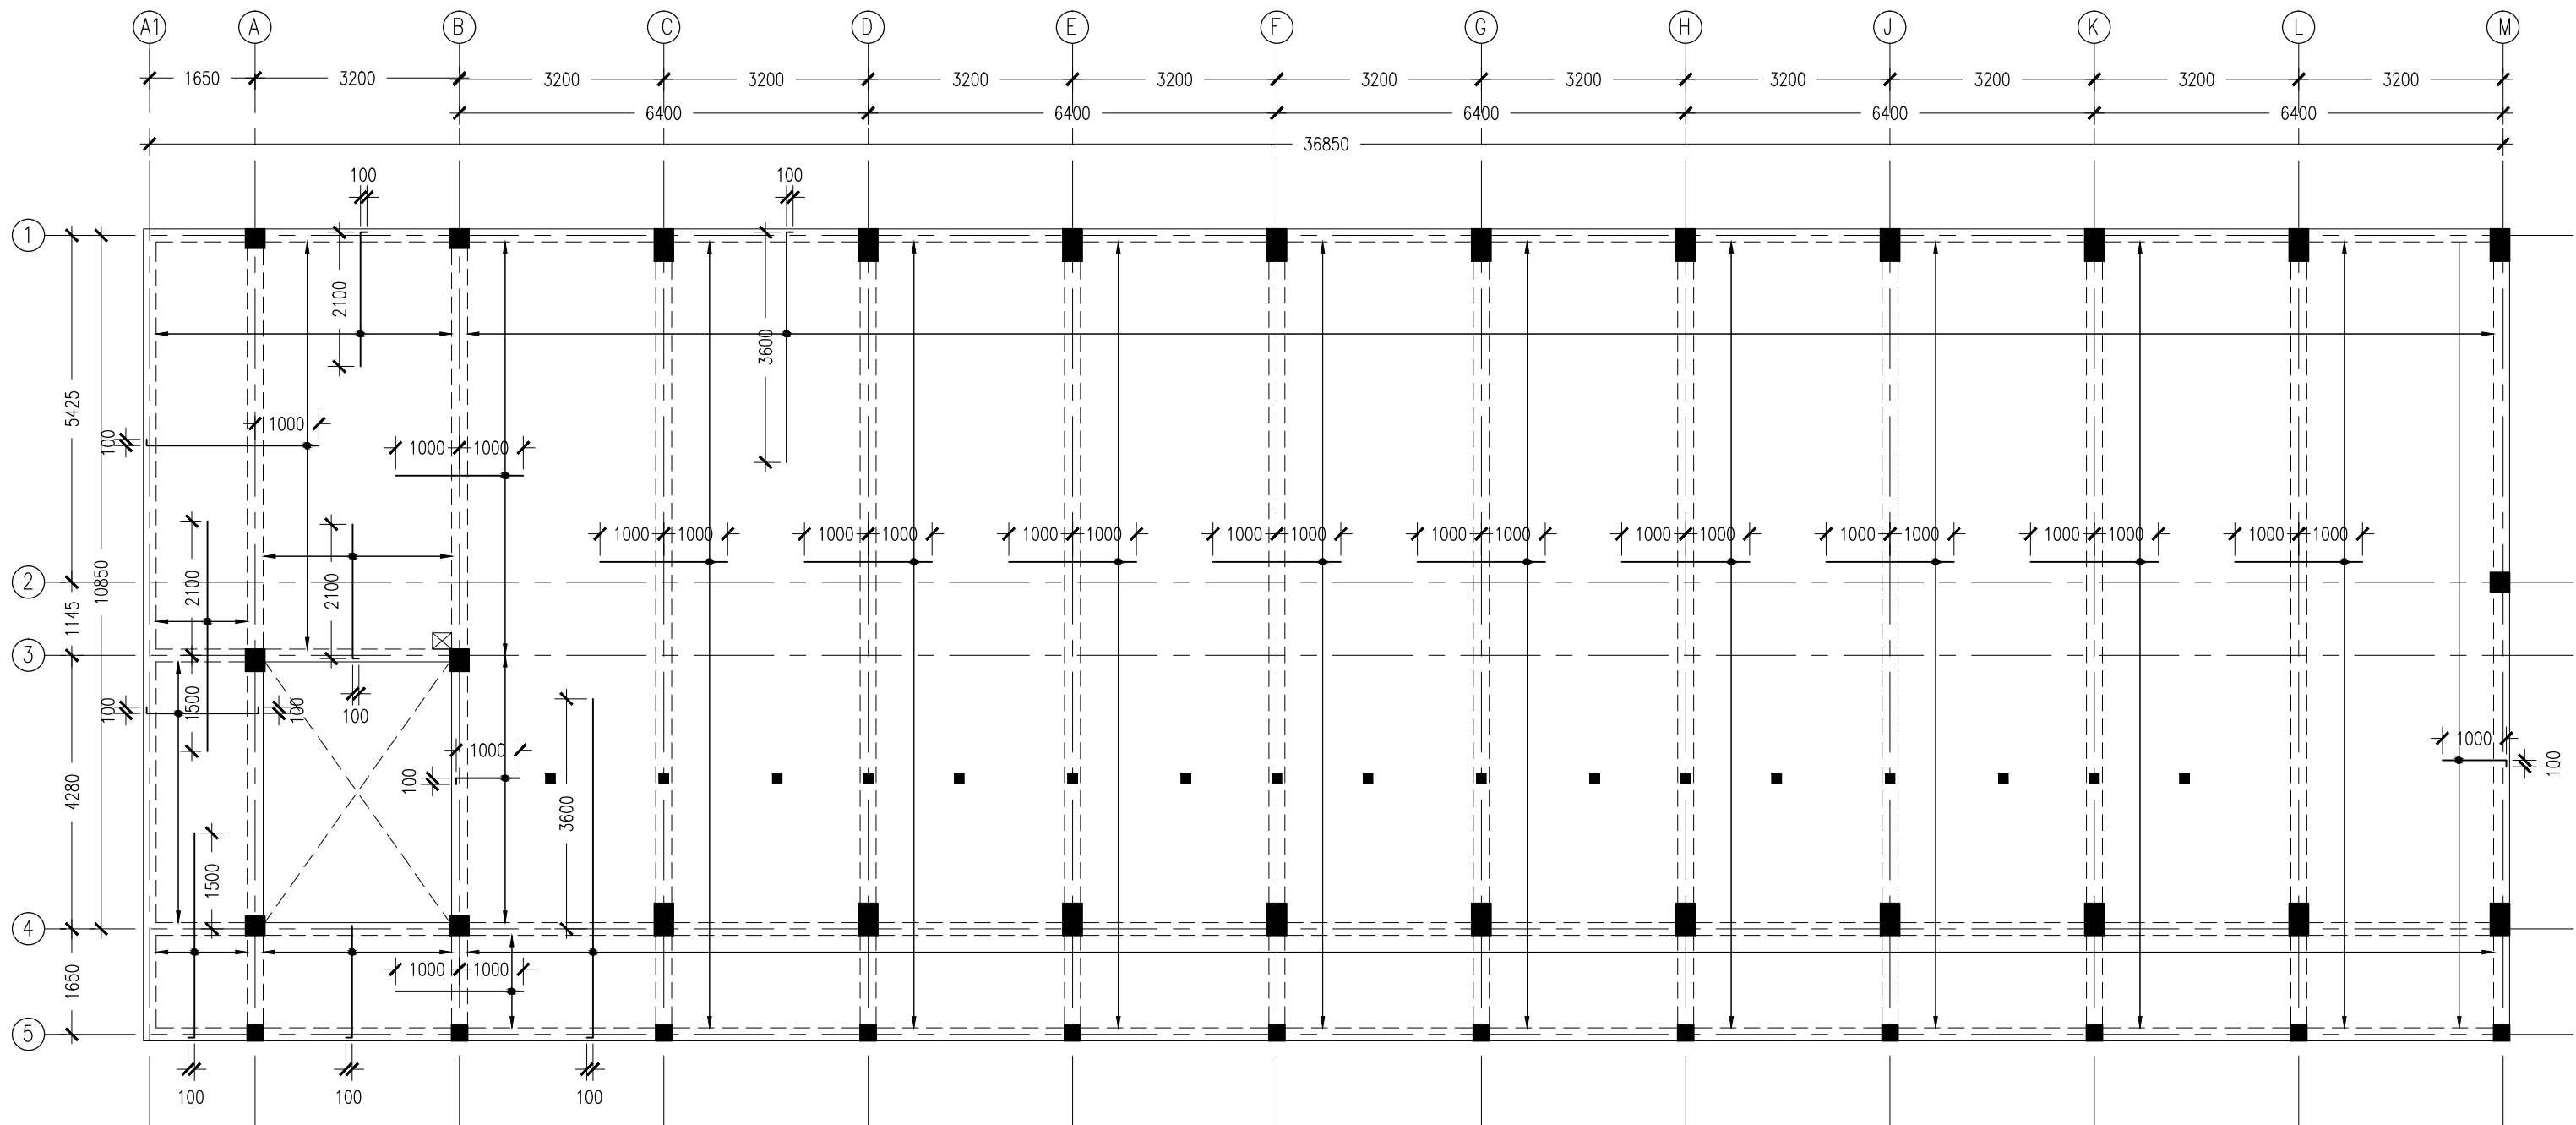

NOTE:

- \*SLAB THICKNESS: 180MM EXCEPT WHERE STATED
- \*SLAB BOTTOM COVER: 30MM
- \*SLAB TOP COVER: 25MM
- \*SLAB TOP MAIN REINFORCEMENT : T12-100MM C/C AS SHOWN (UNLESS STATED OTHERWISE)
- \*SLAB BOTTOM REINFORCEMENT : T12-100MM BW C/C (THROUGHOUT) NOT SHOWN
- \*CURTAIL REBARS OVER OPENINGS
- \*PROVIDE EXTRA ADDITIONAL REINFORCEMENT AS SPECIFIED
- \*TOP DISTRIBUTION REINFORCEMENT : T10@300 BW C/C (NOT SHOWN)

\*TYPICAL TOP REBAR

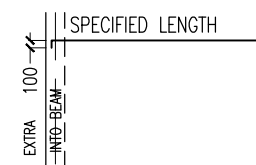

- \*FCU=25N/MM2
- \*ADD CONMIX MegaFlow P TO ALL STRUCTURE CONCRETE

CONTRACTORS MUST CHECK ALL DIMENSIONS ON SITE BEFORE STARTING ANY WORK OR SHOP DRAWINGS. FIGURED DIMENSIONS TO TAKE PRECEDENCE OVER SCALE READINGS




## 2ND FLOOR SLAB REINFORCEMENT PLAN

SCALE 1:100


REVISION:	ARCHITECT: MOHAMED HAMEEN	PROJECT: 6 CLASSROOM BLOCK, MULTI PURPOSE HALL BLOCK IN MEYNAA SCHOOL	S-07
	ENGINEER: MOHAMED AHSAN	LOCATION: HA.HOLHUDHOO	
	SERVICES ENG:	DRAWING TITLE: AS GIVEN	
	ESTIMATOR:	CLIENT: MINISTRY OF EDUCATION	
	DRAWN BY:	SCALE: AS GIVEN	DWG NO
		DIMENSION: MM	PROJECT NO.: 14-124
		DATE: AUJULY 2015	

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NOTE:

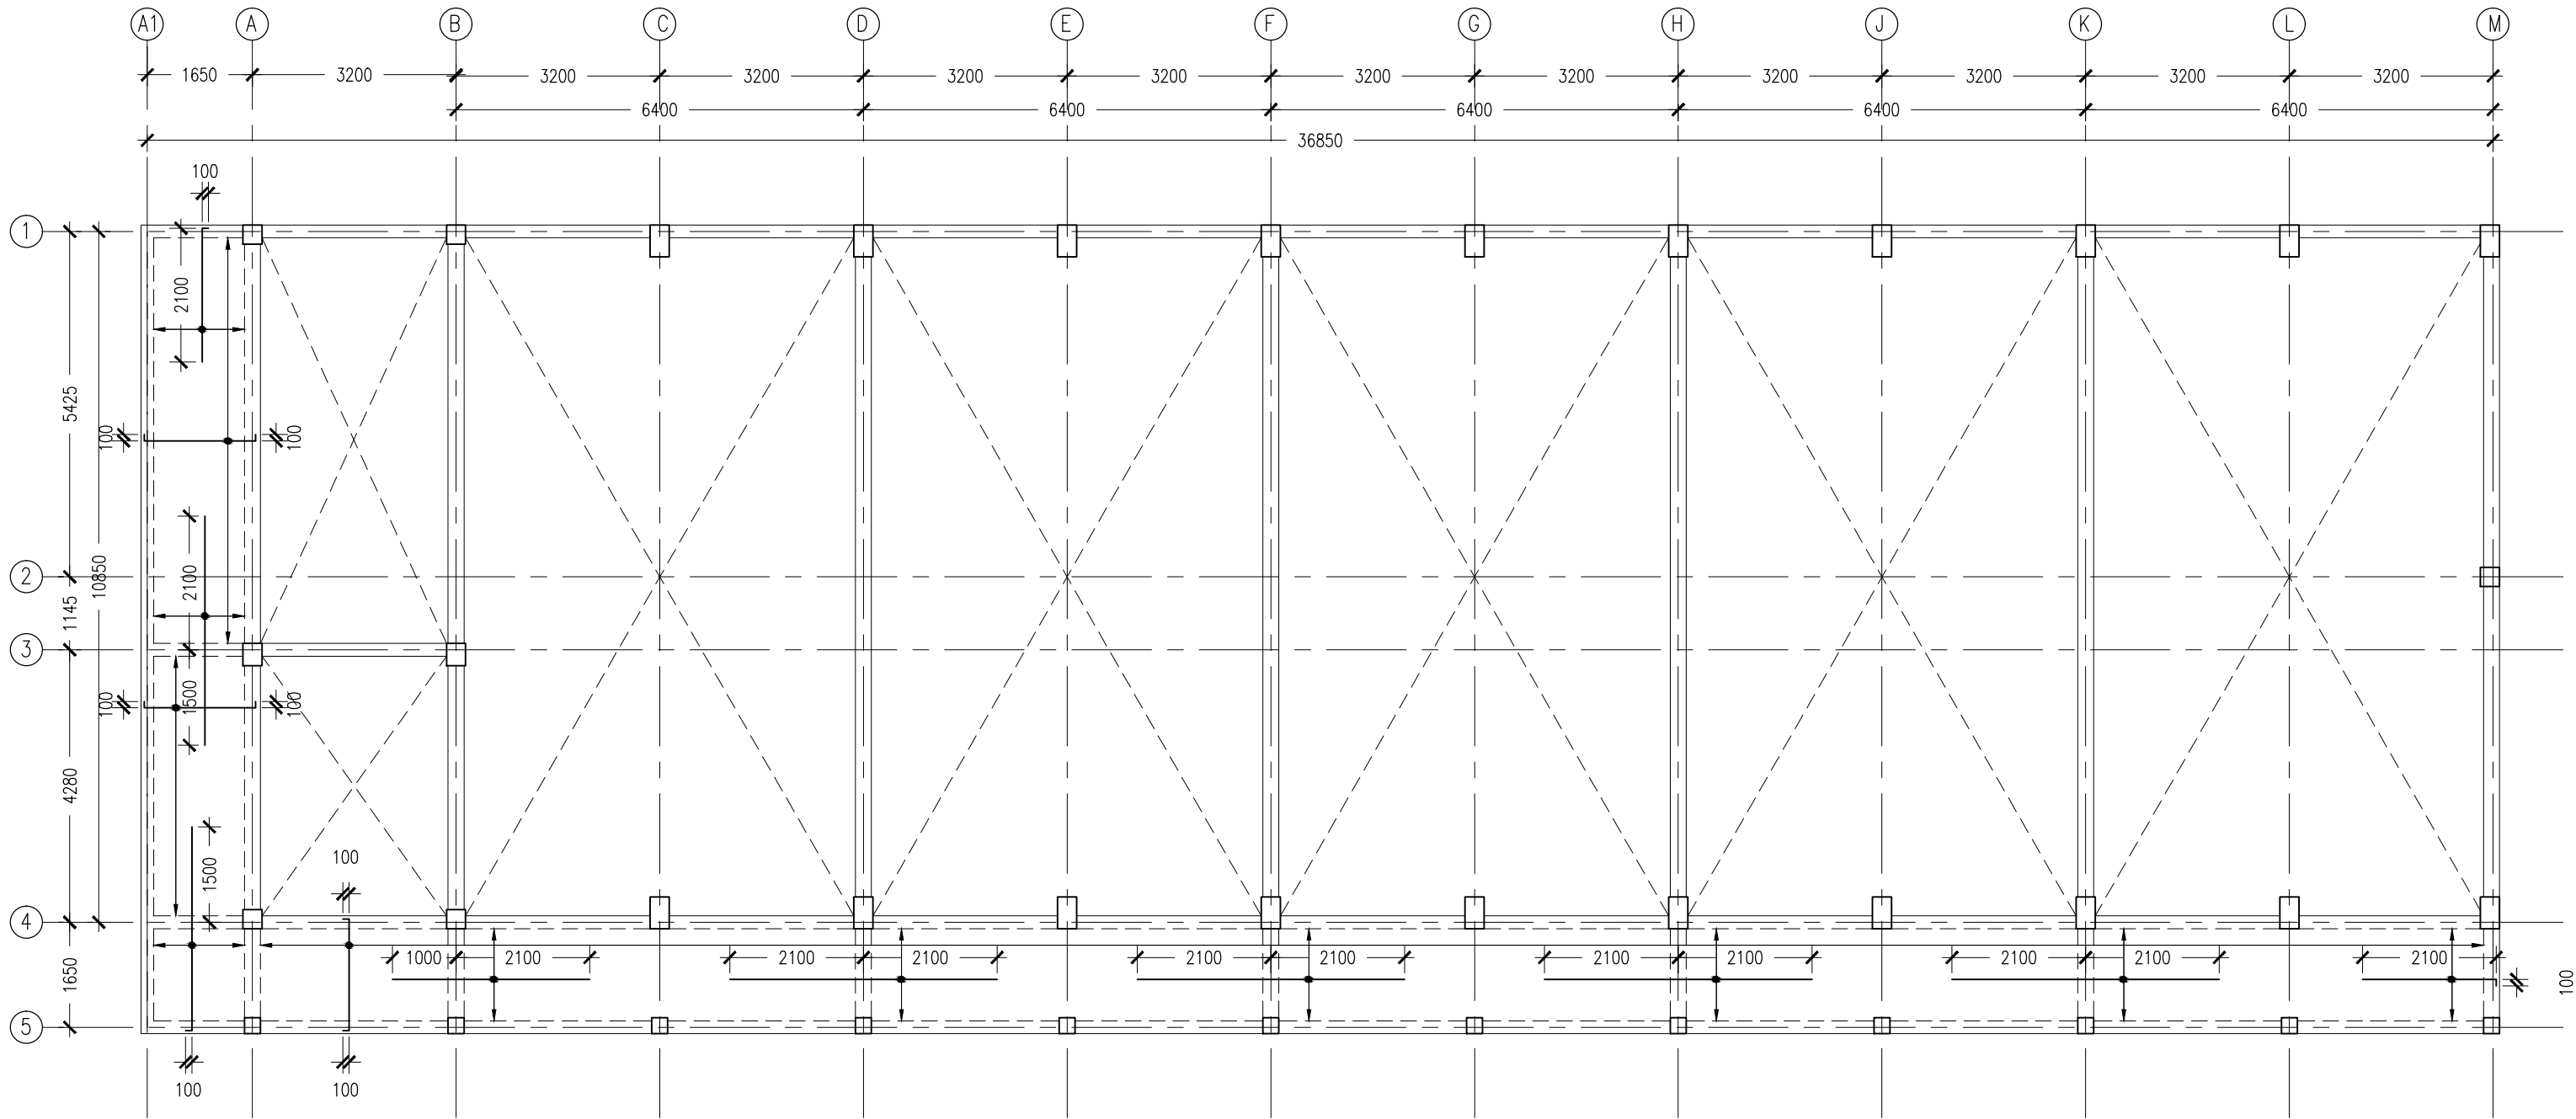- \*SLAB THICKNESS: 180MM EXCEPT WHERE STATED
- \*SLAB BOTTOM COVER: 30MM
- \*SLAB TOP COVER: 25MM
- \*SLAB TOP MAIN REINFORCEMENT : T12-100MM C/C AS SHOWN (UNLESS STATED OTHERWISE)
- \*SLAB BOTTOM REINFORCEMENT : T12-100MM BW C/C (THROUGHOUT) NOT SHOWN
- \*CURTAIL REBARS OVER OPENINGS
- \*PROVIDE EXTRA ADDITIONAL REINFORCEMENT AS SPECIFIED
- \*TOP DISTRIBUTION REINFORCEMENT : T10@300 BW C/C (NOT SHOWN)



\*FCU=25N/MM2  
\*ADD CONMIX MegaFlow P TO ALL SURFACES OF STRUCTURE CONCRETE

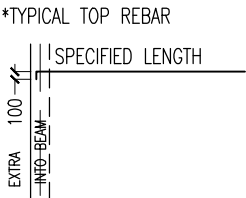CONTRACTORS MUST CHECK ALL DIMENSIONS ON SITE BEFORE STARTING ANY WORK OR SHOP DRAWINGS FIGURED DIMENSIONS TO TAKE PRECEDENCE OVER SCALE READINGS




# ROOF SLAB REINFORCEMENT PLAN

SCALE 1:100

REVISION:	ARCHITECT:	MOHAMED HAMEEN	PROJECT:	6 CLASSROOM BLOCK, MULTI PURPOSE HALL BLOCK IN MEYNAA SCHOOL		S-08	
	ENGINEER:	MOHAMED AHSAN	LOCATION:	HA,HOLHUDHOO			
	SERVICES ENG:		DRAWING TITLE:	AS GIVEN			
	ESTIMATOR:		CLIENT:	MINISTRY OF EDUCATION			
	DRAWN BY:		SCALE:	AS GIVEN	DIMENSION:		MM
CONCEPT AND DESIGN IN THIS DRAWING ARE THE PROPERTIES OF ARCHENG STUDIO PVT LTD. UNAUTHORIZED USE OR REPRODUCTION OF PART OF THE DESIGN,DRAWINGS OR CONCEPT TO USE IN OTHER PROJECTS OR SITES OTHER THAN SPECIFIED ON THIS DRAWING IS PROHIBITED							DWG NO
							PROJECT NO.: 14-124



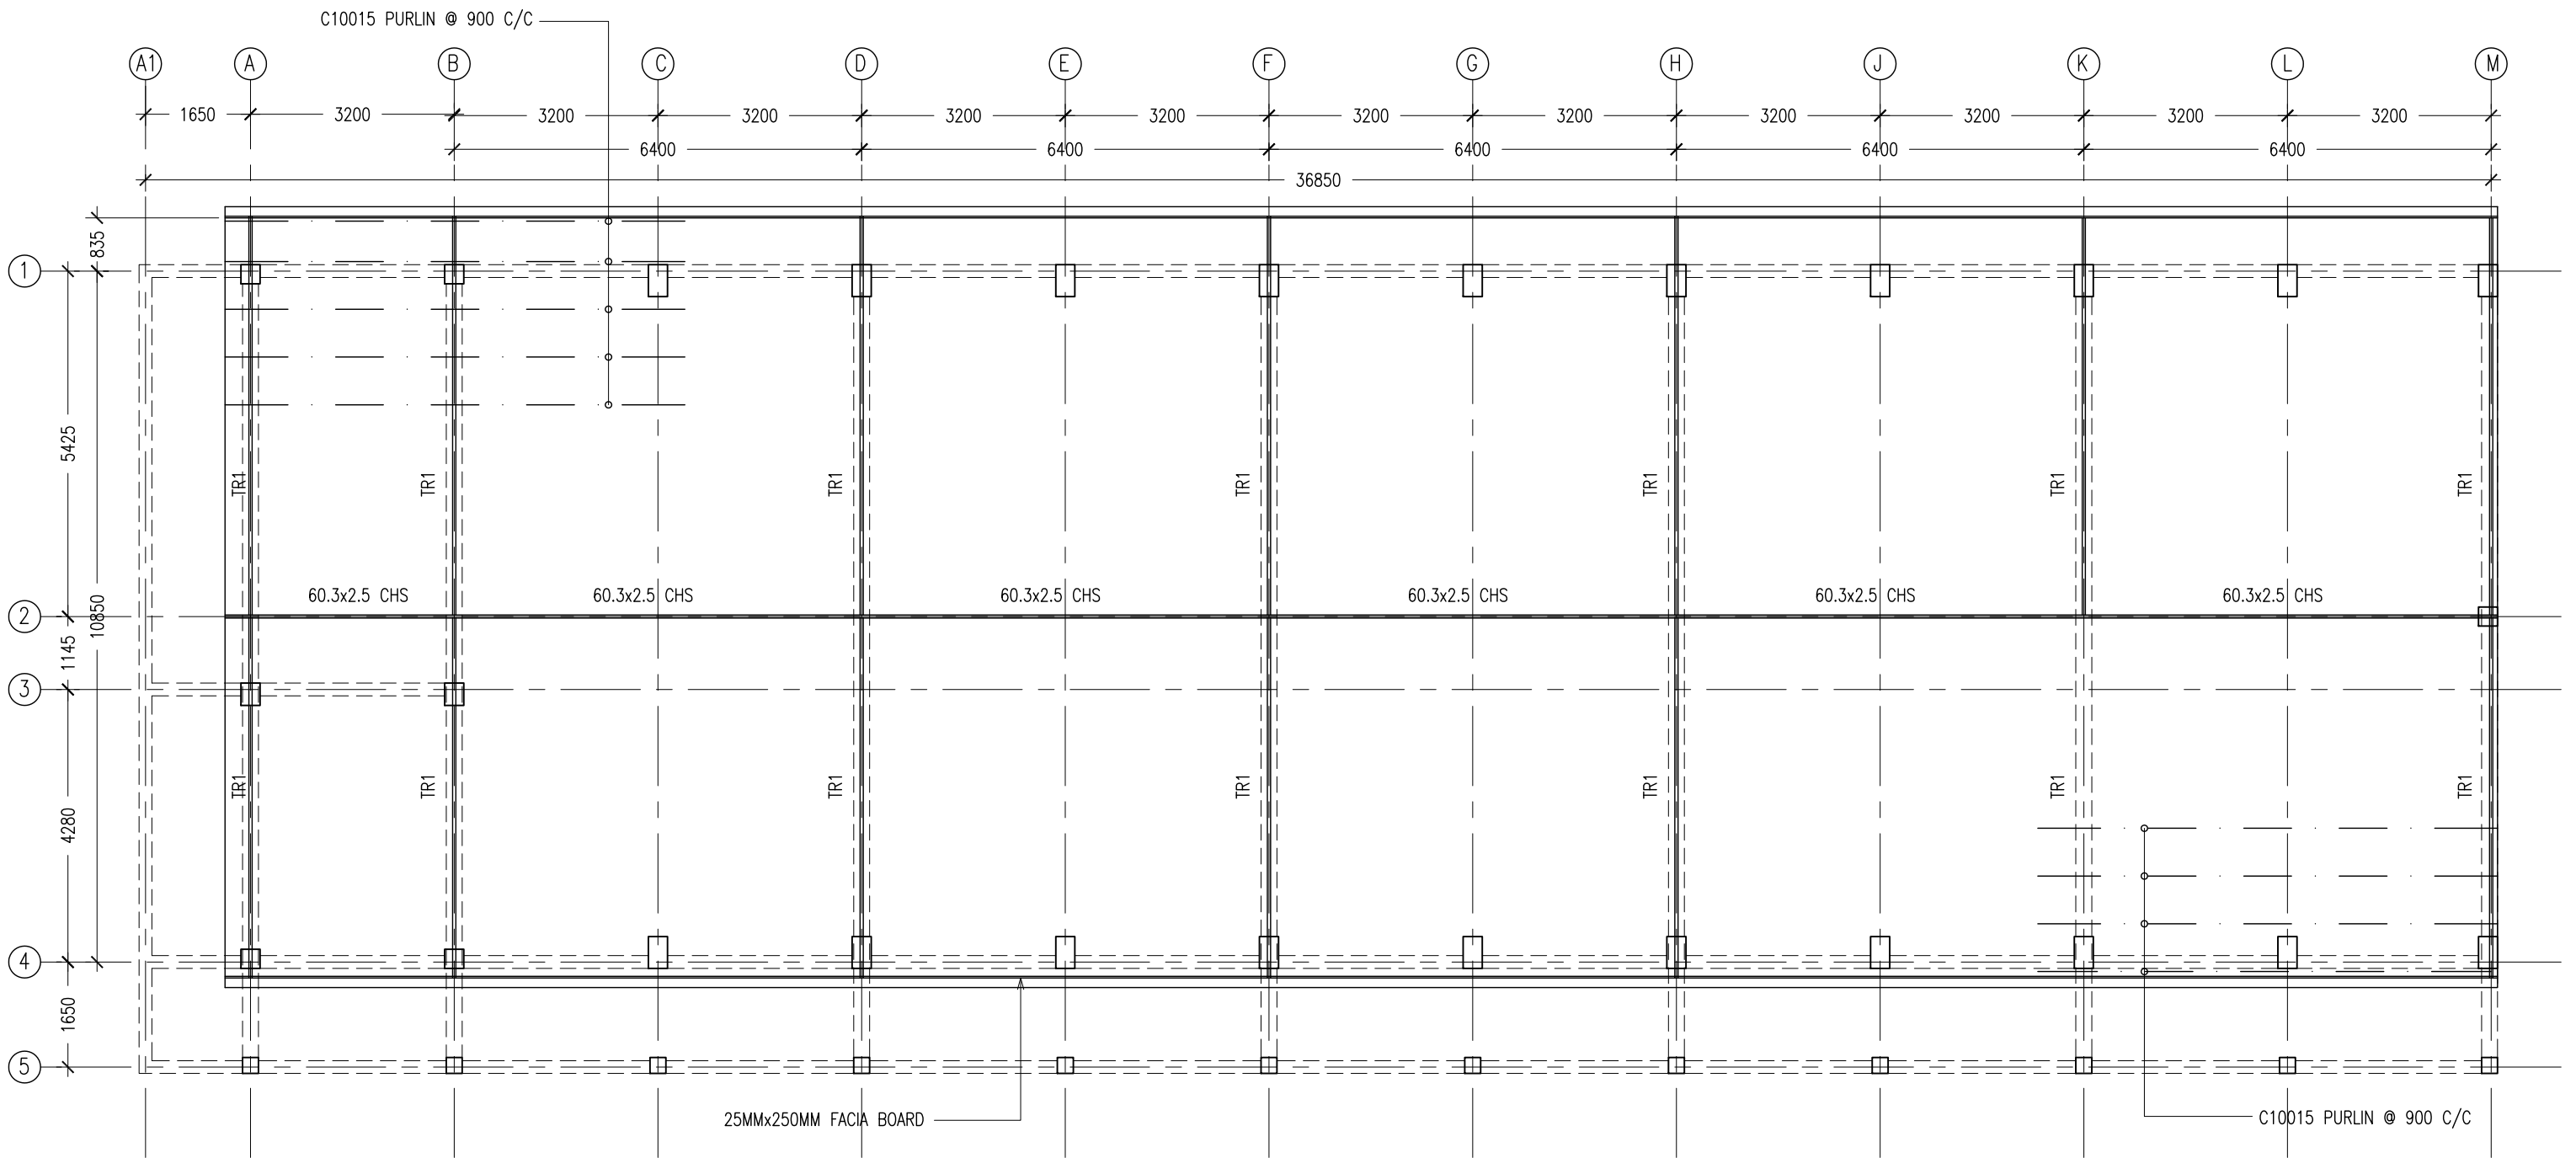

ROOF STRUCTURE PLAN  
SCALE 1:100

CONTRACTORS MUST  
CHECK ALL  
DIMENSIONS ON SITE  
BEFORE STARTING  
ANY WORK OR SHOP  
DRAWINGS. FIGURED  
DIMENSIONS TO TAKE  
PRECEDENCE OVER  
SCALE READINGS




REVISION:	

ARCHITECT:	MOHAMED HAMEEN
ENGINEER:	MOHAMED AHSAN
SERVICES ENG:	
ESTIMATOR:	
DRAWN BY:	


PROJECT:	6 CLASSROOM BLOCK, MULTI PURPOSE HALL BLOCK IN MEYNAA SCHOOL		
LOCATION:	HA.HOLHUDHOO		
DRAWING TITLE:	AS GIVEN		
CLIENT:	MINISTRY OF EDUCATION		
SCALE:	AS GIVEN	DIMENSION:	MM
		DATE:	AUJUST 2015

S-09	DWG NO
	PROJECT NO.: 14-124


CONCEPT AND DESIGN IN THIS DRAWING ARE THE PROPERTIES OF ARCHENG STUDIO PVT LTD. UNAUTHORIZED USE OR REPRODUCTION OF PART OF THE DESIGN, DRAWINGS OR CONCEPT TO USE IN OTHER PROJECTS OR SITES OTHER THAN SPECIFIED ON THIS DRAWING IS PROHIBITED

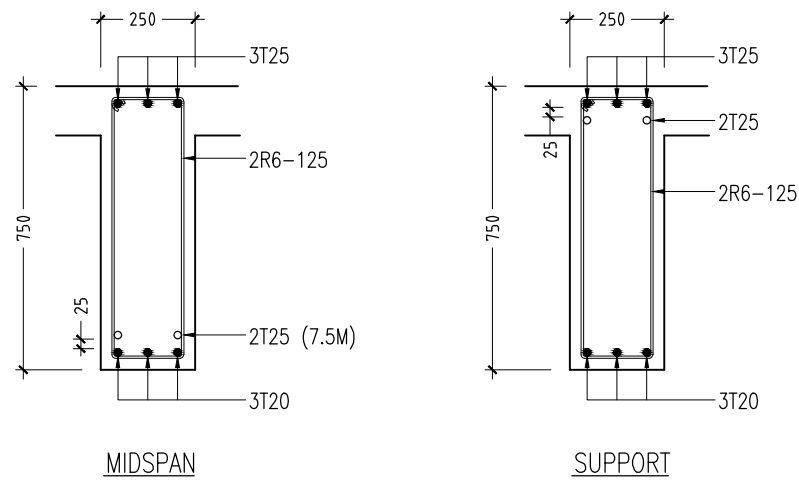


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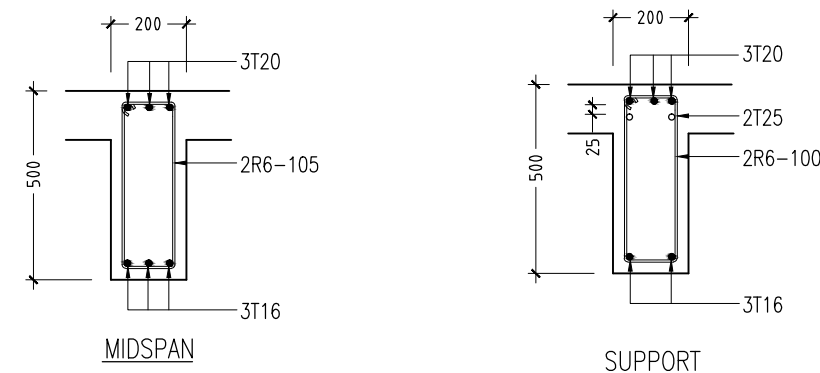
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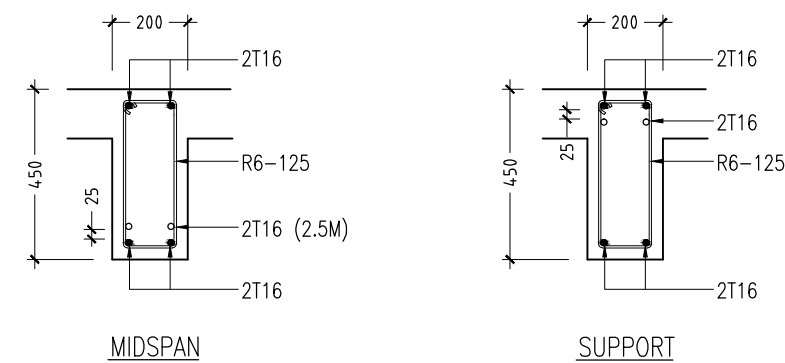
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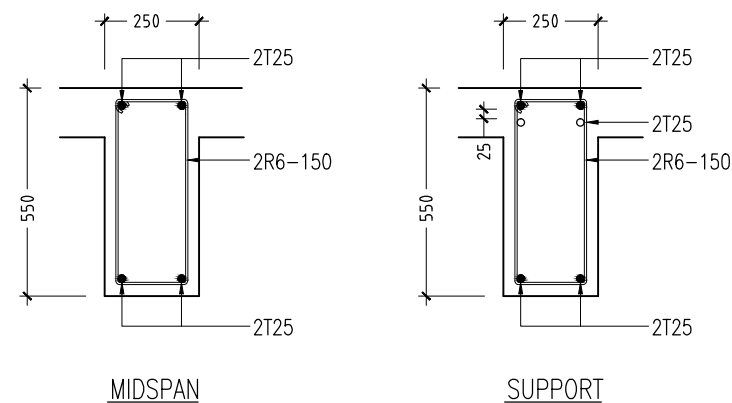
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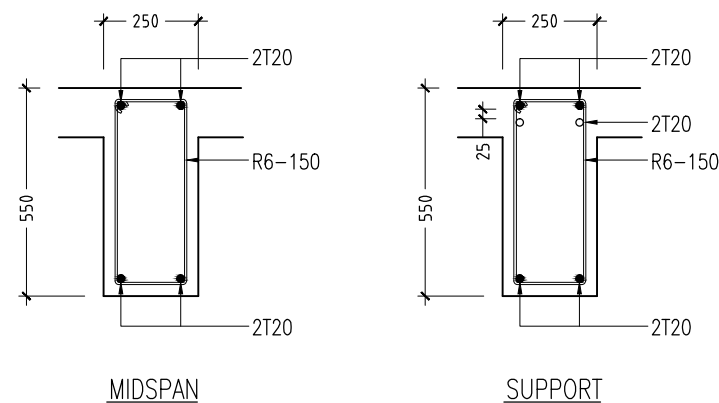
B5/CB1

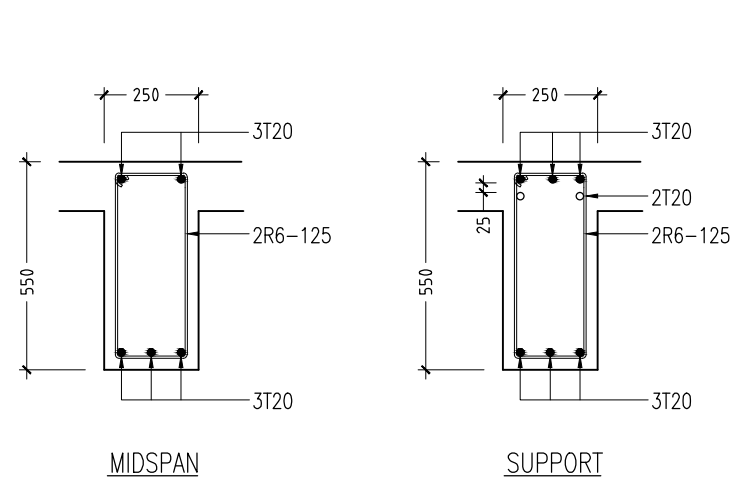


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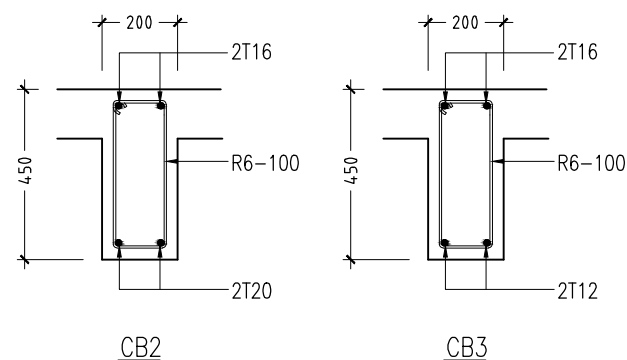
B7

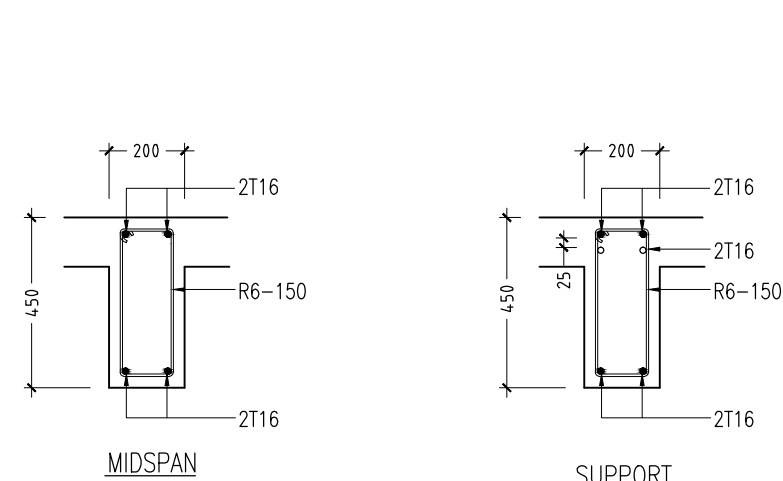

B8

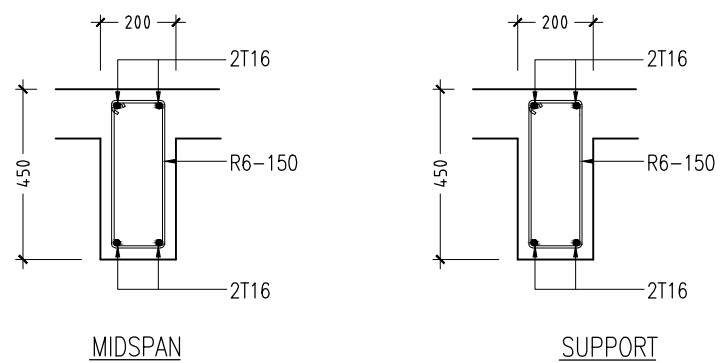

B9

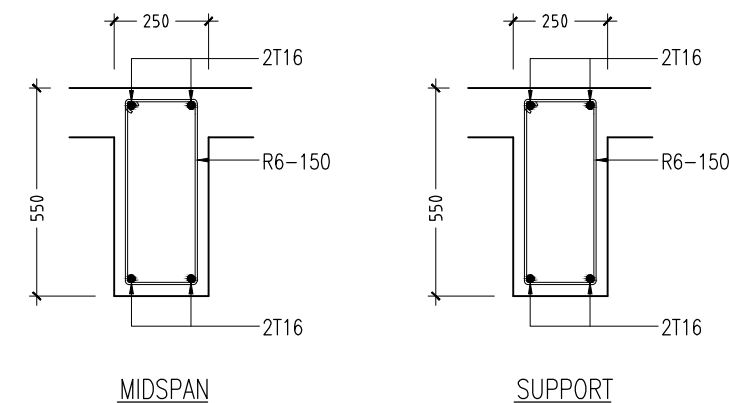

CB2

CB3

## BEAM DETAILS

SCALE 1:20

CONTRACTORS MUST  
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DIMENSIONS ON SITE  
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ANY WORK OR SHOP  
DRAWINGS, FIGURED  
DIMENSIONS TO TAKE  
PRECEDENCE OVER  
SCALE READINGS

**ArchEng**  
studio  
Ma Fiyajahaage, 1st floor, Male', Republic of Maldives  
admin@archeng.biz

REVISION:  
\_\_\_\_\_  
\_\_\_\_\_  
\_\_\_\_\_  
\_\_\_\_\_

ARCHITECT: MOHAMED HAMEEN  
ENGINEER: MOHAMED AHSAN  
SERVICES ENG:  
ESTIMATOR:  
DRAWN BY:


PROJECT: 6 CLASSROOM BLOCK, MULTI PURPOSE HALL BLOCK IN MEYNAA SCHOOL  
LOCATION: HA, HOLHUDHOO  
DRAWING TITLE: AS GIVEN  
CLIENT: MINISTRY OF EDUCATION  
SCALE: AS GIVEN DIMENSION: MM DATE: AUJUGST 2015

**S-10**  
DWG NO  
PROJECT NO.: 14-124


CONCEPT AND DESIGN IN THIS DRAWING ARE THE PROPERTIES OF ARCHENG STUDIO PVT LTD. UNAUTHORIZED USE OR REPRODUCTION OF PART OF THE DESIGN, DRAWINGS OR CONCEPT TO USE IN OTHER PROJECTS OR SITES OTHER THAN SPECIFIED ON THIS DRAWING IS PROHIBITED

	FOOTING	LENGTH/mm	WIDTH/mm	DEPTH/mm	REINFORCEMENT
	F1	2300	2800	400	T16@175mm BW (T/B)
	F2	3500	2700	400	T20@175mm BW (B) / T16@170mm BW (T)
	F3	2300	2800	400	T16@150mm BW (T/B)
	F4	2100	2100	400	T16@150mm BW (T/B)
	F5	2450	2450	450	T16@125mm BW (T/B)
	F6	1700	1700	400	T16@150mm BW (T/B)
	F7	1500	1500	400	T16@150mm BW (T/B)
	F8	2000	1500	400	T16@150mm BW (B)
	F9	2250	1100	400	T16@125mm BW (B)
	F10	1600	750	400	T12@100mm BW (T/B)


FOOTING DETAILS

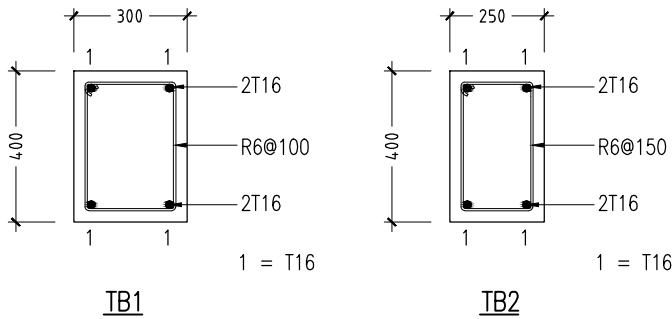


FOUNDATION BEAM DETAILS  
SCALE 1:20

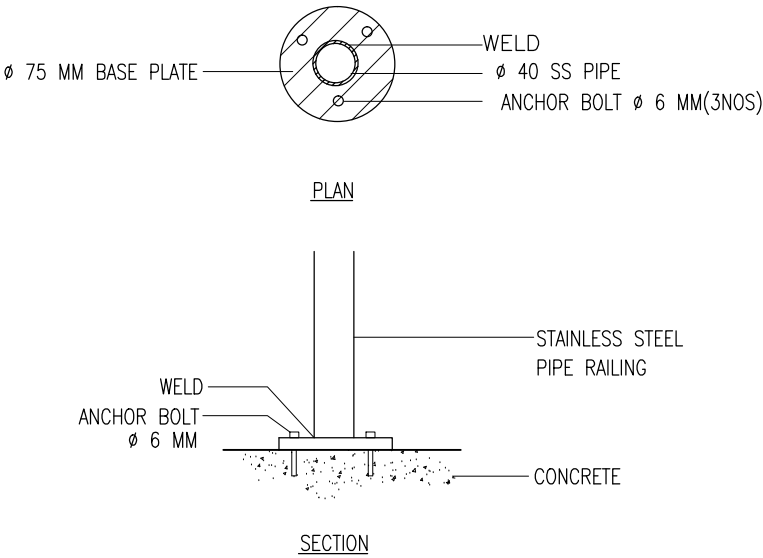

DETAIL D ( STAIR RAILING )  
SCALE 1:20

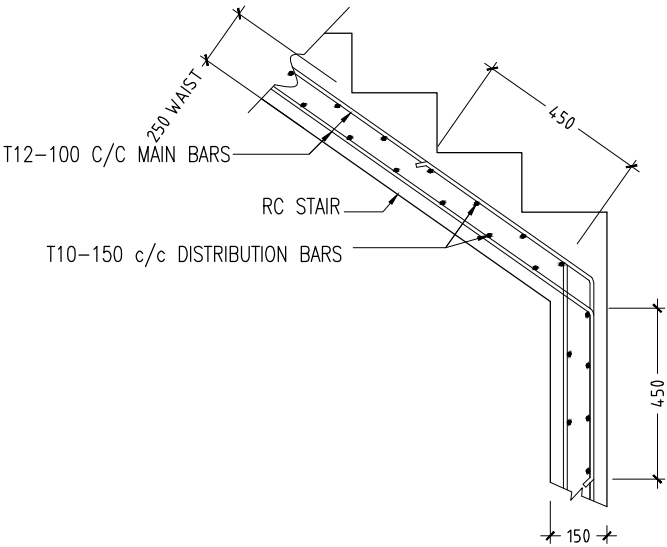


TYPICAL STAIR RFMT DETAIL  
SCALE 1:20

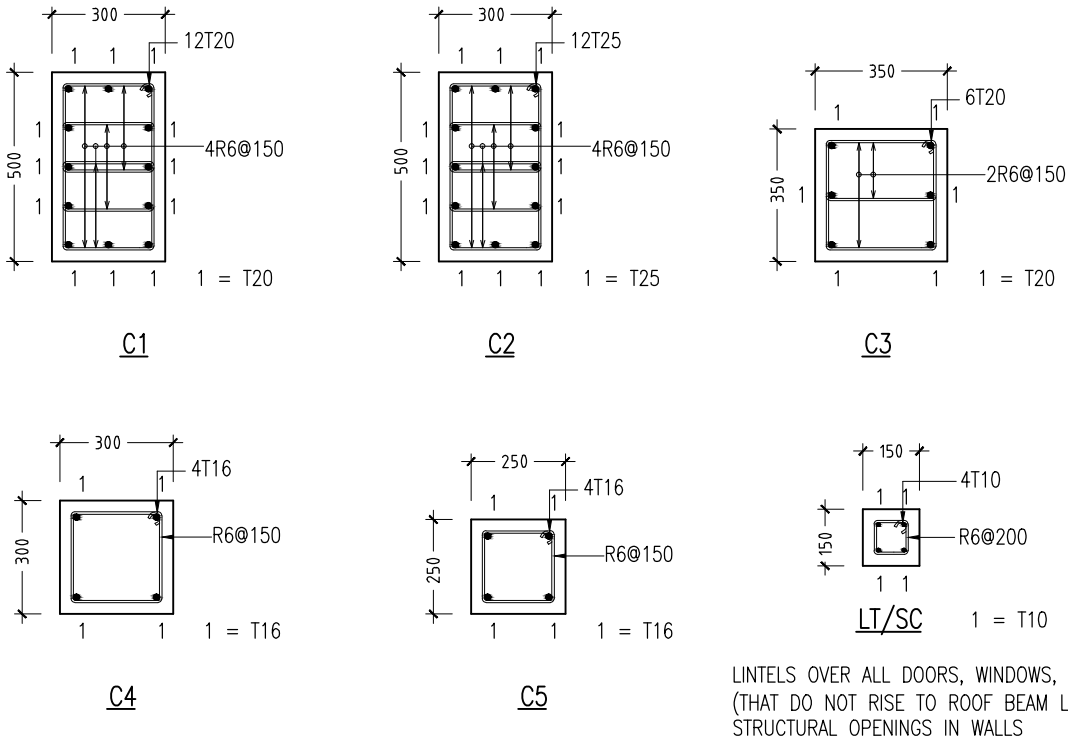

LINTELS OVER ALL DOORS, WINDOWS,  
(THAT DO NOT RISE TO ROOF BEAM LEVEL)  
STRUCTURAL OPENINGS IN WALLS

COLUMN DETAILS  
SCALE 1:20

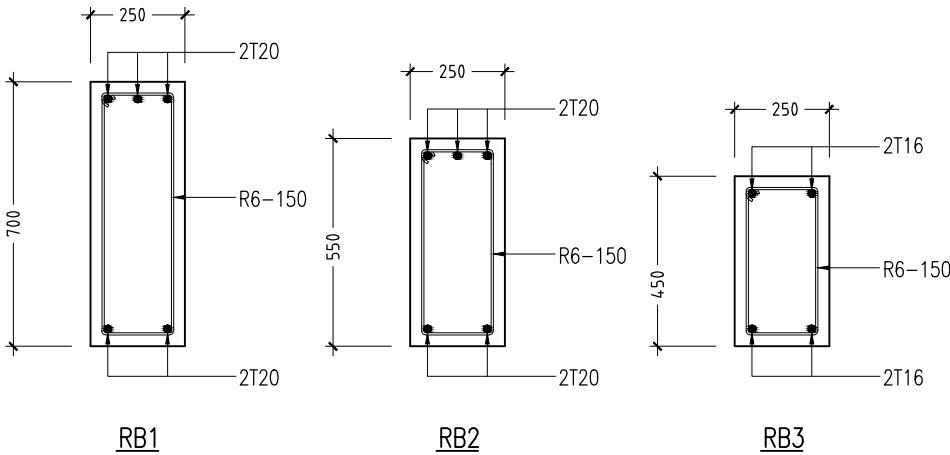

ROOF BEAM DETAILS  
SCALE 1:20

CONTRACTORS MUST  
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DIMENSIONS ON SITE  
BEFORE STARTING  
ANY WORK OR SHOP  
DRAWINGS, FIGURED  
DIMENSIONS TO TAKE  
PRECEDENCE OVER  
SCALE READINGS



REVISION:

ARCHITECT:	MOHAMED HAMEEN
ENGINEER:	MOHAMED AHSAN
SERVICES ENG:	
ESTIMATOR:	
DRAWN BY:	

PROJECT:	6 CLASSROOM BLOCK, MULTI PURPOSE HALL BLOCK IN MEYNAA SCHOOL		
LOCATION:	HAJOLHUDHOO		
DRAWING TITLE:	AS GIVEN		
CLIENT:	MINISTRY OF EDUCATION		
SCALE:	AS GIVEN	DIMENSION:	MM
DATE:	AUJUST 2015		

S-11
DWG NO
PROJECT NO: 14-124



PROJECT NO.: 14-124

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# **PROPOSED 6 CLASSROOM BLOCK & MULTI PURPOSE HALL BLOCK IN MEYNAA SCHOOL AT N.HOLHUDHOO**

**( 3 STOREY )**


**ENHANCING EDUCATION DEVELOPMENT PROJECT (EEDP)  
SERVICES DRAWINGS**

AUGUST 2015

CLIENT : MINISTRY OF EDUCATION

DESIGN BY

**ArchEng**  
s t u d i o  
Ma Fiyajahaage, 1st floor, Male'. Republic of Maldives  
admin@archeng.biz

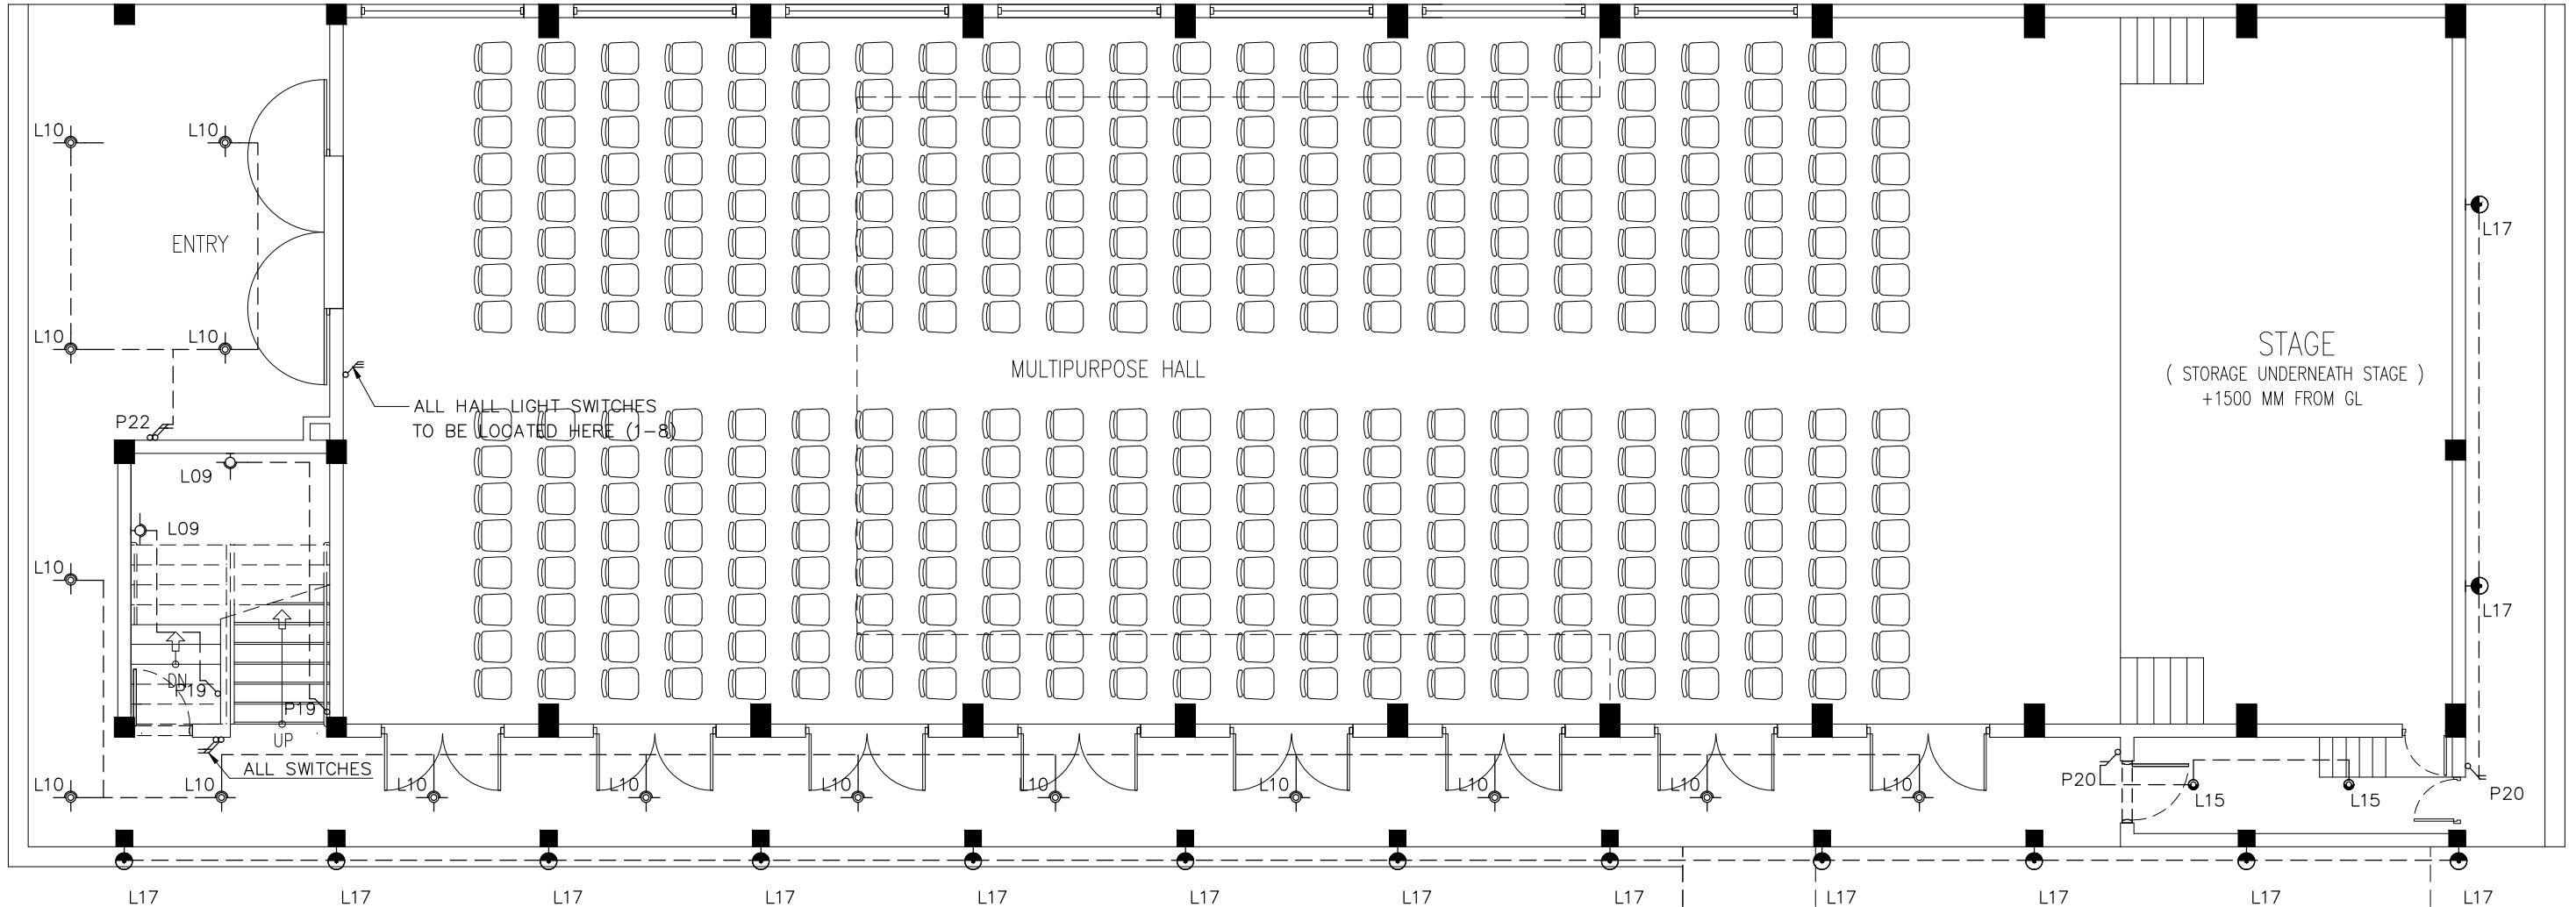

LEGEND


SYMBOL	CODE	DESCRIPTION
	L07	2X36W FLUORESCENT LAMPS IN SURFACE MOUNT LUMINAIRE WITH DIFFUSER
	L09	WALL MOUNT ENERGY SAVING LIGHT
	L10	1X26W COMPACT FLUORESCENT LAMPS IN RECESSED DECORATIVE LUMINAIRE
	L15	1X60W INCANDESCENT LAMPS IN RECESSED DECORATIVE LUMINAIRE
	L17	1X60W INCANDESCENT LAMPS IN SURFACE MOUNT WEATHER PROOF LUMINAIRE

	P19	1GANG 1 WAY SWITCH
	P20	2GANG 1 WAY SWITCH
	P21	3GANG 1 WAY SWITCH
	P22	4GANG 1 WAY SWITCH

CONTRACTORS MUST  
CHECK ALL  
DIMENSIONS ON SITE  
BEFORE STARTING  
ANY WORK OR SHOP  
DRAWINGS. FIGURED  
DIMENSIONS TO TAKE  
PRECEDENCE OVER  
SCALE READINGS



REVISION:	ARCHITECT: MOHAMED HAMEEN	PROJECT: 6 CLASSROOM BLOCK, MULTI PURPOSE HALL BLOCK IN MEYNAA SCHOOL	E-01
	ENGINEER: MOHAMED AHSAN	LOCATION: HA,HOLHUDHOO	
	SERVICES ENG:	DRAWING TITLE: AS GIVEN	
	ESTIMATOR:	CLIENT: MINISTRY OF EDUCATION	
	DRAWN BY:	SCALE: AS GIVEN    DIMENSION: MM    DATE: AUGUST 2015	
CONCEPT AND DESIGN IN THIS DRAWING ARE THE PROPERTIES OF ARCHENG STUDIO PVT LTD. UNAUTHORIZED USE OR REPRODUCTION OF PART OF THE DESIGN,DRAWINGS OR CONCEPT TO USE IN OTHER PROJECTS OR SITES OTHER THAN SPECIFIED ON THIS DRAWING IS PROHIBITED			DWG NO
			PROJECT NO.: 14-124

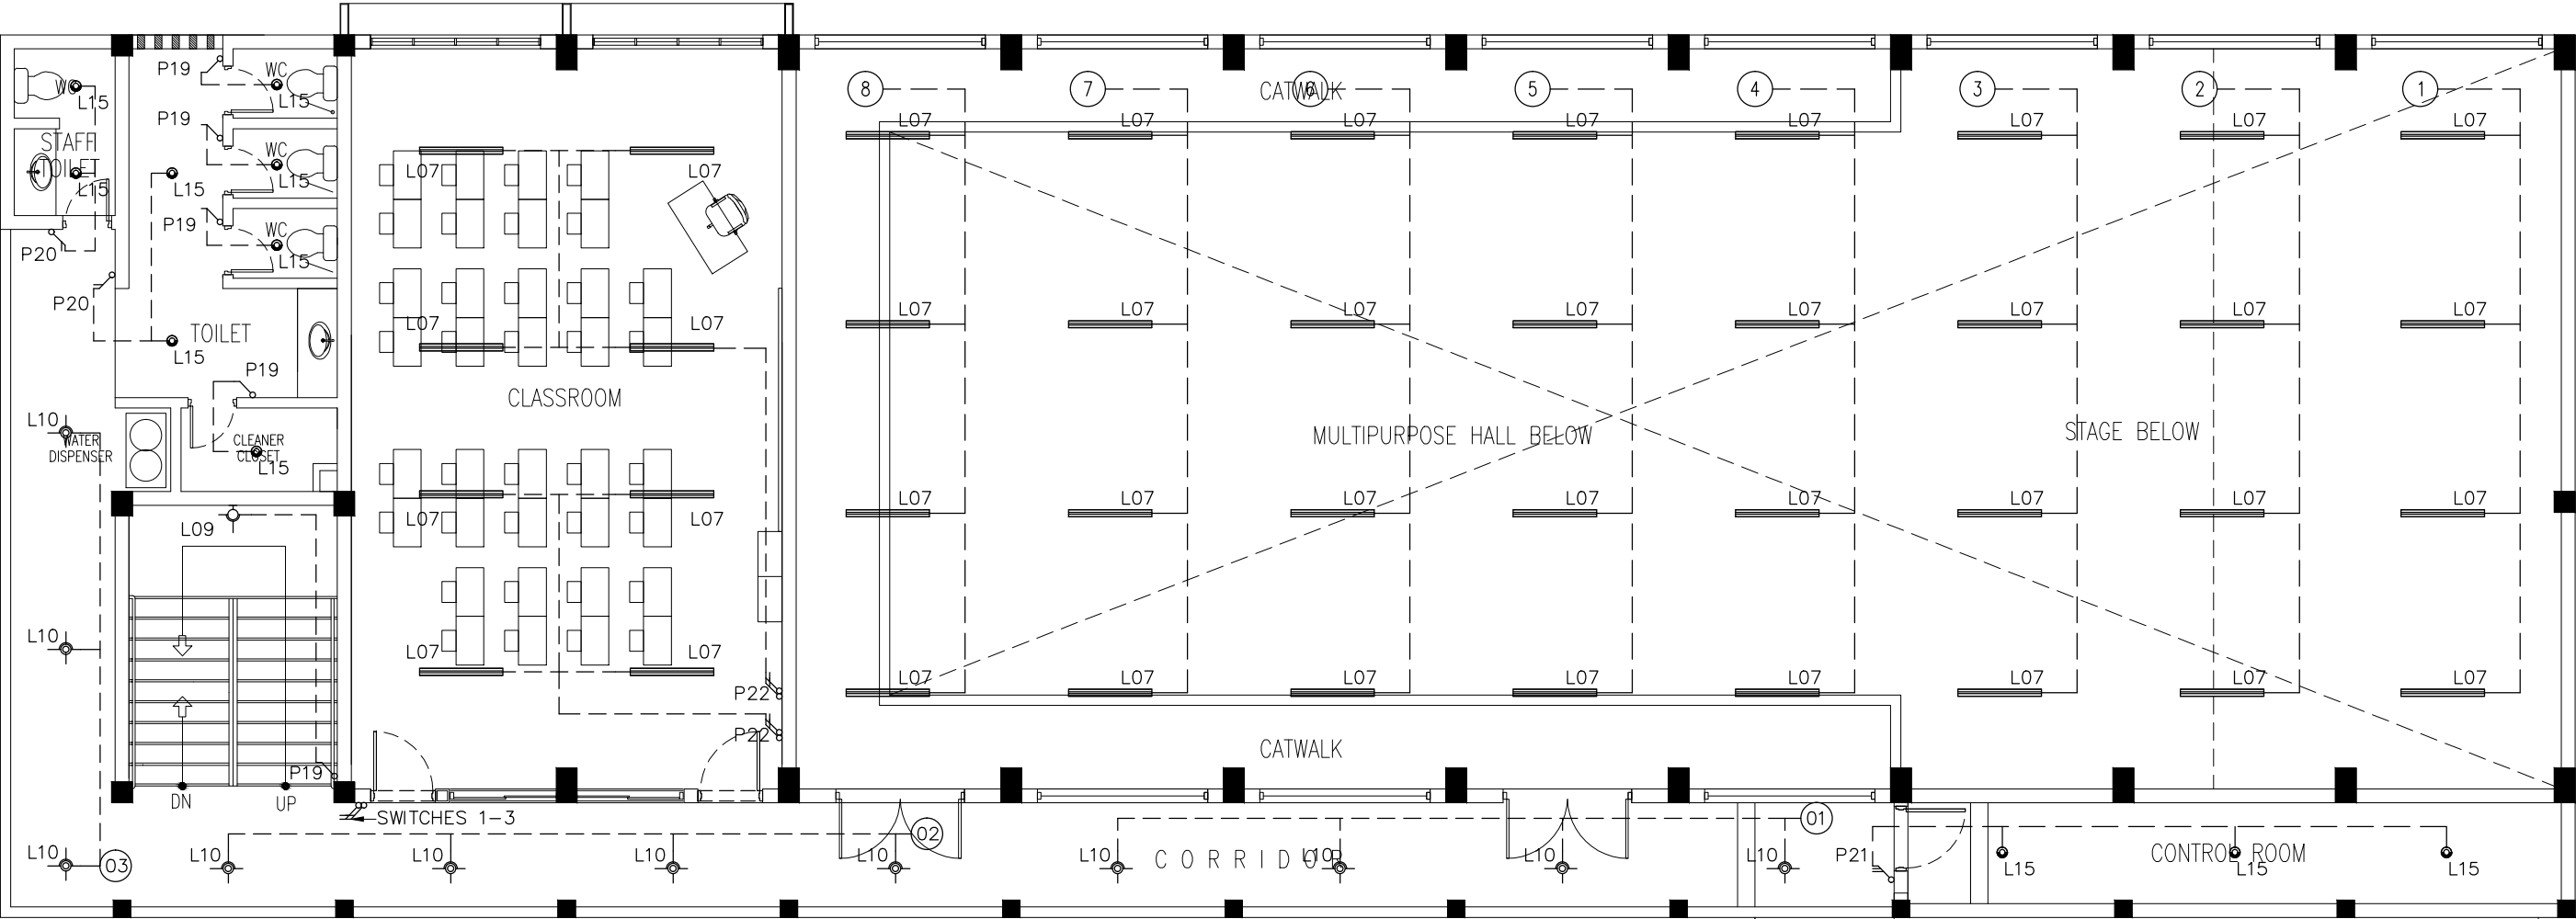

LEGEND

SYMBOL	CODE	DESCRIPTION
	L07	2X36W FLUORESCENT LAMPS IN SURFACE MOUNT LUMINAIRE WITH DIFFUSER
	L09	WALL MOUNT ENERGY SAVING LIGHT
	L10	1X26W COMPACT FLUORESCENT LAMPS IN RECESSED DECORATIVE LUMINAIRE
	L15	1X60W INCANDESCENT LAMPS IN RECESSED DECORATIVE LUMINAIRE
	L17	1X60W INCANDESCENT LAMPS IN SURFACE MOUNT WEATHER PROOF LUMINAIRE

	P19	1GANG 1 WAY SWITCH
	P20	2GANG 1 WAY SWITCH
	P21	3GANG 1 WAY SWITCH
	P22	4GANG 1 WAY SWITCH

1ST FLOOR LIGHTING PLAN  
SCALE 1:100

CONTRACTORS MUST  
CHECK ALL  
DIMENSIONS ON SITE  
BEFORE STARTING  
ANY WORK OR SHOP  
DRAWINGS. FIGURED  
DIMENSIONS TO TAKE  
PRECEDENCE OVER  
SCALE READINGS




REVISION:	

ARCHITECT:	MOHAMED HAMEEN
ENGINEER:	MOHAMED AHSAN
SERVICES ENG:	
ESTIMATOR:	
DRAWN BY:	

PROJECT:	6 CLASSROOM BLOCK, MULTI PURPOSE HALL BLOCK IN MEYNAA SCHOOL
LOCATION:	HA.HOLHUDHOO
DRAWING TITLE:	AS GIVEN
CLIENT:	MINISTRY OF EDUCATION
SCALE:	AS GIVEN
DIMENSION:	MM
DATE:	AUGUST 2015

E-02  
DWG NO  
PROJECT NO.: 14-124

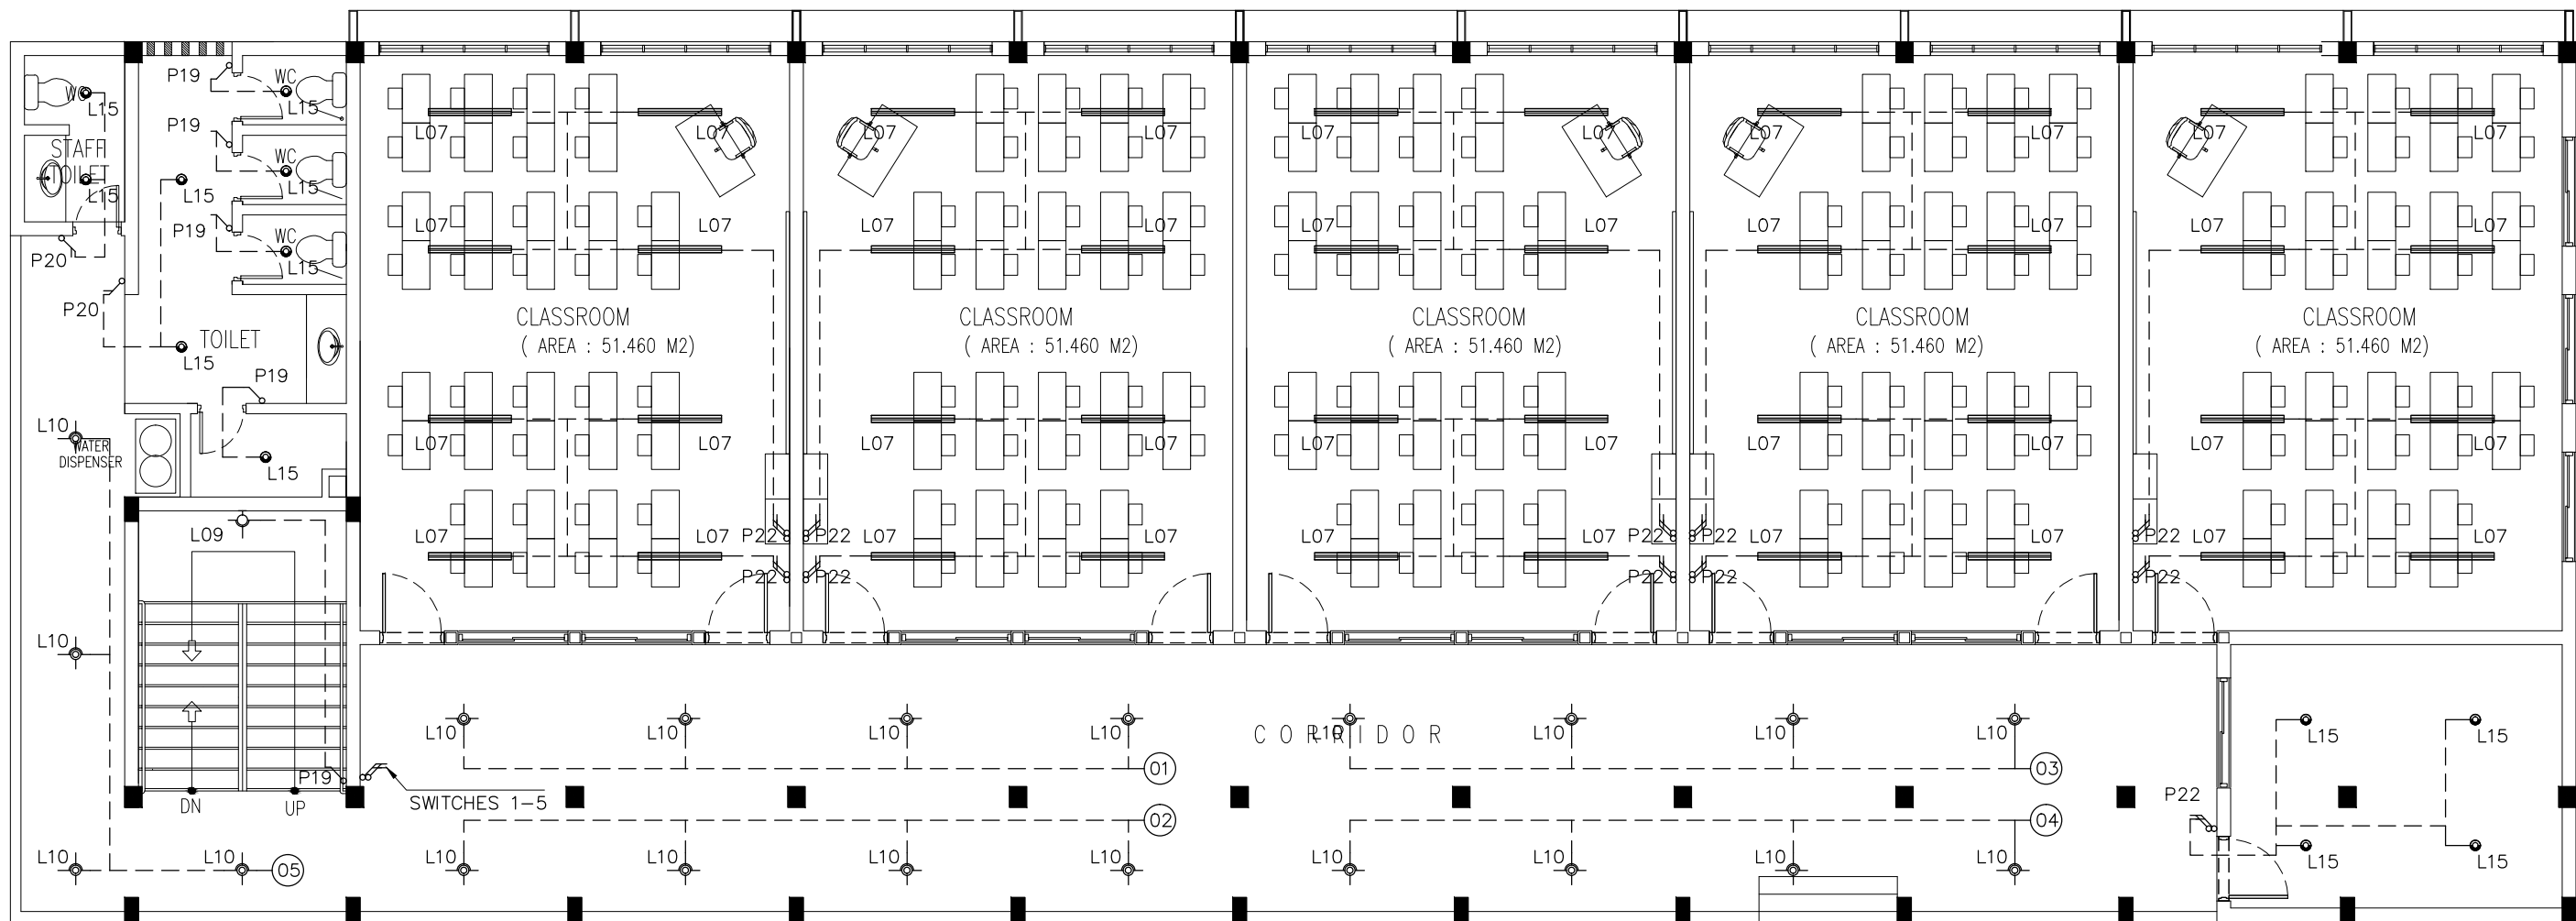

LEGEND

SYMBOL	CODE	DESCRIPTION
	L07	2X36W FLUORESCENT LAMPS IN SURFACE MOUNT LUMINAIRE WITH DIFFUSER
	L09	WALL MOUNT ENERGY SAVING LIGHT
	L10	1X26W COMPACT FLUORESCENT LAMPS IN RECESSED DECORATIVE LUMINAIRE
	L15	1X60W INCANDESCENT LAMPS IN RECESSED DECORATIVE LUMINAIRE
	L17	1X60W INCANDESCENT LAMPS IN SURFACE MOUNT WEATHER PROOF LUMINAIRE

	P19	1GANG 1 WAY SWITCH
	P20	2GANG 1 WAY SWITCH
	P21	3GANG 1 WAY SWITCH
	P22	4GANG 1 WAY SWITCH


2ND FLOOR LIGHTING PLAN  
SCALE 1:100

CONTRACTORS MUST  
CHECK ALL  
DIMENSIONS ON SITE  
BEFORE STARTING  
ANY WORK OR SHOP  
DRAWINGS. FIGURED  
DIMENSIONS TO TAKE  
PRECEDENCE OVER  
SCALE READINGS



REVISION:	ARCHITECT: MOHAMED HAMEEN	PROJECT: 6 CLASSROOM BLOCK, MULTI PURPOSE HALL BLOCK IN MEYNAA SCHOOL	E-03 DWG NO PROJECT NO.: 14-124
	ENGINEER: MOHAMED AHSAN	LOCATION: HA, HOLHUDHOO	
	SERVICES ENG:	DRAWING TITLE: AS GIVEN	
	ESTIMATOR:	CLIENT: MINISTRY OF EDUCATION	
	DRAWN BY:	SCALE: AS GIVEN    DIMENSION: MM    DATE: AUJUGST 2015	
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LEGEND

SYMBOL	CODE	DESCRIPTION
	P01	1 GANG13A SOCKET OUTLET AT 300mm ABOVE FINISHED FLOOR LEVEL
	P02	2 GANG13A SOCKET OUTLET AT 300mm ABOVE FINISHED FLOOR LEVEL
	P15	1 GANG15A SOCKET OUTLET AT CEILING LEVEL
	P16	1 GANG13A SOCKET OUTLET AT CEILING LEVEL
	VGA01	VGA CABLE
	VGA02	VGA CABLE AT CEILING LEVEL

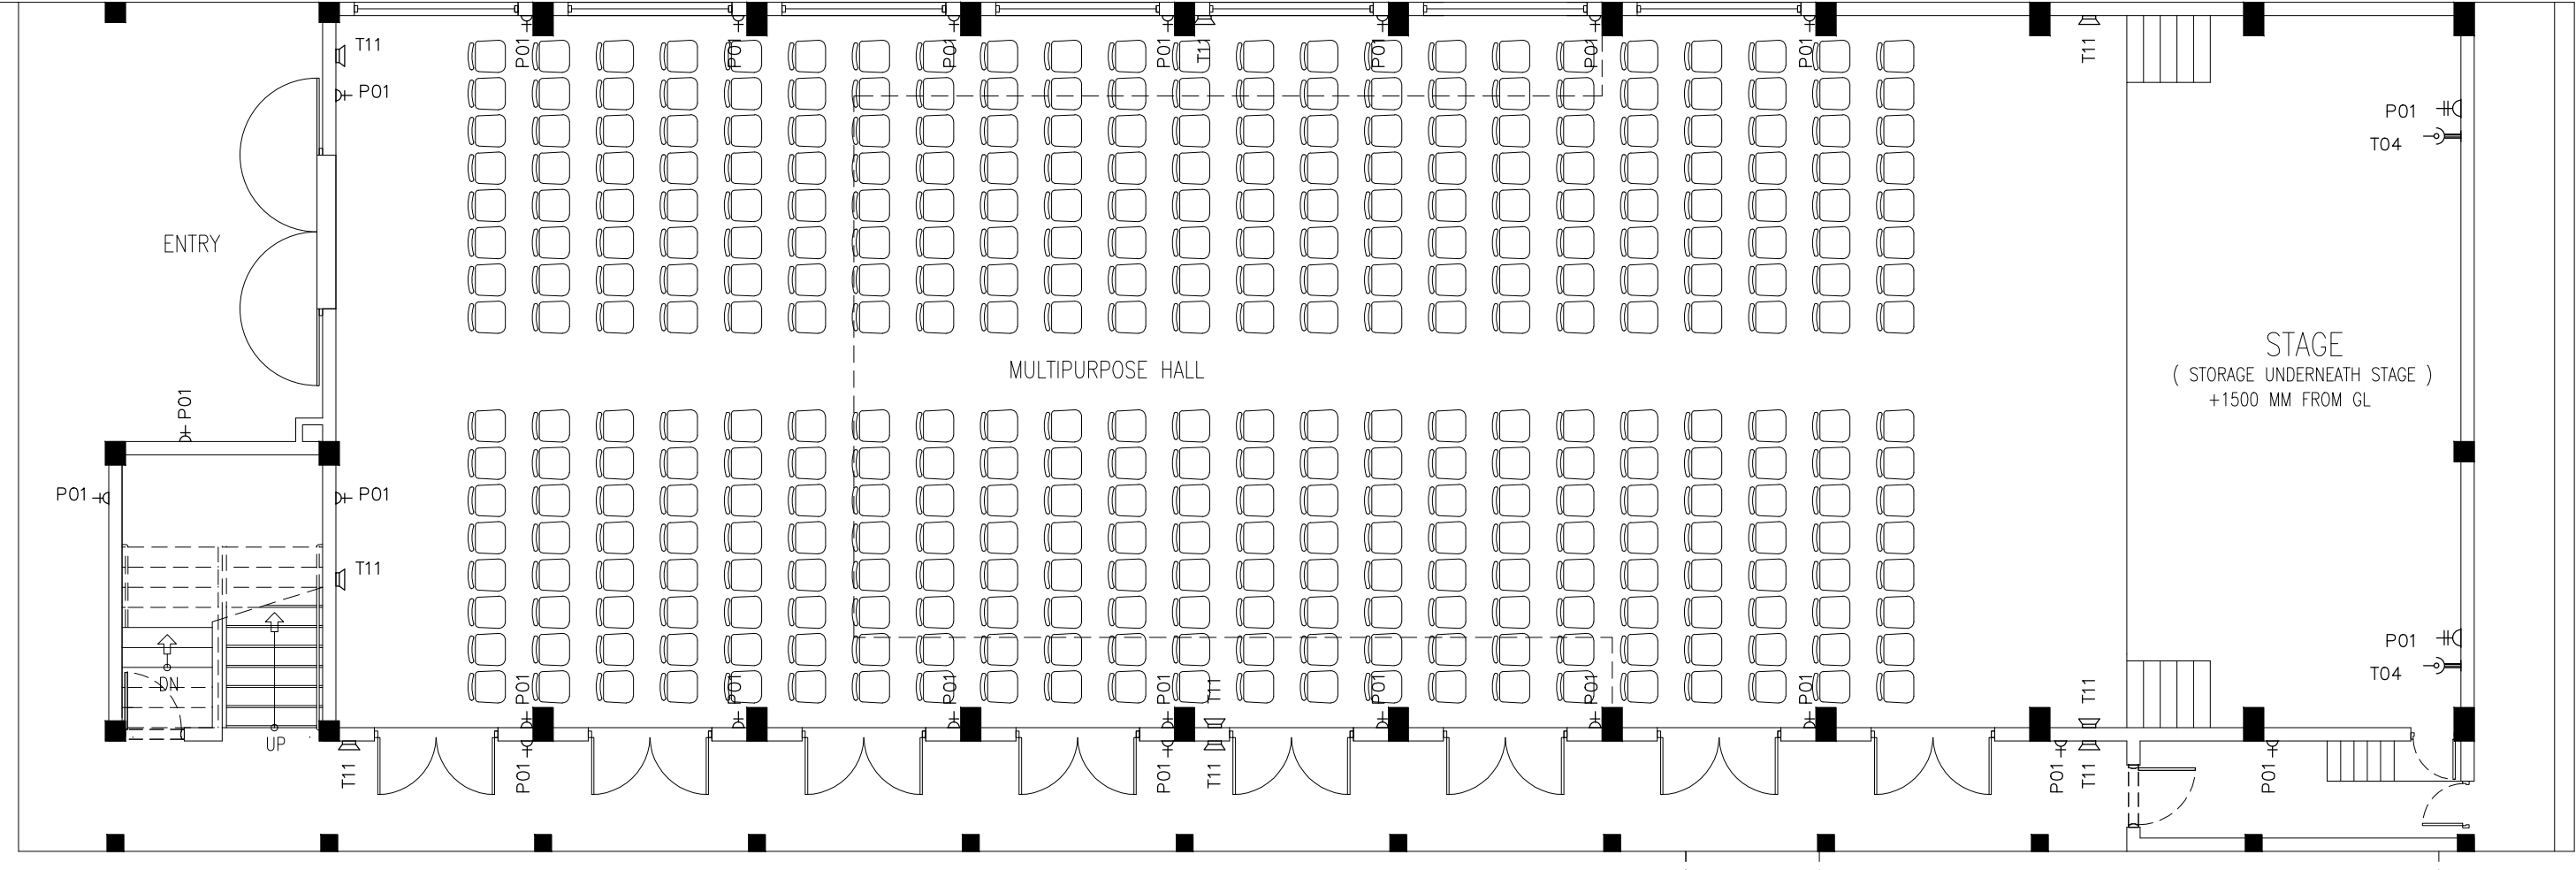LEGEND

SYMBOL	CODE	DESCRIPTION
	T01	PLAIN TELEPHONE OUTLET
	T02	COMPUTER NETWORK OUTLET
	MP01	MULTIMEDIA PROJECTOR
	T10	T.V POINT
	T11	SPEAKER

GROUND FLOOR  
POWER/SOCKET PLAN  
SCALE 1:100

CONTRACTORS MUST  
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DIMENSIONS ON SITE  
BEFORE STARTING  
ANY WORK OR SHOP  
DRAWINGS, FIGURED  
DIMENSIONS TO TAKE  
PRECEDENCE OVER  
SCALE READINGS



REVISION:


ARCHITECT: MOHAMED HAMEEN

ENGINEER: MOHAMED AHSAN

SERVICES ENG:

ESTIMATOR:

DRAWN BY:

PROJECT: 6 CLASSROOM BLOCK, MULTI PURPOSE HALL BLOCK IN MEYNAA SCHOOL

LOCATION: HA, HOLHUDHOO

DRAWING TITLE: AS GIVEN

CLIENT: MINISTRY OF EDUCATION

SCALE: AS GIVEN

DIMENSION: MM


DATE: AUJUGST 2015

E-04

DWG NO

PROJECT NO.: 14-124

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LEGEND

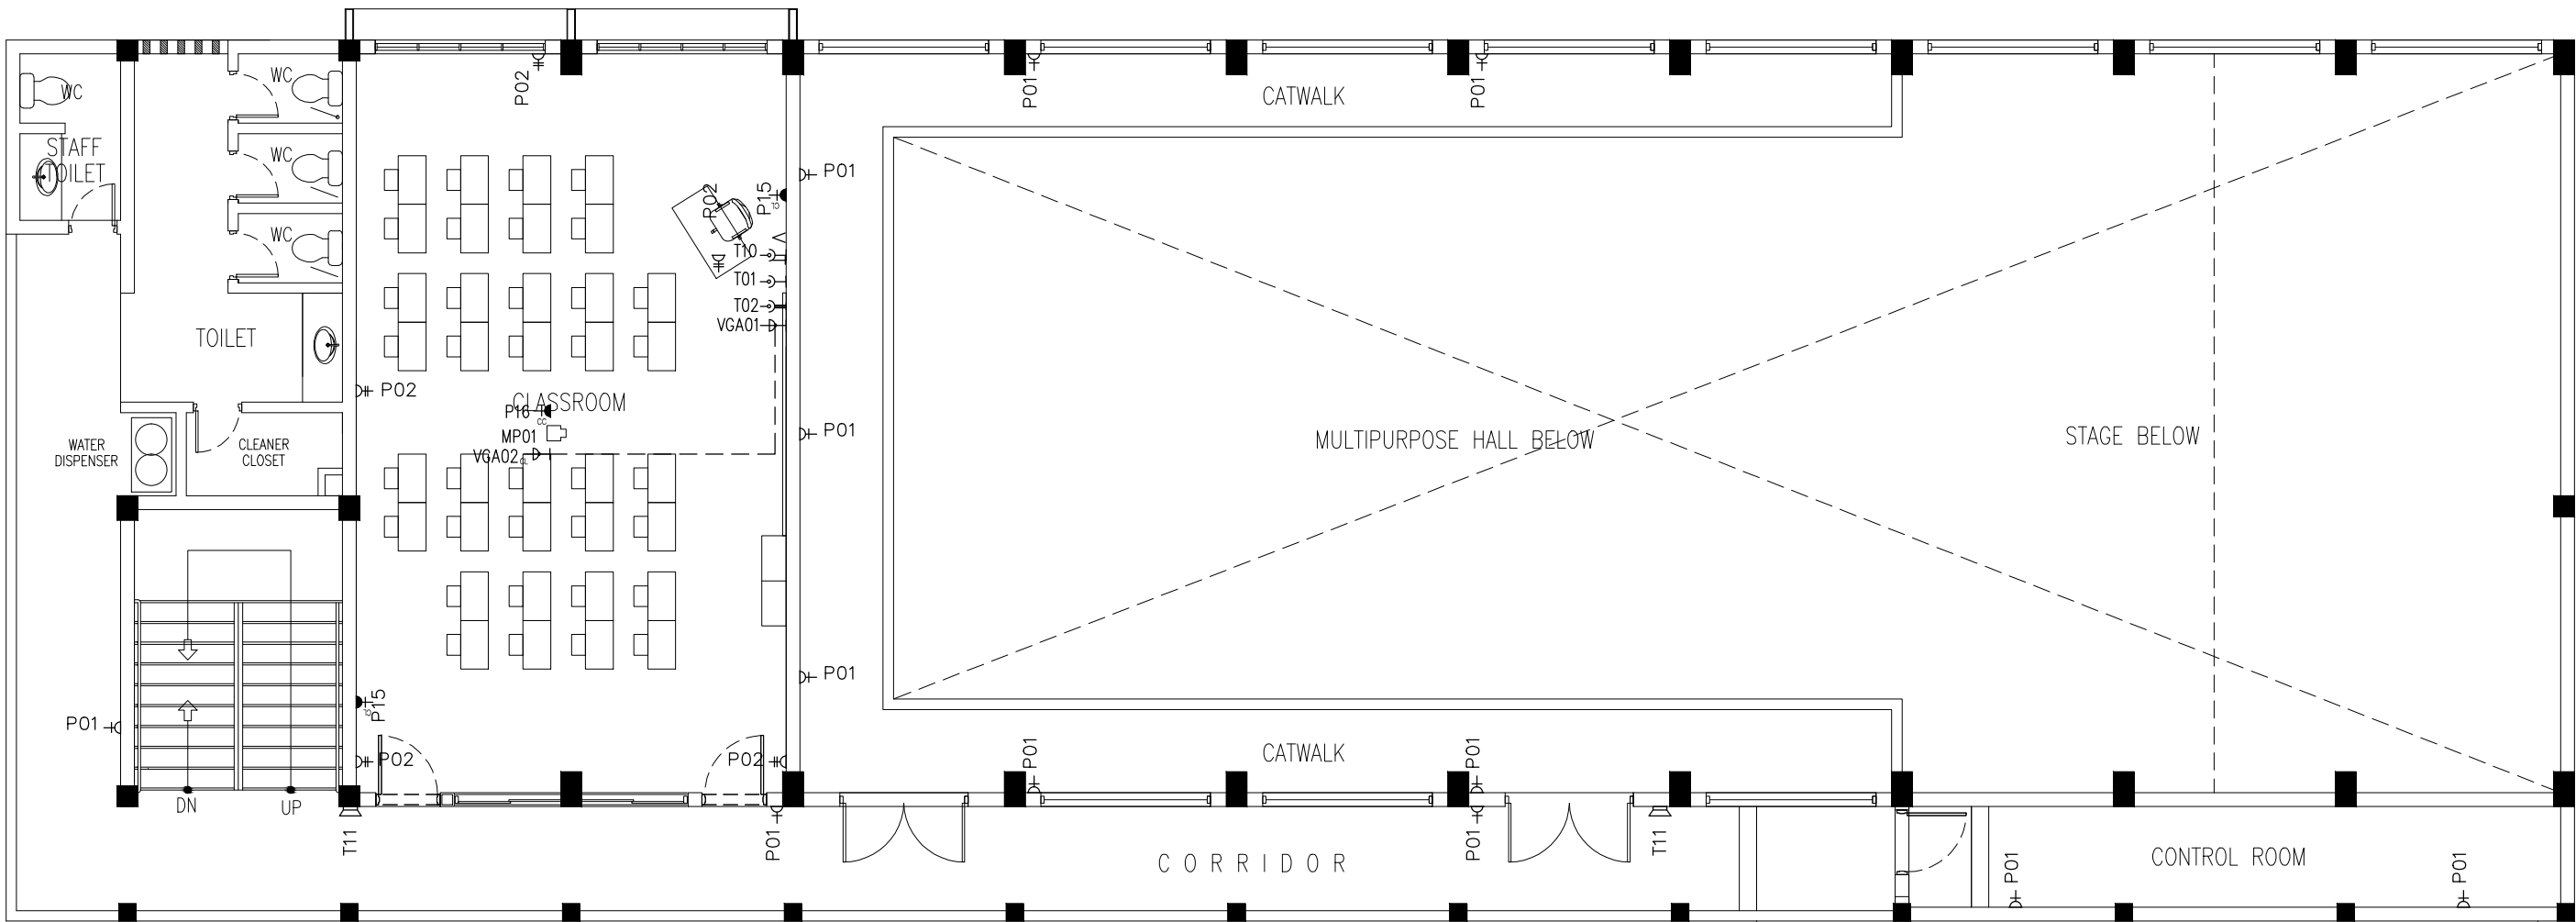SYMBOL	CODE	DESCRIPTION
	P01	1 GANG13A SOCKET OUTLET AT 300mm ABOVE FINISHED FLOOR LEVEL
	P02	2 GANG13A SOCKET OUTLET AT 300mm ABOVE FINISHED FLOOR LEVEL
	P15	1 GANG15A SOCKET OUTLET AT CEILING LEVEL
	P16	1 GANG13A SOCKET OUTLET AT CEILING LEVEL
	VGA01	VGA CABLE
	VGA02	VGA CABLE AT CEILING LEVEL

LEGEND

SYMBOL	CODE	DESCRIPTION
	T01	PLAIN TELEPHONE OUTLET
	T02	COMPUTER NETWORK OUTLET
	MP01	MULTIMEDIA PROJECTOR
	T10	T.V POINT
	T11	SPEAKER

CONTRACTORS MUST  
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DIMENSIONS TO TAKE  
PRECEDENCE OVER  
SCALE READINGS



REVISION:	


ARCHITECT:	MOHAMED HAMEEN
ENGINEER:	MOHAMED AHSAN
SERVICES ENG:	
ESTIMATOR:	
DRAWN BY:	

PROJECT:	6 CLASSROOM BLOCK, MULTI PURPOSE HALL BLOCK IN MEYNAA SCHOOL
LOCATION:	HA,HOLHUDDHOO
DRAWING TITLE:	AS GIVEN
CLIENT:	MINISTRY OF EDUCATION
SCALE:	AS GIVEN
DIMENSION:	MM
DATE:	AUJUST 2015

E-05
DWG NO
PROJECT NO.: 14-124

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1ST FLOOR POWER/SOCKET PLAN  
SCALE 1:100

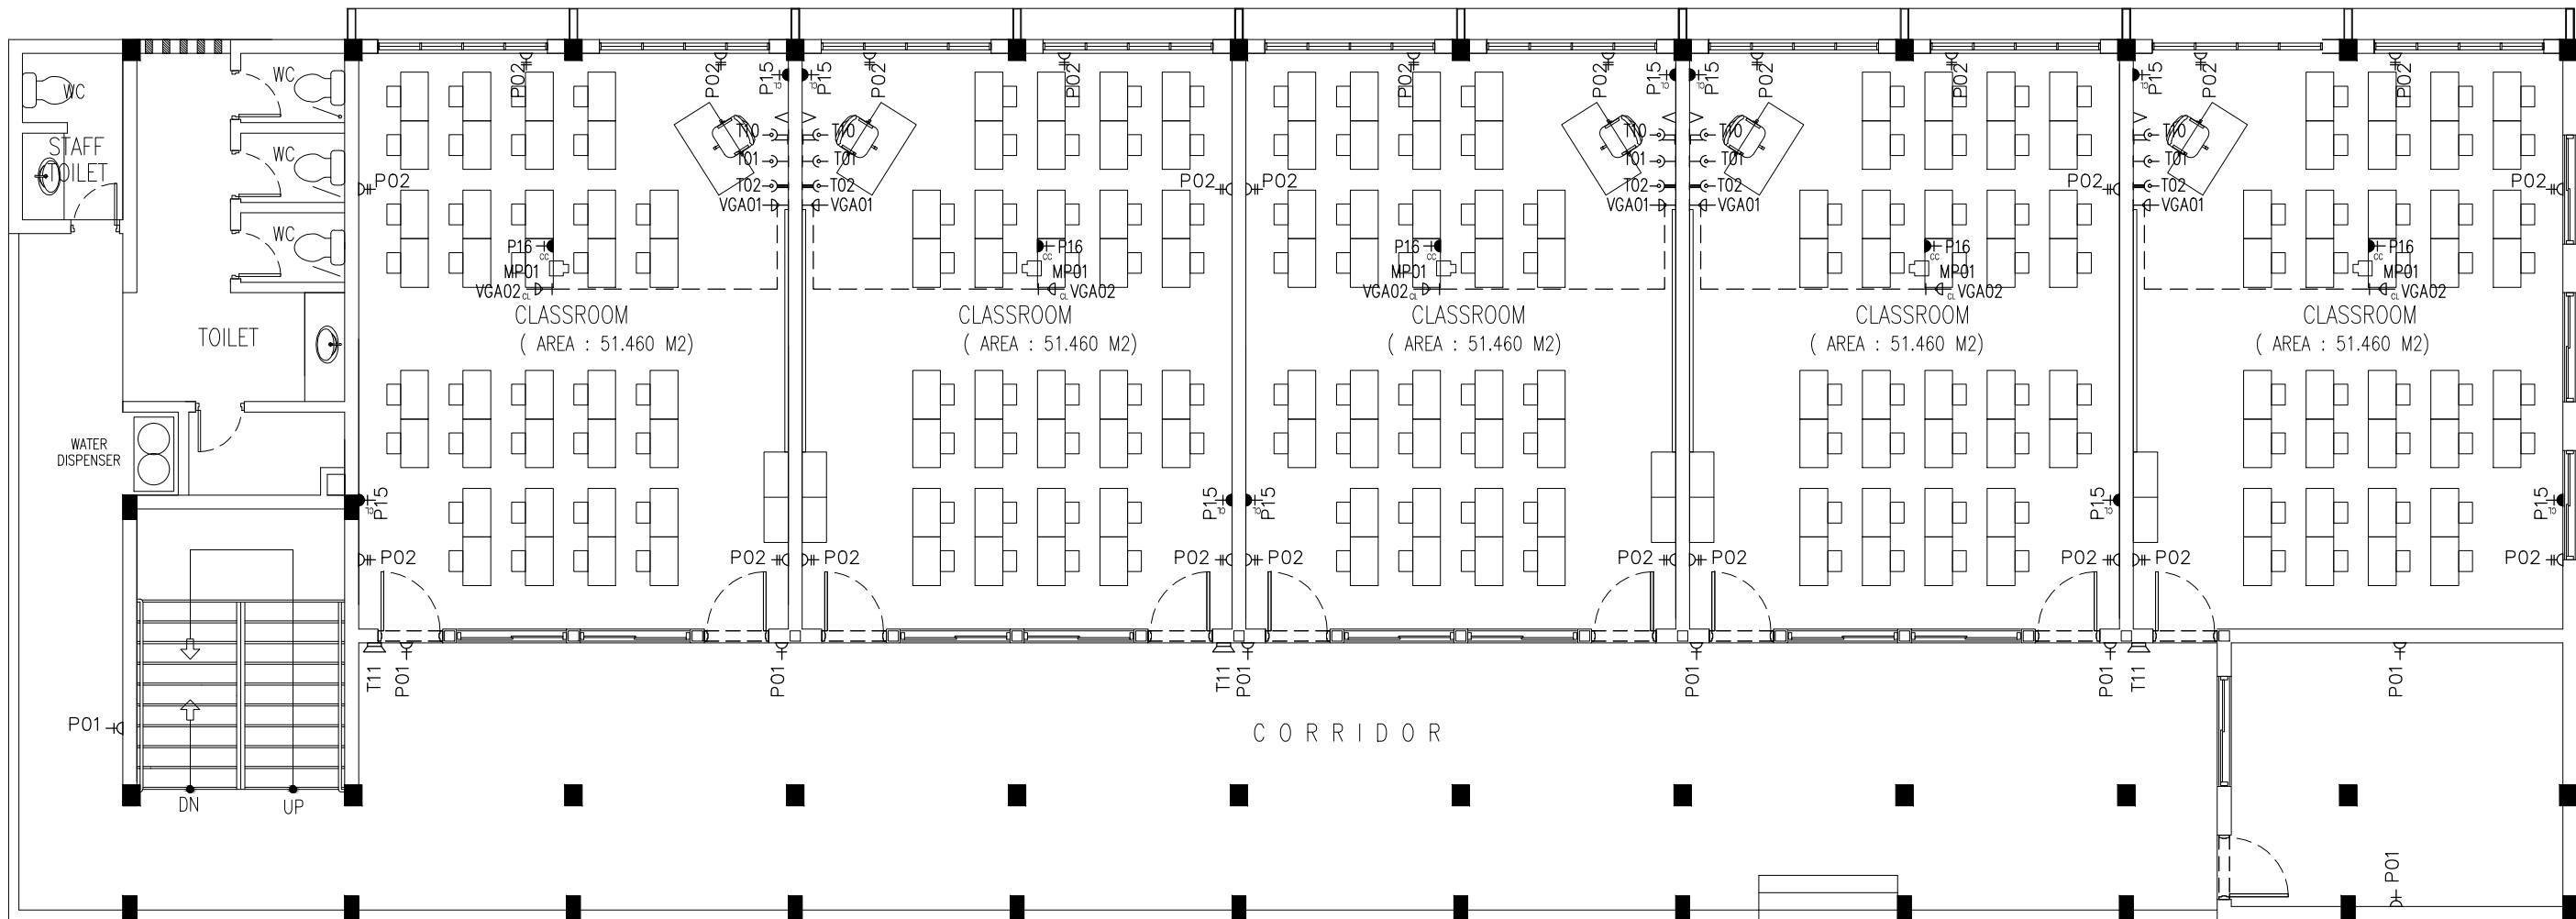

LEGEND

SYMBOL	CODE	DESCRIPTION
	P01	1 GANG13A SOCKET OUTLET AT 300mm ABOVE FINISHED FLOOR LEVEL
	P02	2 GANG13A SOCKET OUTLET AT 300mm ABOVE FINISHED FLOOR LEVEL
	P15	1 GANG15A SOCKET OUTLET AT CEILING LEVEL
	P16	1 GANG13A SOCKET OUTLET AT CEILING LEVEL
	VGA01	VGA CABLE
	VGA02	VGA CABLE AT CEILING LEVEL

LEGEND

SYMBOL	CODE	DESCRIPTION
	T01	PLAIN TELEPHONE OUTLET
	T02	COMPUTER NETWORK OUTLET
	MP01	MULTIMEDIA PROJECTOR
	T10	T.V POINT
	T11	SPEAKER

2ND FLOOR POWER/SOCKET PLAN  
SCALE 1:100

CONTRACTORS MUST  
CHECK ALL  
DIMENSIONS ON SITE  
BEFORE STARTING  
ANY WORK OR SHOP  
DRAWINGS. FIGURED  
DIMENSIONS TO TAKE  
PRECEDENCE OVER  
SCALE READINGS



REVISION:	

ARCHITECT:	MOHAMED HAMEEN
ENGINEER:	MOHAMED AHSAN
SERVICES ENG:	
ESTIMATOR:	
DRAWN BY:	


PROJECT:	6 CLASSROOM BLOCK, MULTI PURPOSE HALL BLOCK IN MEYNAA SCHOOL
LOCATION:	HAJOLHUDHOO
DRAWING TITLE:	AS GIVEN
CLIENT:	MINISTRY OF EDUCATION
SCALE:	AS GIVEN
DIMENSION:	MM
DATE:	AUGUST 2015

E-06



DWG NO  
PROJECT NO.: 14-124

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LEGEND

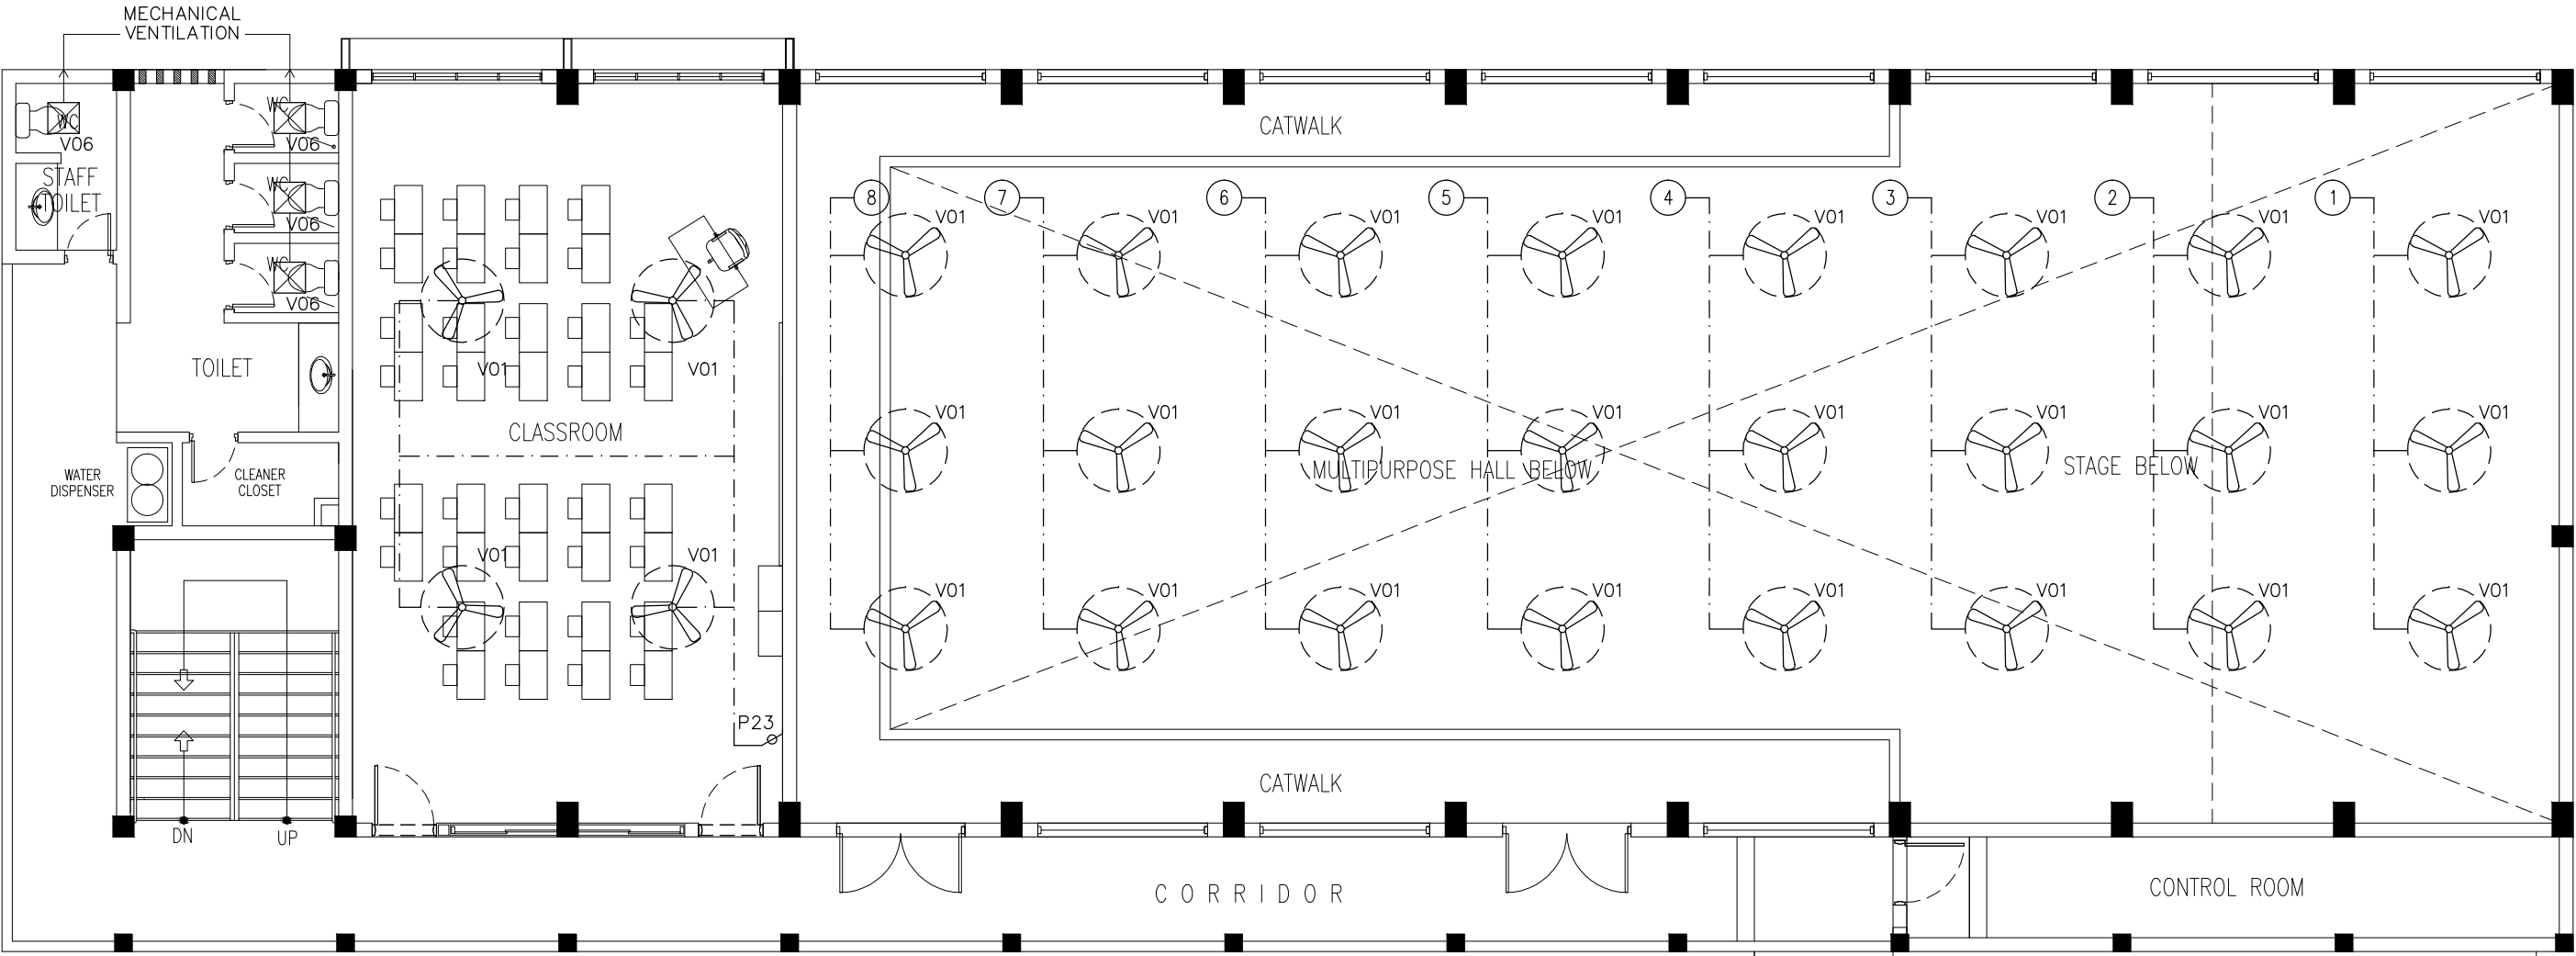
⌀	P23	FAN / LIGHT DIMMER SWITCH
	V01b	DIA. 1200 CEILING FAN
	V06	EXHAUST

1ST FLOOR FAN LAYOUT PLAN  
SCALE 1:100

CONTRACTORS MUST  
CHECK ALL  
DIMENSIONS ON SITE  
BEFORE STARTING  
ANY WORK OR SHOP  
DRAWINGS FIGURED  
DIMENSIONS TO TAKE  
PRECEDENCE OVER  
SCALE READINGS



REVISION:	ARCHITECT: MOHAMED HAMEEN	PROJECT: 6 CLASSROOM BLOCK, MULTI PURPOSE HALL BLOCK IN MEYNAA SCHOOL	E-08
	ENGINEER: MOHAMED AHSAN	LOCATION: HA.HOLHUDHOO	
	SERVICES ENG:	DRAWING TITLE: AS GIVEN	
	ESTIMATOR:	CLIENT: MINISTRY OF EDUCATION	
	DRAWN BY:	SCALE: AS GIVEN DIMENSION: MM DATE: AUJULY 2015	
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LEGEND

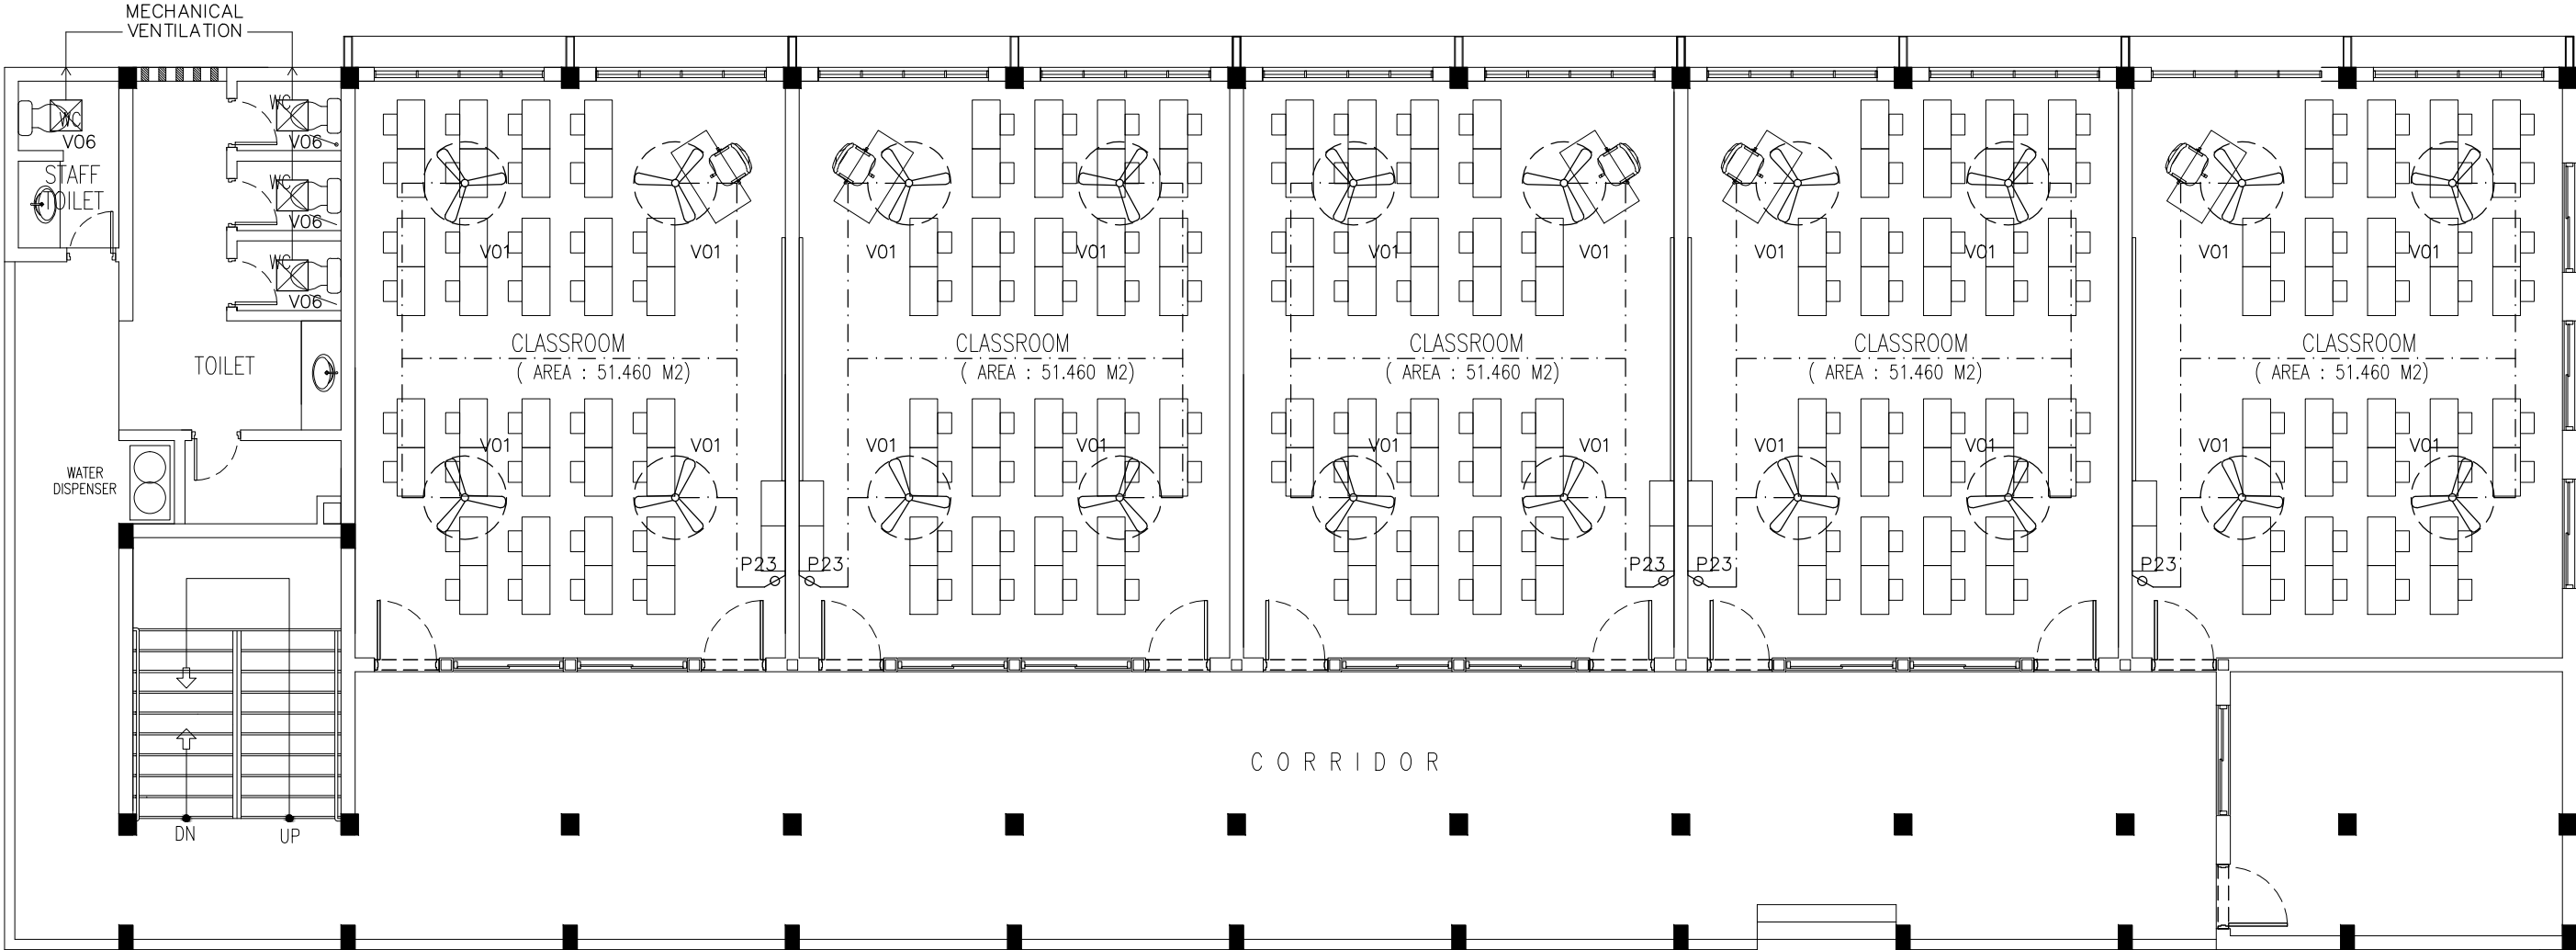	P23	FAN / LIGHT DIMMER SWITCH
	V01b	DIA. 1200 CEILING FAN
	V06	EXHAUST


2ND FLOOR FAN LAYOUT PLAN  
SCALE 1:100

CONTRACTORS MUST  
CHECK ALL  
DIMENSIONS ON SITE  
BEFORE STARTING  
ANY WORK OR SHOP  
DRAWINGS, FIGURED  
DIMENSIONS TO TAKE  
PRECEDENCE OVER  
SCALE READINGS



REVISION:	ARCHITECT:	MOHAMED HAMEEN	PROJECT:	6 CLASSROOM BLOCK, MULTI PURPOSE HALL BLOCK IN MEYNAA SCHOOL			E-09	
	ENGINEER:	MOHAMED AHSAN	LOCATION:	HA,HOLHUDHOO				
	SERVICES ENG:		DRAWING TITLE:	AS GIVEN				
	ESTIMATOR:		CLIENT:	MINISTRY OF EDUCATION				
	DRAWN BY:		SCALE:	AS GIVEN	DIMENSION:	MM		DATE:
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								PROJECT NO.: 14-124

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ø1.8M SOAP PIT TANK

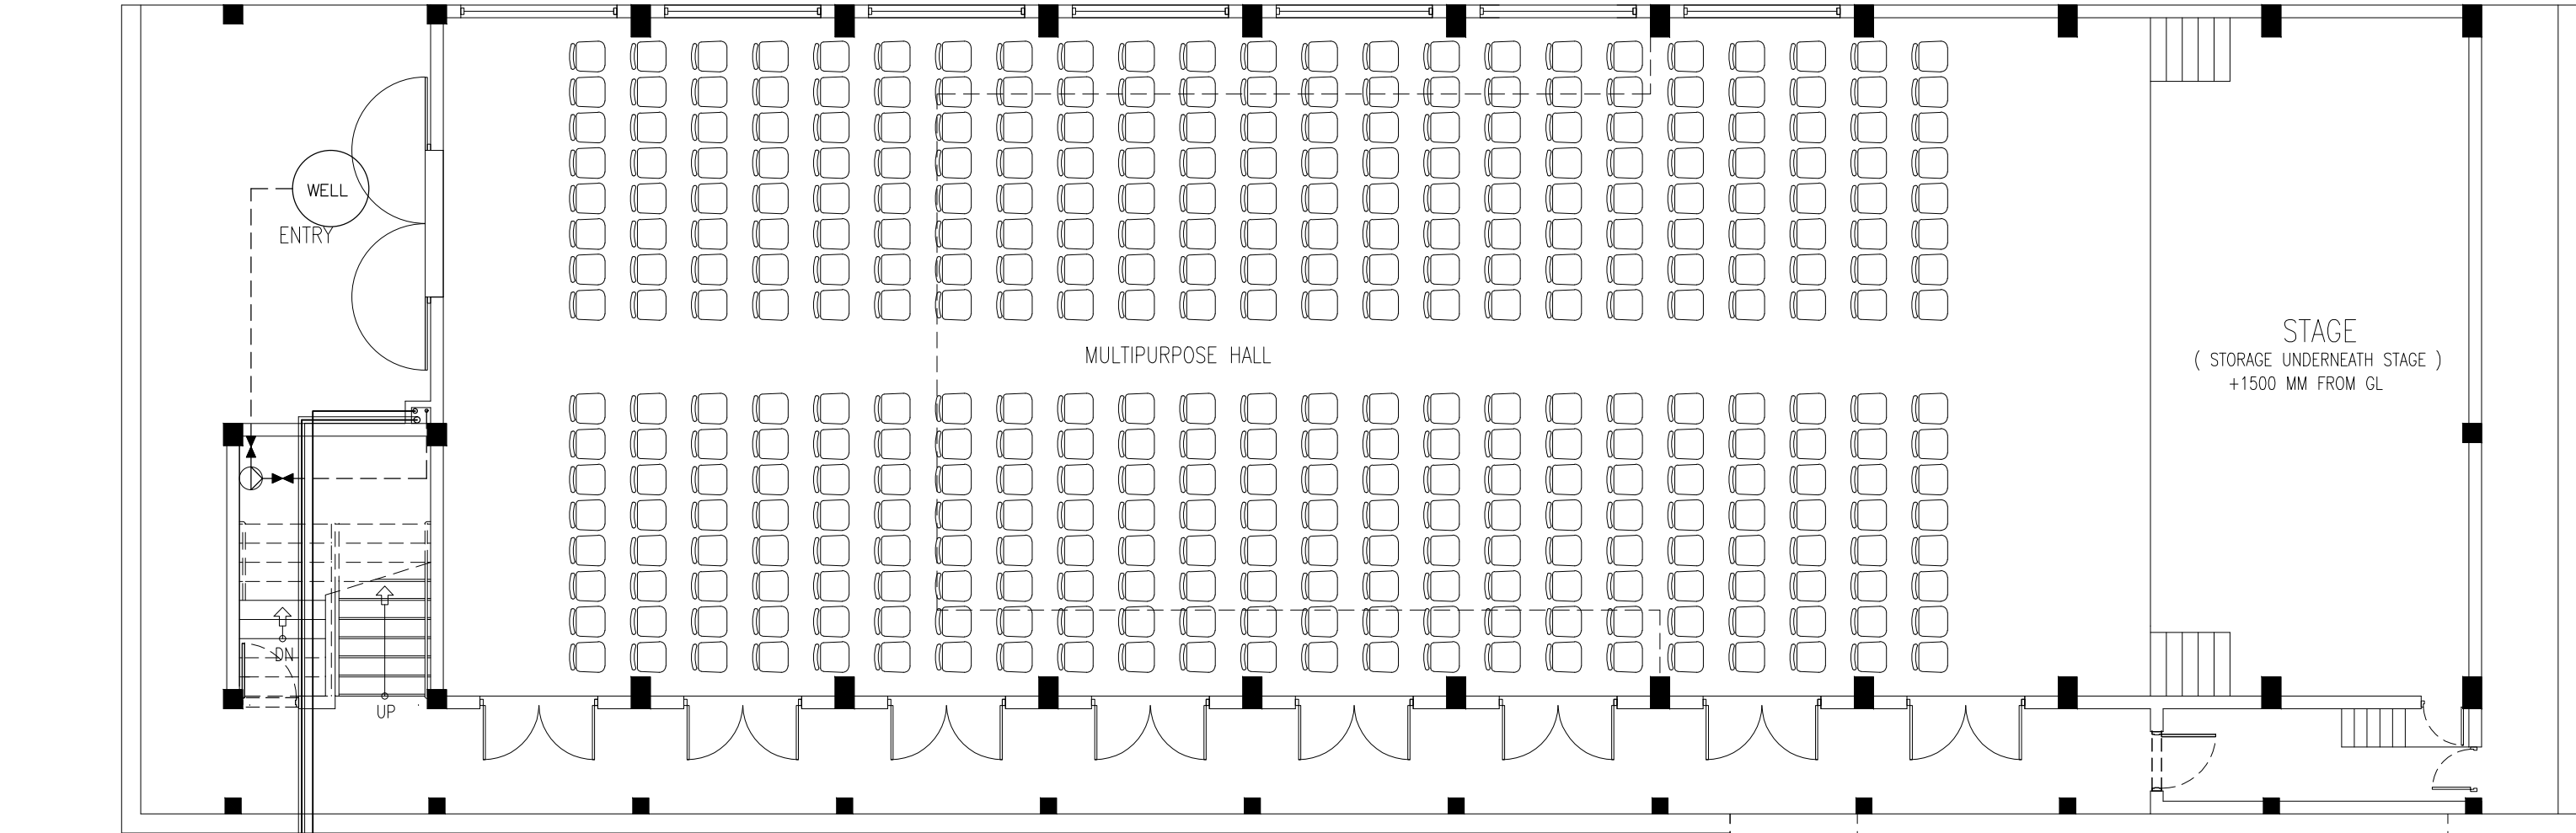NOTE: TO BE DETERMINED ON SITE

LEGEND	
SYMBOL	DESCRIPTION
	TAP
	MUSLIM SHOWER
	WELL WATER SUPPLY (ø12–ø35)
	FLOOR DRAIN
	UPVC HIGH PRESSURE WASTE WATER PIPE (ø75–ø100)
	SEWAGE DISPOSAL (ø100)
	INSPECTION CHAMBER

FRESH WATER AND SEWAGE  
DISPOSAL PLAN


SCALE 1:100

CONTRACTORS MUST  
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ANY WORK OR SHOP  
DRAWINGS.FIGURED  
DIMENSIONS TO TAKE  
PRECEDENCE OVER  
SCALE READINGS



REVISION:	ARCHITECT:	MOHAMED HAMEEN	PROJECT:	6 CLASSROOM BLOCK, MULTI PURPOSE HALL BLOCK IN MEYNAA SCHOOL			P-01		
	ENGINEER:	MOHAMED AHSAN	LOCATION:	HA.HOLHUDHOO					
	SERVICES ENG:		DRAWING TITLE:	AS GIVEN					
	ESTIMATOR:		CLIENT:	MINISTRY OF EDUCATION					
	DRAWN BY:		SCALE:	AS GIVEN	DIMENSION:	MM	DATE:	AUJUGST 2015	DWG NO
CONCEPT AND DESIGN IN THIS DRAWING ARE THE PROPERTIES OF ARCHENO STUDIO PVT LTD. UNAUTHORIZED USE OR REPRODUCTION OF PART OF THE DESIGN, DRAWINGS OR CONCEPT TO USE IN OTHER PROJECTS OR SITES OTHER THAN SPECIFIED ON THIS DRAWING IS PROHIBITED									
PROJECT NO.: 14-124									

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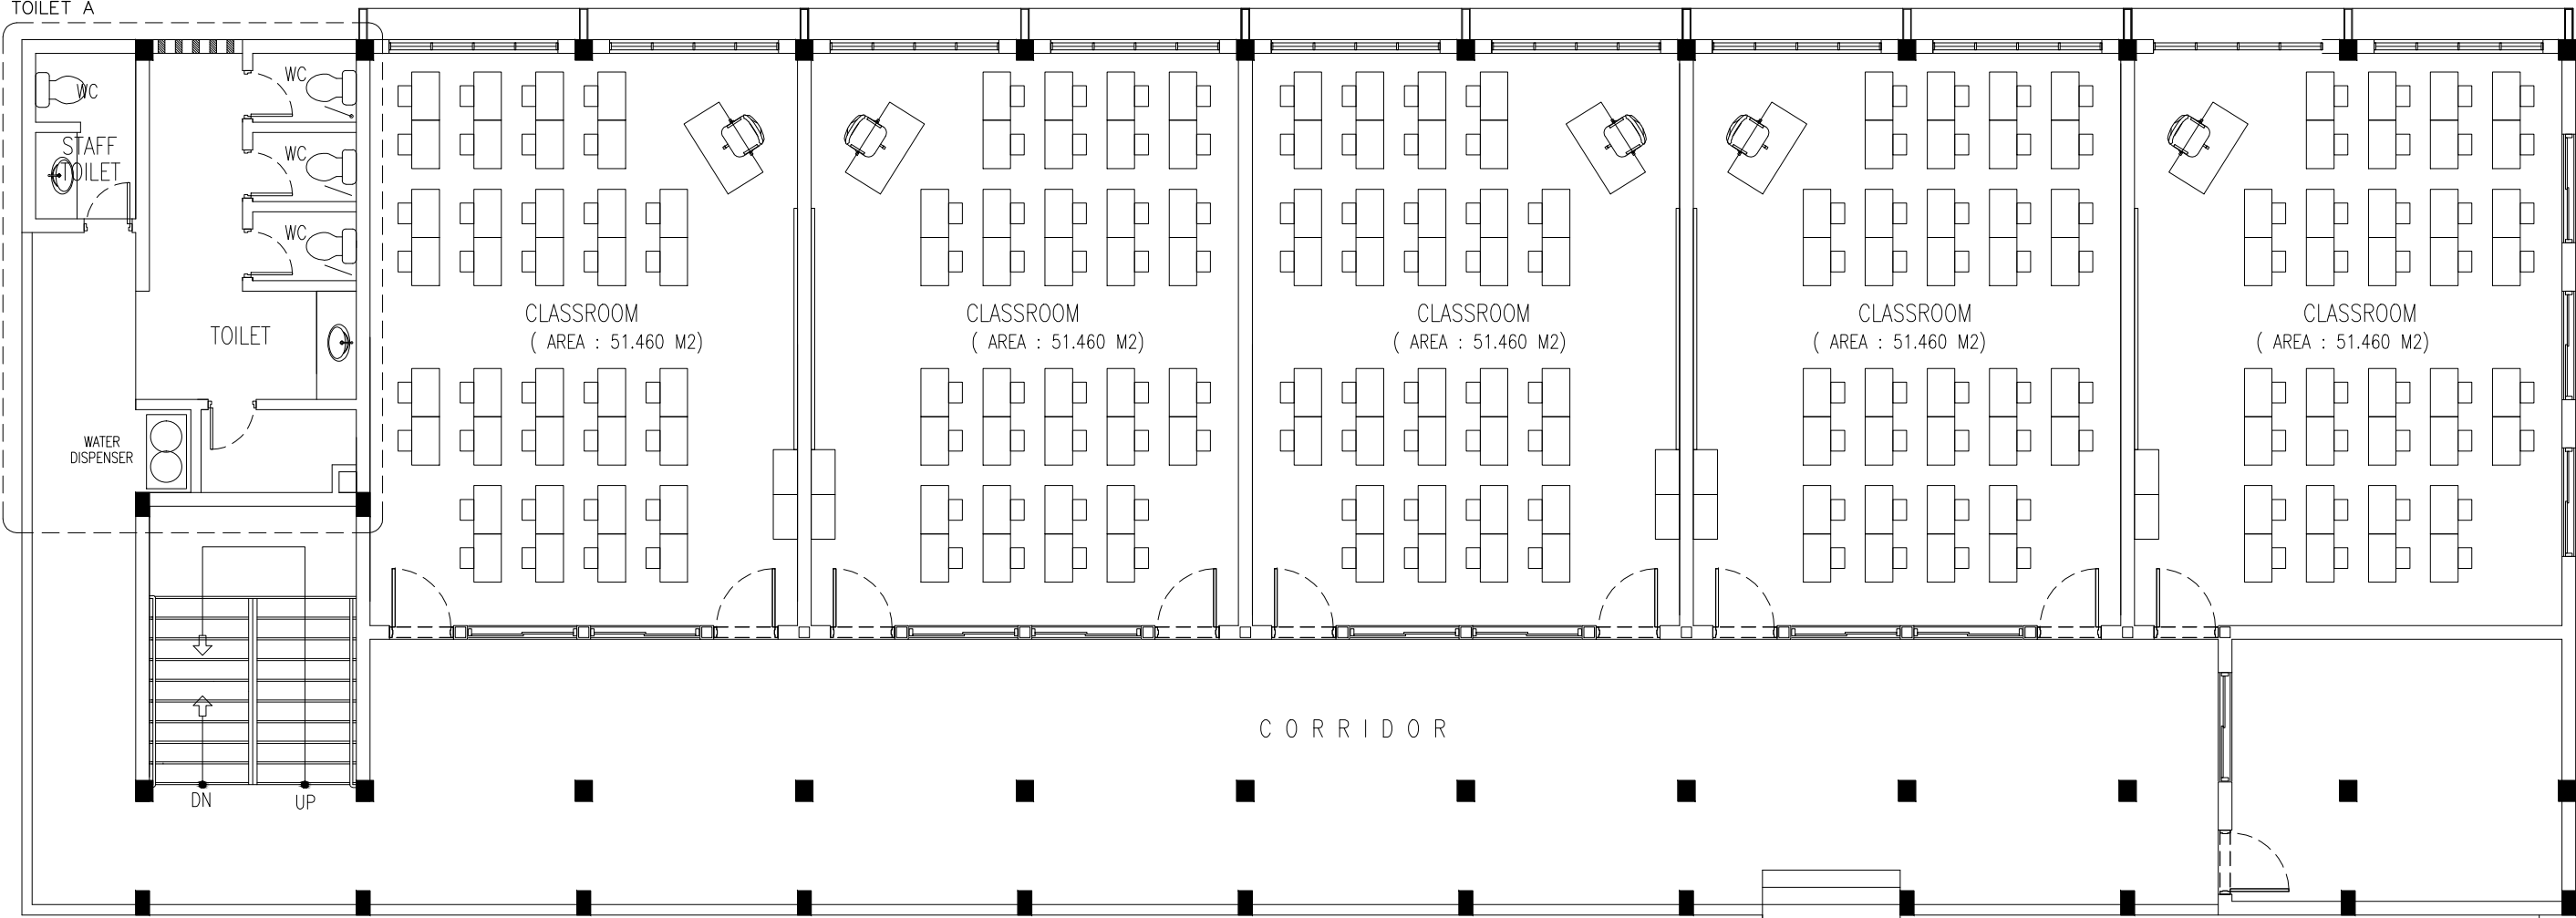


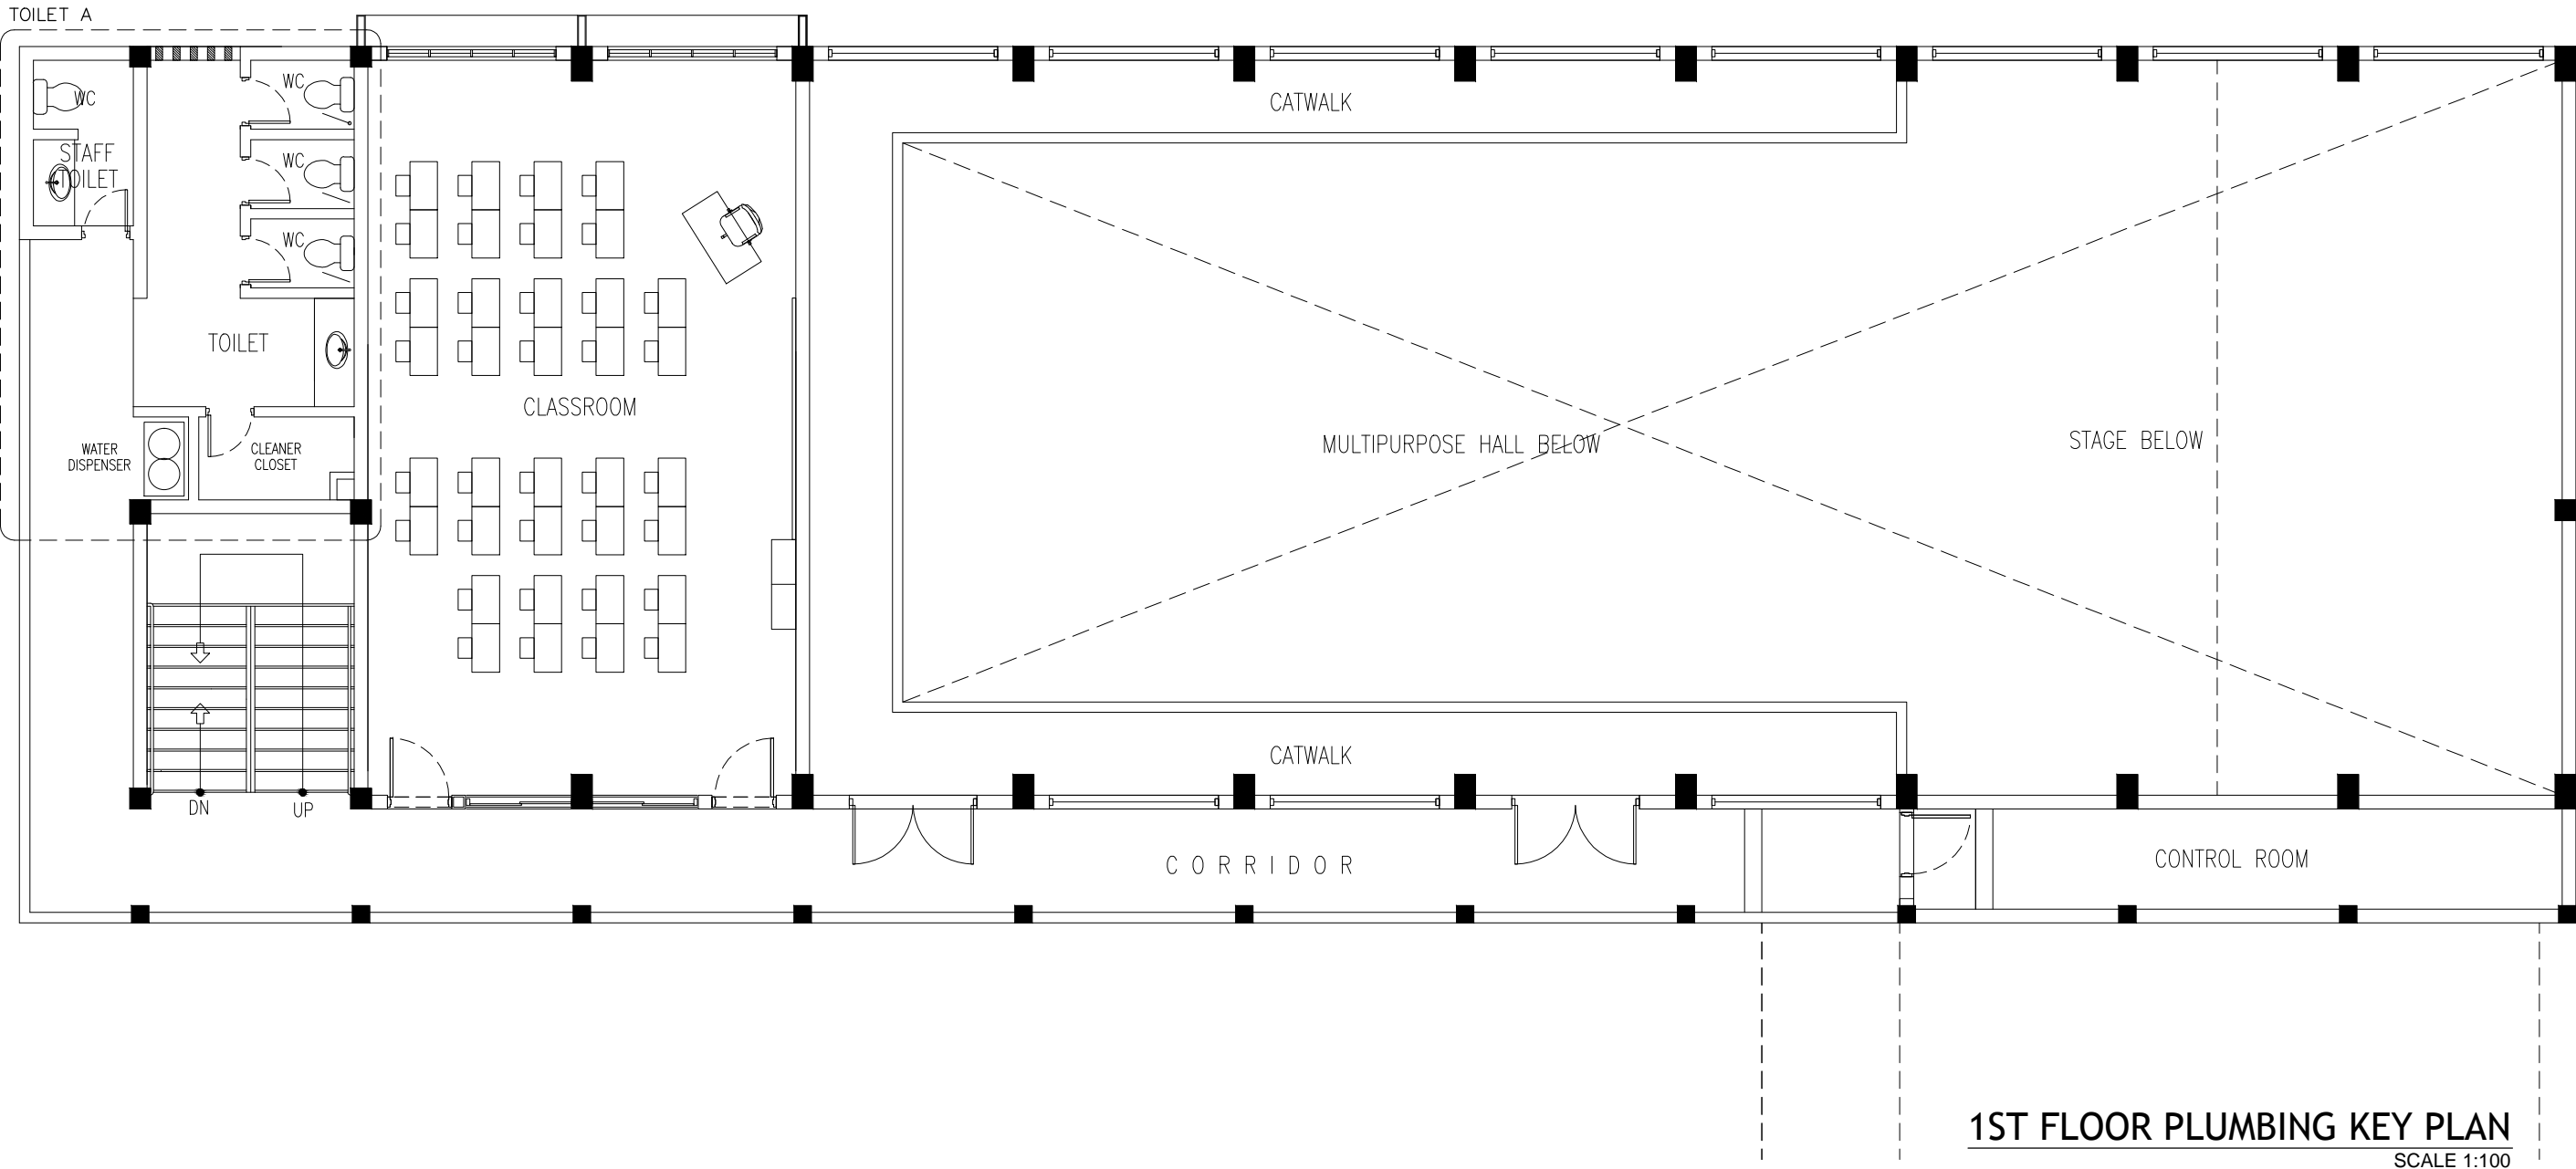CONTRACTORS MUST  
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ANY WORK OR SHOP  
DRAWINGS, FIGURED  
DIMENSIONS TO TAKE  
PRECEDENCE OVER  
SCALE READINGS



REVISION:	ARCHITECT: MOHAMED HAMEEN	PROJECT: 6 CLASSROOM BLOCK, MULTI PURPOSE HALL BLOCK IN MEYNAA SCHOOL	P-02
	ENGINEER: MOHAMED AHSAN	LOCATION: HA.HOLHUDHOO	
	SERVICES ENG:	DRAWING TITLE: AS GIVEN	
	ESTIMATOR:	CLIENT: MINISTRY OF EDUCATION	
	DRAWN BY:	SCALE: AS GIVEN    DIMENSION: MM    DATE: AUJJUST 2015	DWG NO
CONCEPT AND DESIGN IN THIS DRAWING ARE THE PROPERTIES OF ARCHENG STUDIO PVT LTD. UNAUTHORIZED USE OR REPRODUCTION OF PART OF THE DESIGN,DRAWINGS OR CONCEPT TO USE IN OTHER PROJECTS OR SITES OTHER THAN SPECIFIED ON THIS DRAWING IS PROHIBITED			PROJECT NO.: 14-124





2ND FLOOR PLUMBING KEY PLAN  
SCALE 1:100

CONTRACTORS MUST  
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BEFORE STARTING  
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DRAWINGS, FIGURED  
DIMENSIONS TO TAKE  
PRECEDENCE OVER  
SCALE READINGS




REVISION:	

ARCHITECT:	MOHAMED HAMEEN
ENGINEER:	MOHAMED AHSAN
SERVICES ENG:	
ESTIMATOR:	
DRAWN BY:	


PROJECT:	6 CLASSROOM BLOCK, MULTI PURPOSE HALL BLOCK IN MEYNAA SCHOOL		
LOCATION:	HA, HOLHUDHOO		
DRAWING TITLE:	AS GIVEN		
CLIENT:	MINISTRY OF EDUCATION		
SCALE:	AS GIVEN	DIMENSION:	MM
		DATE:	AUGUST 2015

P-03
DWG NO
PROJECT NO.: 14-124

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WASTE DISPOSAL AND DRAIN  
PIPE PLAN (TOILET A)  
SCALE 1:50

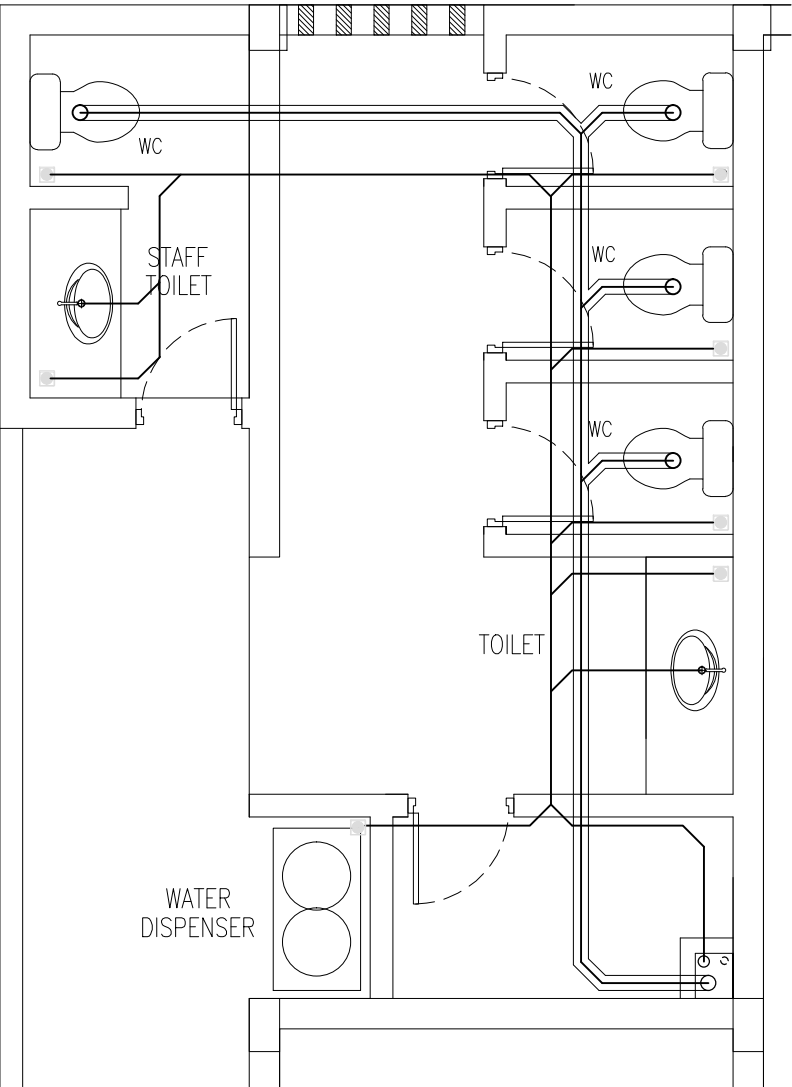


FRESH WATER SUPPLY PLAN  
(TOILET A)  
SCALE 1:50

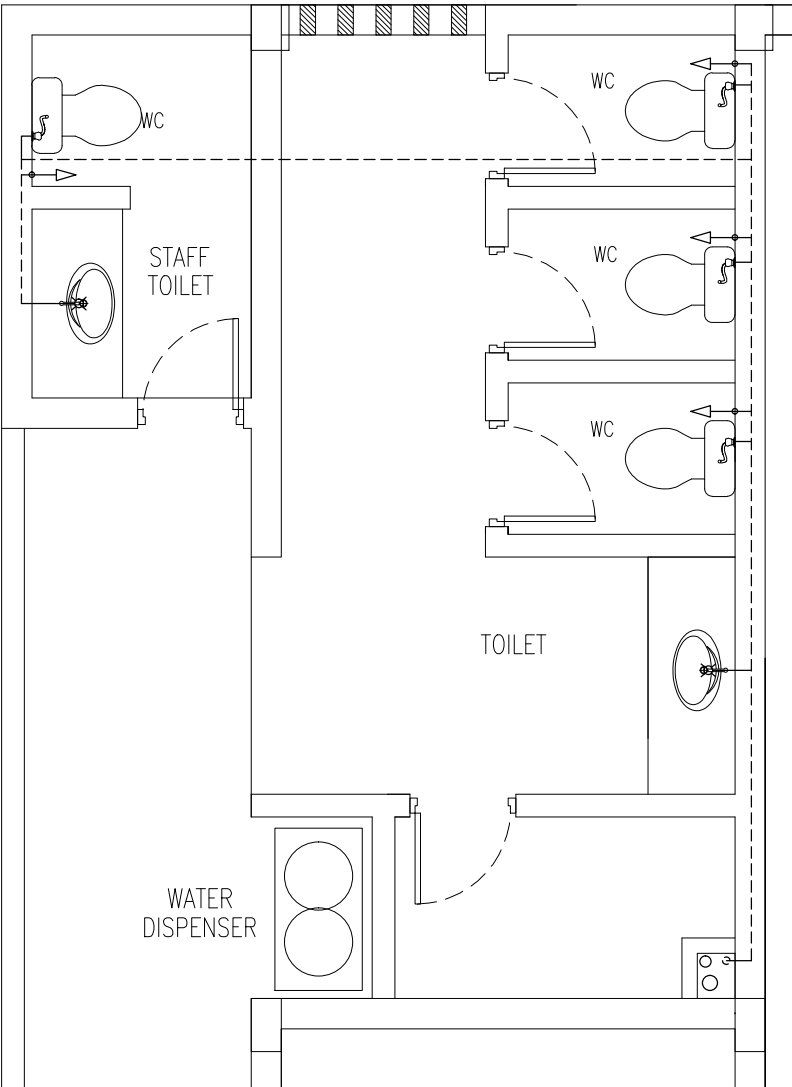
CONTRACTORS MUST  
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DIMENSIONS TO TAKE  
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SCALE READINGS




REVISION:	ARCHITECT: MOHAMED HAMEEN	PROJECT: 6 CLASSROOM BLOCK, MULTI PURPOSE HALL BLOCK IN MEYNAA SCHOOL	P-04
	ENGINEER: MOHAMED AHSAN	LOCATION: HA,HOLHUDHOO	
	SERVICES ENG:	DRAWING TITLE: AS GIVEN	
	ESTIMATOR:	CLIENT: MINISTRY OF EDUCATION	
	DRAWN BY:	SCALE: AS GIVEN      DIMENSION: MM      DATE: AUJUST 2015	
CONCEPT AND DESIGN IN THIS DRAWING ARE THE PROPERTIES OF ARCHENG STUDIO PVT LTD. UNAUTHORIZED USE OR REPRODUCTION OF PART OF THE DESIGN DRAWINGS OR CONCEPT TO USE IN OTHER PROJECTS OR SITES OTHER THAN SPECIFIED ON THIS DRAWING IS PROHIBITED			
			DWG NO PROJECT NO.: 14-124

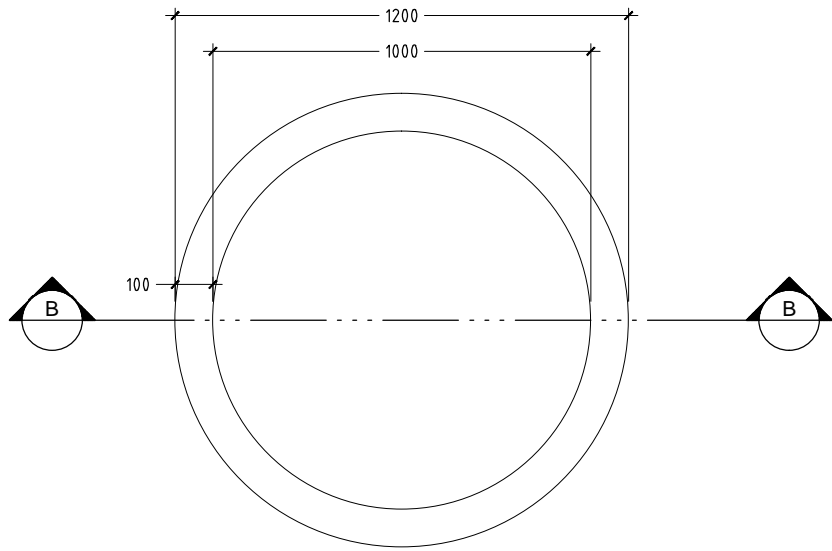


**DETAIL B/ PLAN VIEW OF WELL**  
**SCALE 1 : 20**

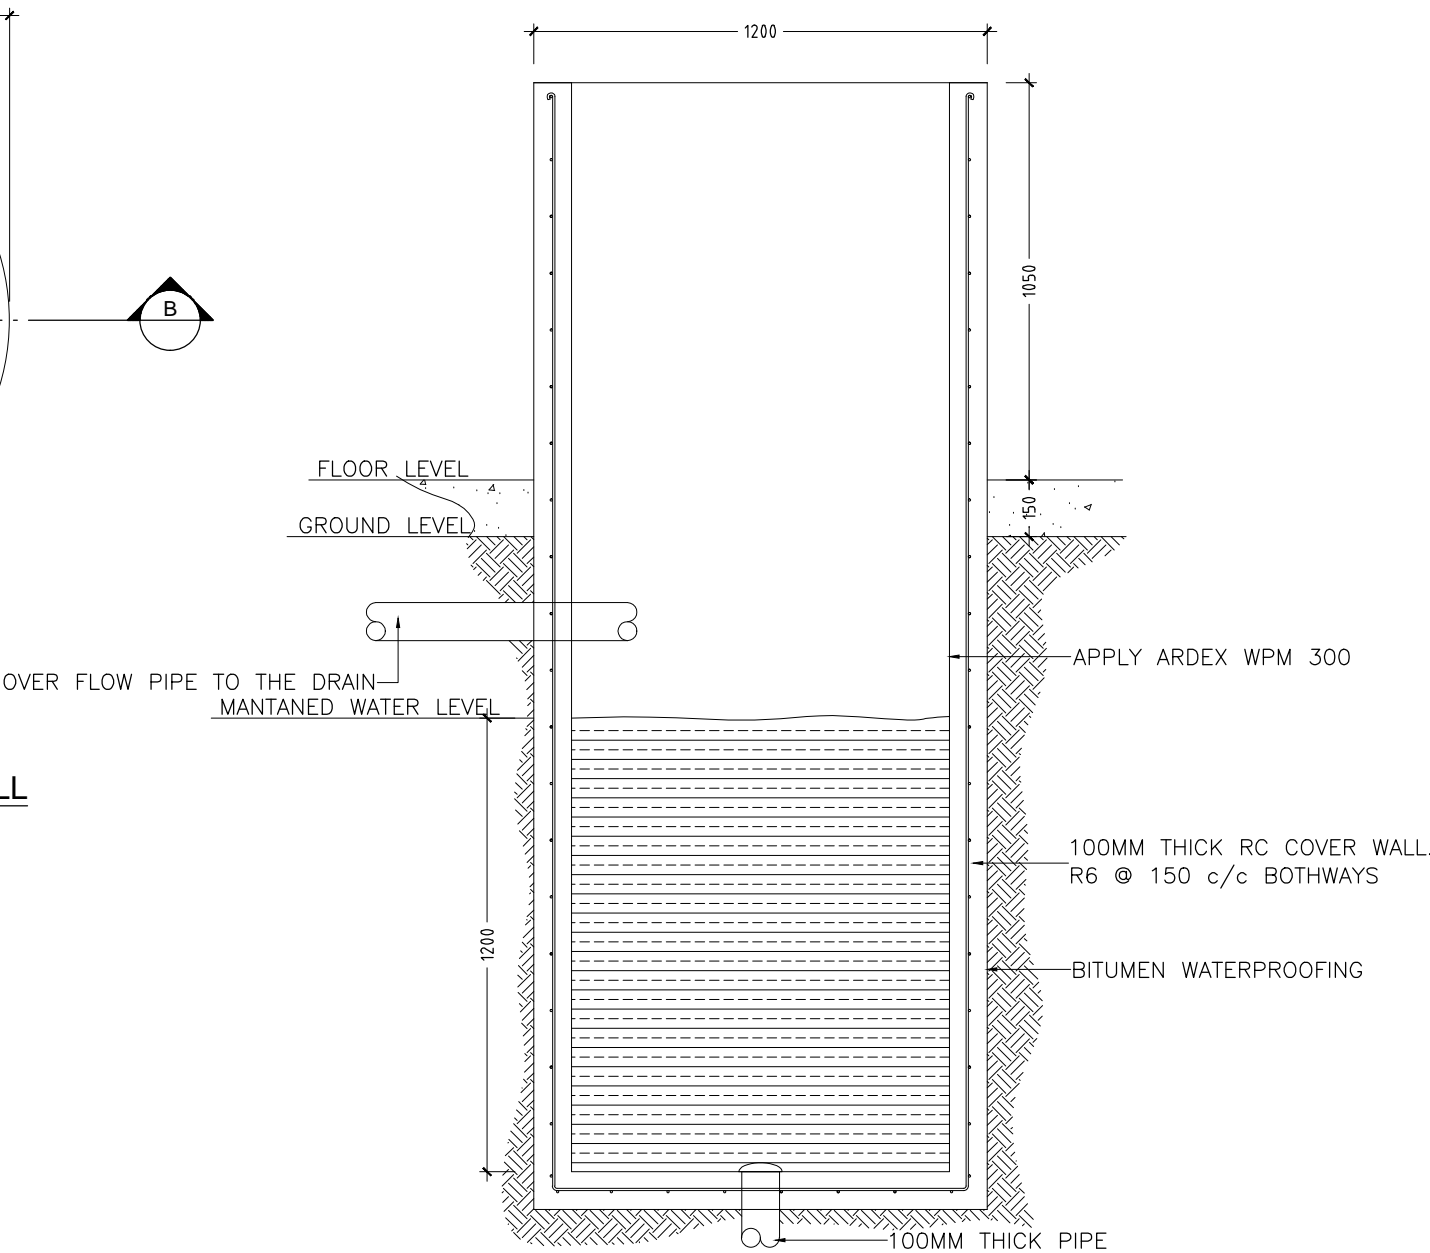

**DETAIL B/ SECTION A-A OF WELL**  
**SCALE 1 : 20**

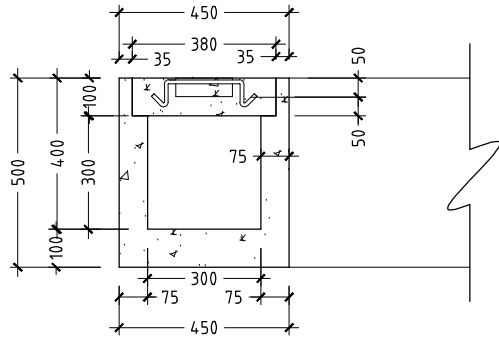

**DETAIL A/ SECTION A-A**  
**SCALE 1 : 20**

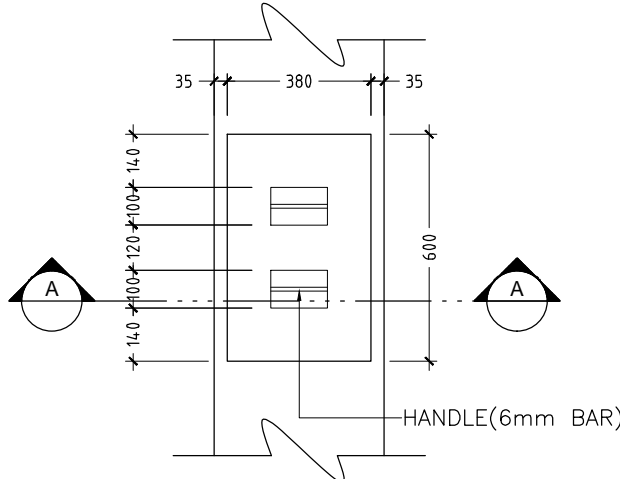

**DETAIL A / PLAN VIEW OF INSPECTION POINT**  
**SCALE 1 : 20**

CONTRACTORS MUST  
 CHECK ALL  
 DIMENSIONS ON SITE  
 BEFORE STARTING  
 ANY WORK OR SHOP  
 DRAWINGS,FIGURED  
 DIMENSIONS TO TAKE  
 PRECEDENCE OVER  
 SCALE READINGS




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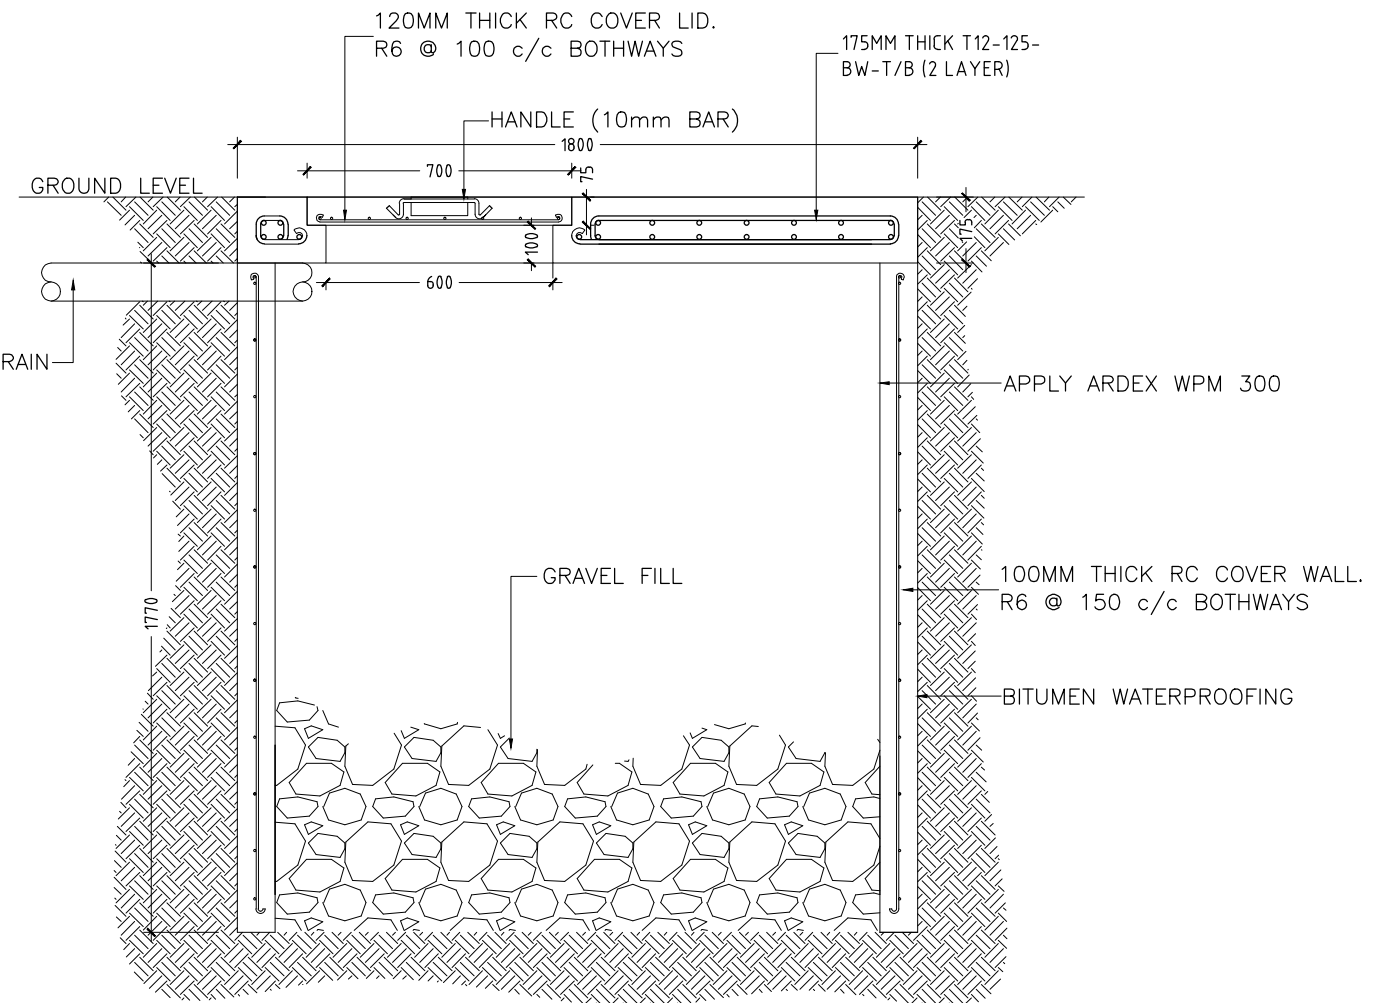
ARCHITECT:	MOHAMED HAMEEN
ENGINEER:	MOHAMED AHSAN
SERVICES ENG:	
ESTIMATOR:	
DRAWN BY:	

PROJECT:	6 CLASSROOM BLOCK, MULTI PURPOSE HALL BLOCK IN MEYNAA SCHOOL
LOCATION:	HA,HOLHUDHOO
DRAWING TITLE:	AS GIVEN
CLIENT:	MINISTRY OF EDUCATION
SCALE:	AS GIVEN
DIMENSION:	MM
DATE:	AUJUST 2015

P-05
DWG NO
PROJECT NO.: 14-124

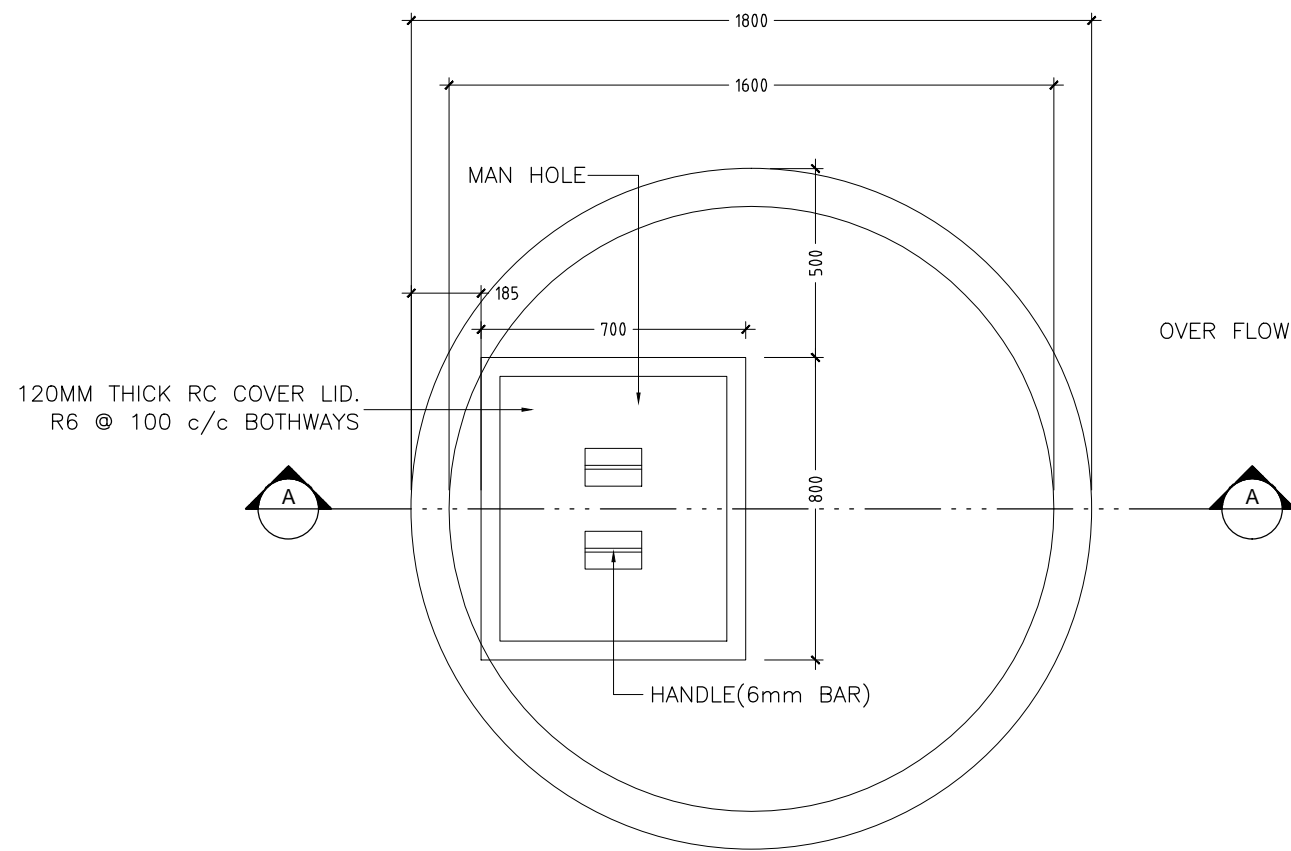

DETAIL A/ PLAN VIEW OF SOAK PIT TANK  
SCALE 1 : 20



DETAIL A/ SECTION A-A OF SOAK PIT TANK  
SCALE 1 : 20

CONTRACTORS MUST  
CHECK ALL  
DIMENSIONS ON SITE  
BEFORE STARTING  
ANY WORK OR SHOP  
DRAWINGS. FIGURED  
DIMENSIONS TO TAKE  
PRECEDENCE OVER  
SCALE READINGS

**ArchEng**  
studio  
Ma Fiyajahaage, 1st floor, Male', Republic of Maldives  
admin@archeng.biz

REVISION:

ARCHITECT: MOHAMED HAMEEN

ENGINEER: MOHAMED AHSAN

SERVICES ENG:

ESTIMATOR:

DRAWN BY:

PROJECT: 6 CLASSROOM BLOCK, MULTI PURPOSE HALL BLOCK IN MEYNAA SCHOOL

LOCATION: HA, HOLHUDHOO

DRAWING TITLE: AS GIVEN

CLIENT: MINISTRY OF EDUCATION

SCALE: AS GIVEN

DIMENSION: MM

DATE: AUGUST 2015

**P-06**

DWG NO

PROJECT NO.: 14-124

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