# PROPOSED SINGLE STOREY FERRY TERMINAL H.DH KULHUDHUFUSHI

**SERVICES DRAWINGS** 

JANUARY 2018

CLIENT: MINISTRY OF HOUSING AND INFRASTRUCTURE

**DESIGN BY** 



# P21X3 P21X<u>3</u> iL15 L07 L07 L07 6----L15 E15 įL15 **6** L15

NOTE:

1. PAINT CONDUITS, PIPES, HANGERS AND OTHER MECHANICAL AND ELECTRICAL EQUIPMENTS OCCURRING IN FINISHED AREAS SHOULD MATCH THE TEXTURE OF THE ADJACENT SURFACES.

2. PAINT OF THE DUCTWORKS FOR ALL ELECTRICAL CONDUITS SHOULD MATCH WITH THE ADJACENT SURFACES

3. ENSURE THE MODELS OF ELECTICAL COMPONETS SUCH AS LIGHTS AND FANS ARE ACCORDING TO THE SPECIFICATION GIVEN.

#### LEGEND

SYMBOL	CODE	DESCRIPTION
	L07	2X36W FLUORESCENT LAMPS IN SURFACE MOUNT LUMINAIRE WITH DIFFUSER /LED
•	L06	SUSPENDED LUMINAIRE WITH INTERNALLY RIBBED ANODISED REFLECTOR
9	L15	1X60W INCANDESCENT LAMPS IN RECESSED DECORATIVE LUMINAIRE
	L17	1X60W INCANDESCENT LAMPS IN SURFACE MOUNT WEATHER PROOF LUMINAIRE
6	P19	1GANG 1 WAY SWITCH
5	P20	2GANG 1 WAY SWITCH
<i>F</i>	P21	3GANG 1 WAY SWITCH
F	P22	4GANG 1 WAY SWITCH

## LIGHTING LAYOUT FLOOR PLAN SCALE: 1:100



PRINCIPAL ARCHITECT: MOHAMED HAMEEN
 ARCHITECT: AHMED AMEEL SHAKEEL
 PRINCIPAL ENGINEER: MOHAMED AHSAN
ENGINEER: SHAUFA AHMED
DDAMN DV: MALEEUA IDDAUIM

_	PROJECT:	SINGLE STOREY FERRY T	ERMINAL	
	LOCATION:	HDH. KULHUDUFUSHI		E-01
_	DRAWING TITLE:	AS GIVEN		E-U I
_	CLIENT: MINISTRY	OF HOUSING AND INFRAS	TRUCTURE	DWG NO
	SCALE: AS GIVEN	DIMENSION: MM	DATE: JAN 2018	PROJECT NO:

# P23X2<sup>®</sup> P23X3<sup>®</sup> V01 V05X2 V05X2

#### NOTE:

1. PAINT CONDUITS, PIPES, HANGERS AND OTHER MECHANICAL AND ELECTRICAL EQUIPMENTS OCCURRING IN FINISHED AREAS SHOULD MATCH THE TEXTURE OF THE ADJACENT SURFACES. 2. PAINT OF THE DUCTWORKS FOR ALL ELECTRICAL CONDUITS SHOULD MATCH WITH THE ADJACENT SURFACES 3. ENSURE THE MODELS OF ELECTICAL COMPONETS SUCH AS LIGHTS AND FANS ARE ACCORDING TO THE SPECIFICATION GIVEN.

#### LEGEND


ø	P23	FAN / LIGHT DIMMER SWITCH
	V01	DIA. 1200 CEILING FAN
	V03	KITCHEN HOOD
-	V05	AIR-CONDITIONING OUTDOOR UNIT WALL MOUNTED
-	V07	AIR—CONDITIONING INDOOR UNIT WALL MOUNTED

FAN/AC LAYOUT FLOOR PLAN SCALE: 1:100



REVISION:	PRINCIPAL ARCHITECT: MOHAMED HAMEEN
	ARCHITECT: AHMED AMEEL SHAKEEL
	PRINCIPAL ENGINEER: MOHAMED AHSAN
	ENGINEER: SHAUFA AHMED
	DRAWN BY: MALEEHA IBRAHIM

PROJECT:	SINGLE STOREY FERRY T	ERMINAL	
LOCATION:	HDH. KULHUDUFUSHI		
DRAWING TITLE:	AS GIVEN		E-02
CLIENT: MINISTRY	OF HOUSING AND INFRAS	TRUCTURE	DWG NO
SCALE: AS GIVEN	DIMENSION: MM	DATE: JAN 2018	PROJECT NO:

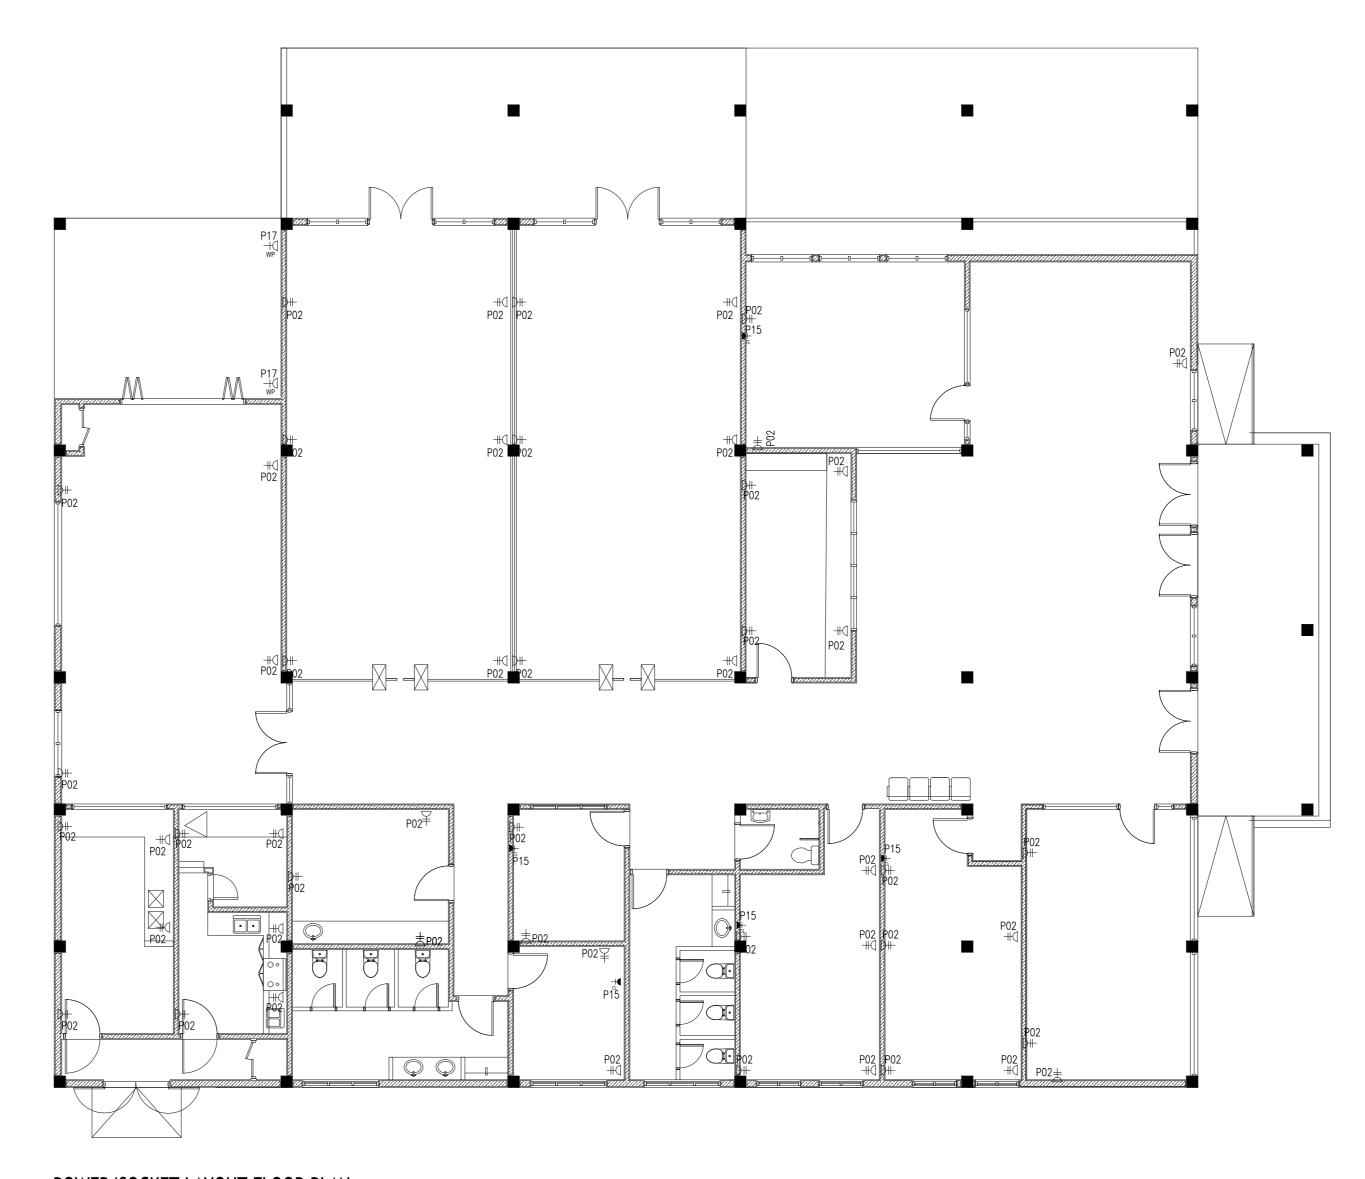

#### NOTE:

1. PAINT CONDUITS, PIPES, HANGERS AND OTHER MECHANICAL AND ELECTRICAL EQUIPMENTS OCCURRING IN FINISHED AREAS SHOULD MATCH THE TEXTURE OF THE ADJACENT SURFACES.

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#### LEGEND


D#	P02	2 GANG13A SOCKET OUTLET AT 300mm ABOVE FINISHED FLOOR LEVEL
D <del> </del>	P17	1 GANG13A SOCKET OUTLET AT 300mm ABOVE FINISHED FLOOR LEVEL (WEATHER PROOF)
D+- cı.	P15	1 GANG15A SOCKET OUTLET AT CEILING LEVEL

# POWER/SOCKET LAYOUT FLOOR PLAN SCALE: 1:100



ISION:	PRINCIPAL ARCHITECT: MOHAMED HAMEEN
	ARCHITECT: AHMED AMEEL SHAKEEL
	PRINCIPAL ENGINEER: MOHAMED AHSAN
	ENGINEER: SHAUFA AHMED
	DRAWN BY: MALEEHA IBRAHIM

_				
	PROJECT:	SINGLE STOREY FERRY T	ERMINAL	
	LOCATION:	HDH. KULHUDUFUSHI		
_	DRAWING TITLE:	AS GIVEN		<b>E-03</b>
_	CLIENT: MINISTRY	OF HOUSING AND INFRAS	TRUCTURE	DWG NO
	SCALE: AS GIVEN	DIMENSION: MM	DATE: JAN 2018	PROJECT NO:

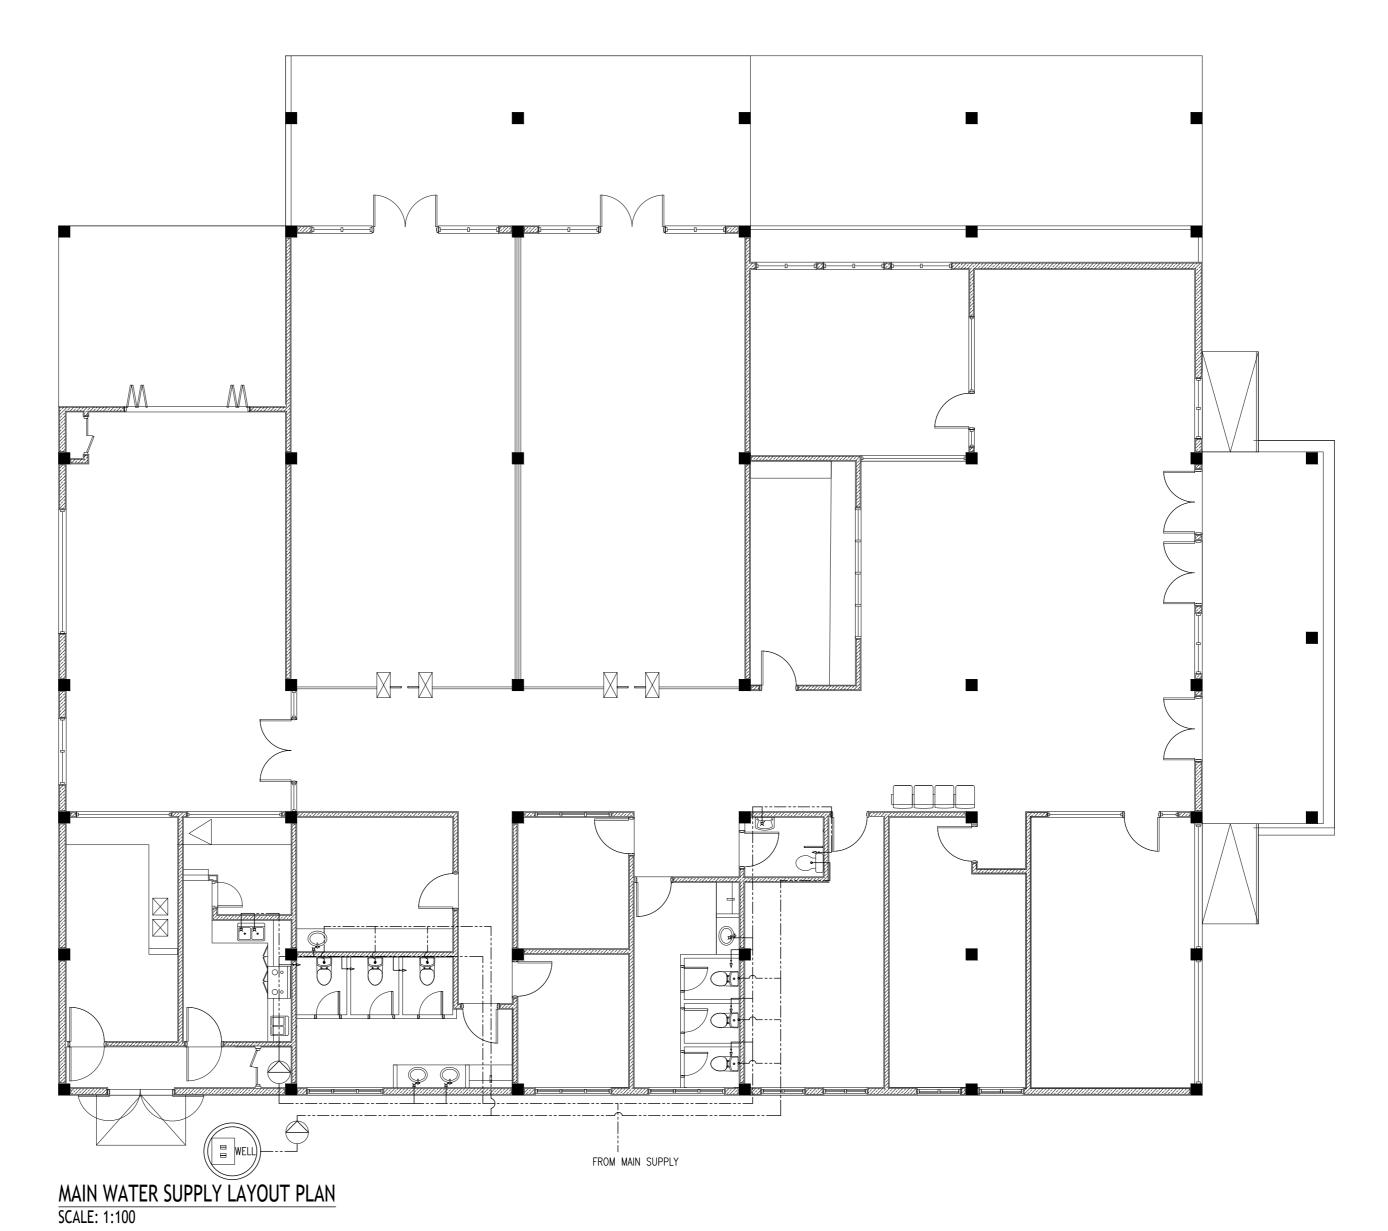

#### LEGEND

<b>→</b> ¤	FAUCET/TAP
•—>	HAND SHOWER
	GROUND WATER SUPPLY Ø12-Ø35)

WAPCOS LIMITED
(भारत सरकार का उपक्रम)
जल संस्थान, नदी विकास व गंगा संस्थान मंत्रालय
(A Government of India Undertaking)
Ministry of Water Resources. River precipenment & Gangas Reluvenation

REVISION:

PRINCIPAL ARCHITECT: MOHAMED HAMEEN

ARCHITECT: AHMED AMEEL SHAKEEL

PRINCIPAL ENGINEER: MOHAMED AHSAN

ENGINEER: SHAUFA AHMED

DRAWN BY: MALEEHA IBRAHIM

PROJECT: SINGLE STOREY FERRY TERMINAL

LOCATION: HDH. KULHUDUFUSHI


DRAWING TITLE: AS GIVEN

CLIENT: MINISTRY OF HOUSING AND INFRASTRUCTURE

SCALE: AS GIVEN

DIMENSION: MM DATE: JAN 2018

PROJECT NO:

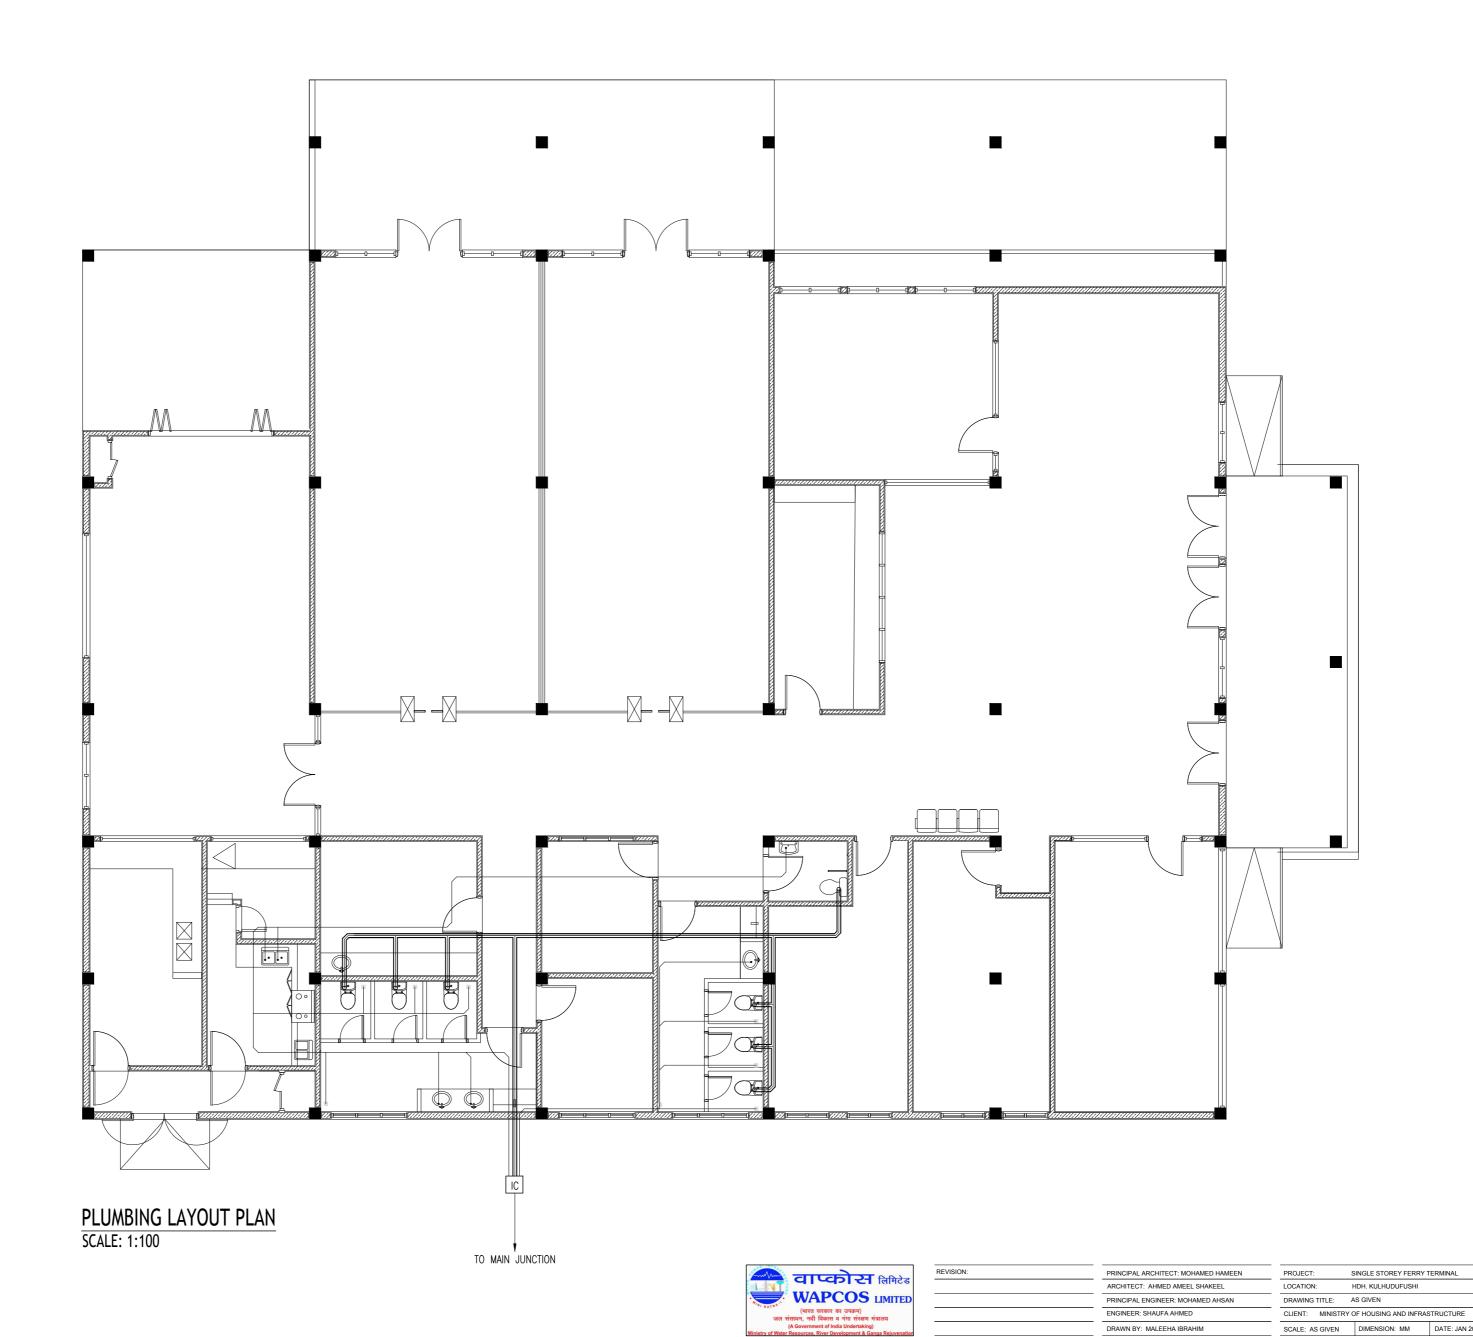

P-02


PROJECT NO:

SCALE: AS GIVEN DIMENSION: MM DATE: JAN 2018

DRAWN BY: MALEEHA IBRAHIM

#### LEGEND

	SEWAGE DISPOSAL (Ø100
	WASTE PIPE (Ø75)
IC	INSPECTION CHAMBER
	FLOOR DRAIN

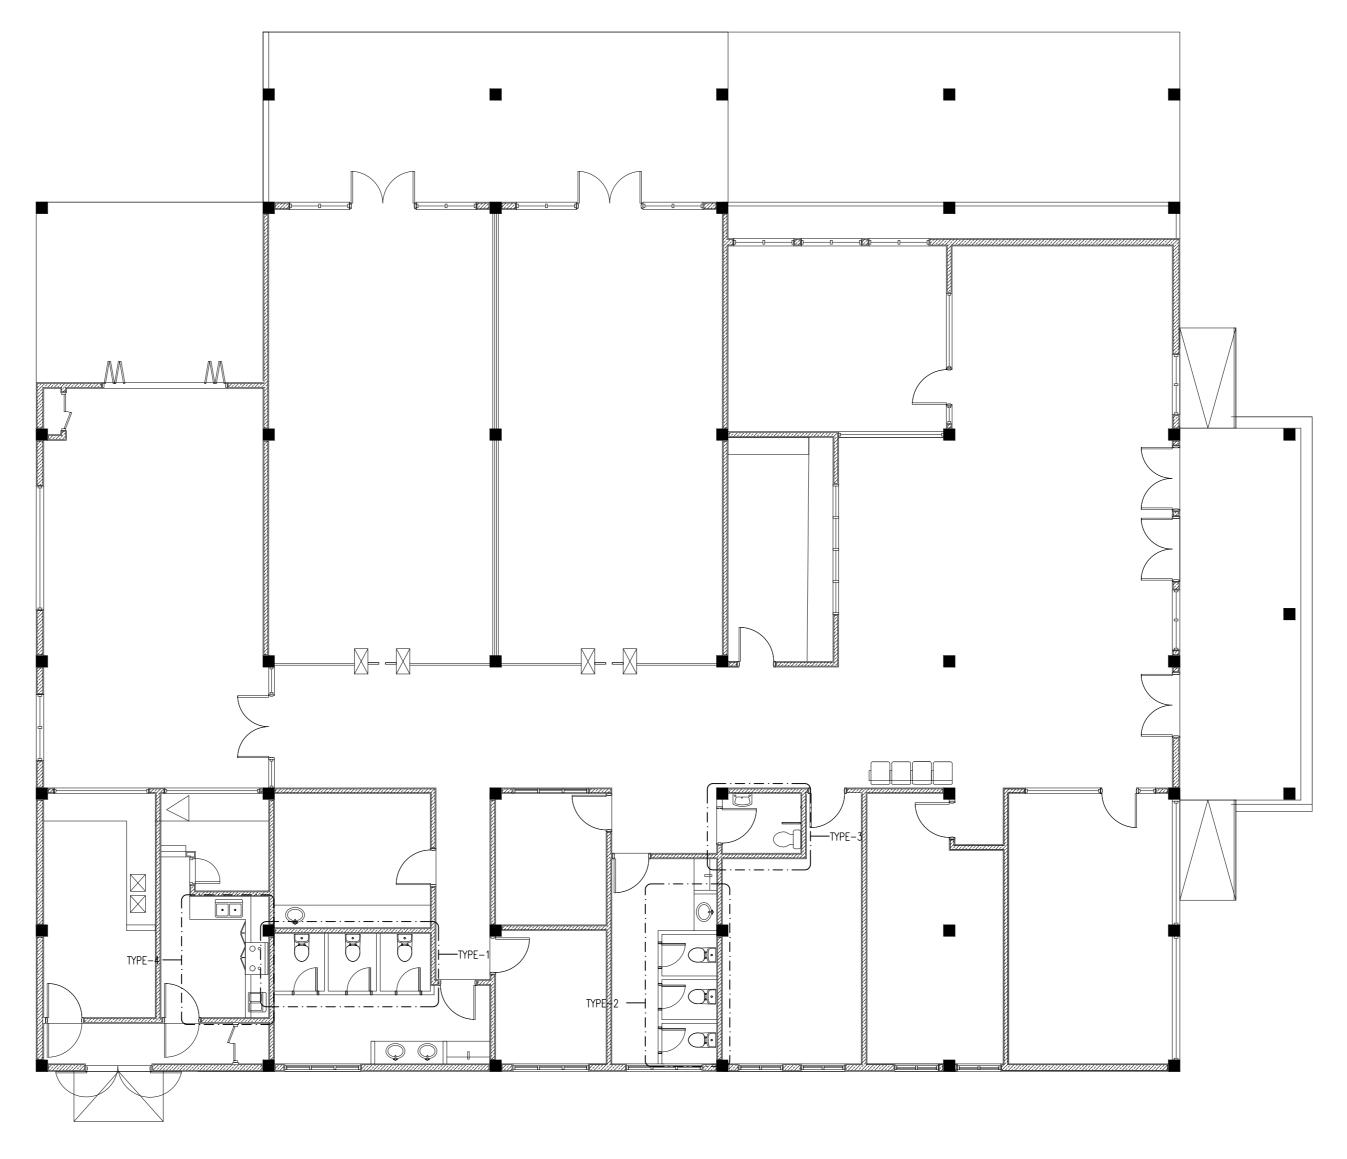

PLUMBING KEY PLAN SCALE: 1:100



REVISION:	PRINCIPAL ARCHITECT: MOHAMED HAMEEN
	ARCHITECT: AHMED AMEEL SHAKEEL
	PRINCIPAL ENGINEER: MOHAMED AHSAN
	ENGINEER: SHAUFA AHMED
	DDAWN DV. MALEEUA IDDAUM

	LOCATION:	OCATION: HDH. KULHUDUFUSHI		
_	CLIENT: MINISTRY	OF HOUSING AND INFRAS	TRUCTURE	DWG NO
	SCALE: AS GIVEN	DIMENSION: MM	DATE: JAN 2018	PROJECT NO:

#### **SEWAGE**

#### LEGEND

SYMBOL	DESCRIPTION	
IC	INSPECTION CHAMBER	
$\otimes$	CLEAN-OUT EYE	
FLOOR DRAIN		
	UPVC HIGH PRESSURE WASTE WATER PIPE(Ø75-Ø100)	
	SEWAGE DISPOSAL (Ø100-Ø150 )	
Image: control of the	P TRAP	

#### NOTE:

- GROUND WATER FOR WC
- MWSC WATER TAP NEAR WC (MUSLIM SHOWER)
- MWSC WATER FOR SHOWER HEAD
- MWSC WATER FOR WASH BASIN
- ALL THE CONNECTIONS SHOULD BE DONE THROUGH GATE VALVES
- MWSC WATER TO BE PROVIDED TO ALL KITCHENS SINKS
- PROVIDE CLEAN OUT EYE FOR ALL INTERNAL PLUMBING
   FOR BOTH SEWER LINE AND WASTE WATER LINE
- PROVIDE VENT PIPE FOR WASTE WATER LINE AND SEWAGE PIPES


#### MWSC WATER METRE


FOR EACH APARTMENT THERE WILL BE A SEPARATE WATER METER, MWSC WATER IS PROVIDED TO ALL THE FLOORS DIRECTLY FROM THE MWSC WATER METRES LOCATED ON THE GROUND FLOOR


#### **WATER SUPPLY**

LEGEND

SYMBOL	DESCRIPTION
82	MWSC WATER SUPPLY METER
<b>⊕</b> ¤	TAP
<b>\$</b>	SHOWER
<b>♦</b> —▷	MUSLIM SHOWER
H	ISOLATING VALVE
×	GATE VALVE
	MWSC WATER SUPPLY (Ø12-Ø35)
	HOT WATER SUPPLY (Ø12-Ø35)
	GROUND WATER SUPPLY (Ø12-Ø35)
	WATER PUMP
HEATER OUT IN	WATER HEATER

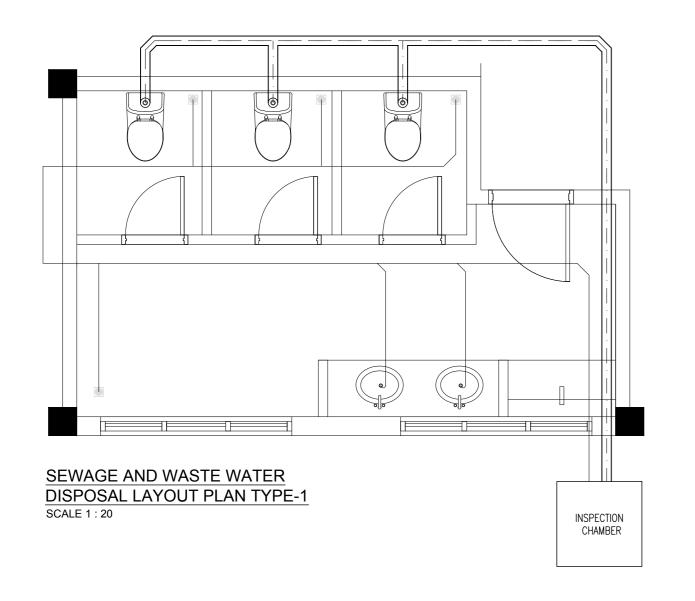


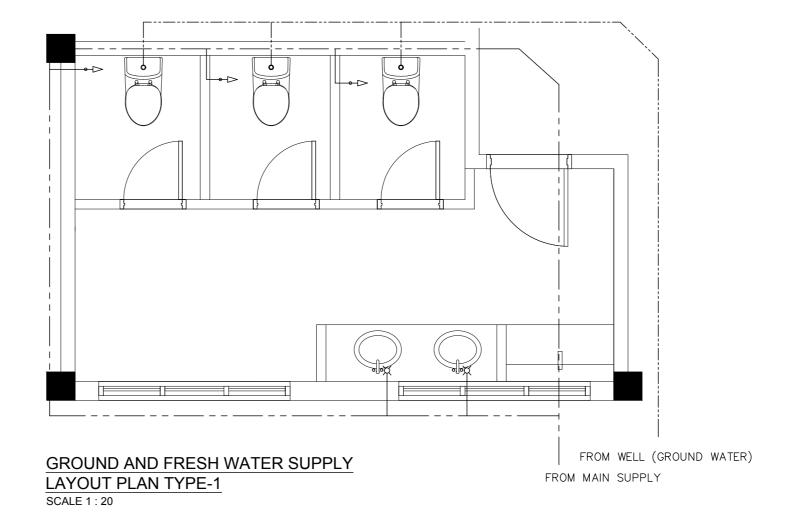


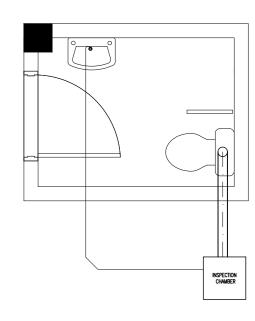


SEWAGE AND WASTE WATER DISPOSAL LAYOUT PLAN TYPE -3 SCALE 1 : 20



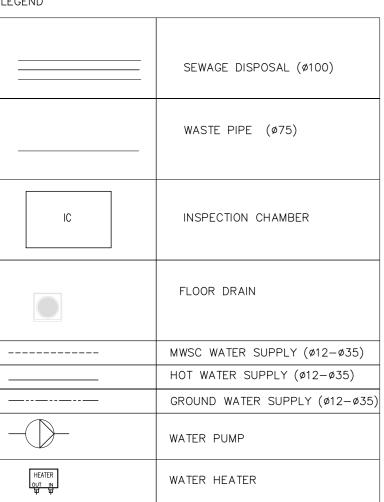


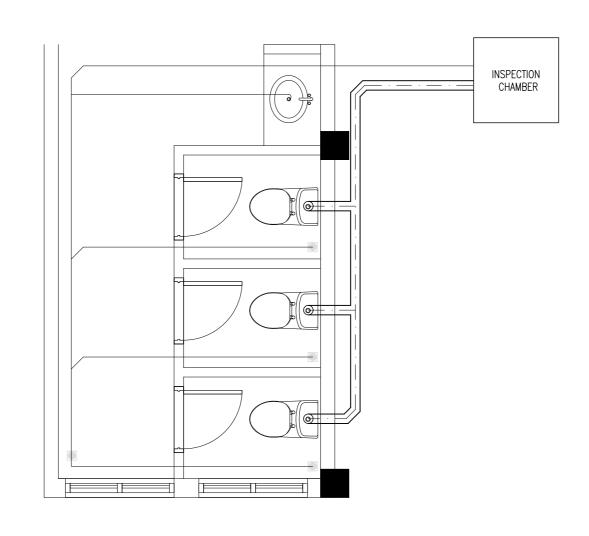

SEWAGE AND WASTE WATER DISPOSAL LAYOUT PLAN TYPE -2 SCALE 1:20

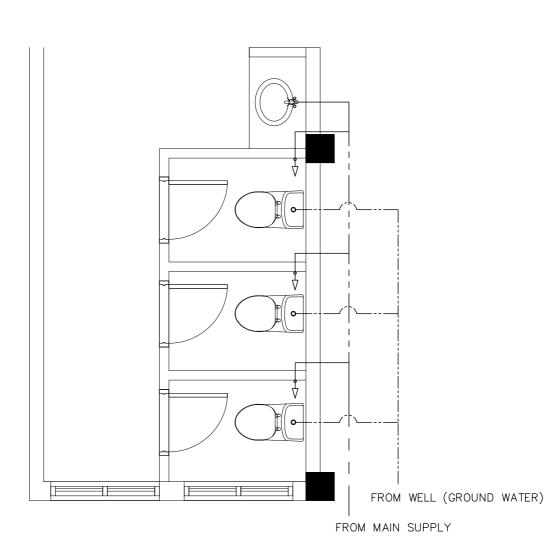

**GROUND AND FRESH WATER SUPPLY** LAYOUT PLAN TYPE -2 SCALE 1:20

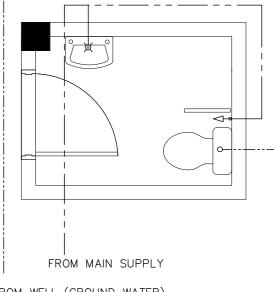

FROM WELL (GROUND WATER)


**GROUND AND FRESH WATER SUPPLY** LAYOUT PLAN TYPE-3

SCALE 1 : 20



EVISION:	PRINCIPAL ARCHITECT: MOHAMED I
	ARCHITECT: AHMED AMEEL SHAKE
	PRINCIPAL ENGINEER: MOHAMED A
	ENGINEER: SHAUFA AHMED

PROJECT:	SINGLE STOREY FERRY	TERMINAL	
LOCATION:	HDH. KULHUDUFUSHI		<b>D</b> 0.4
DRAWING TITLE:	AS GIVEN		P-04
CLIENT: MINIST	RY OF HOUSING AND INFRA	ASTRUCTURE	DWG NO
SCALE: AS GIVEN	DIMENSION: MM	DATE: JAN 2018	PROJECT NO:

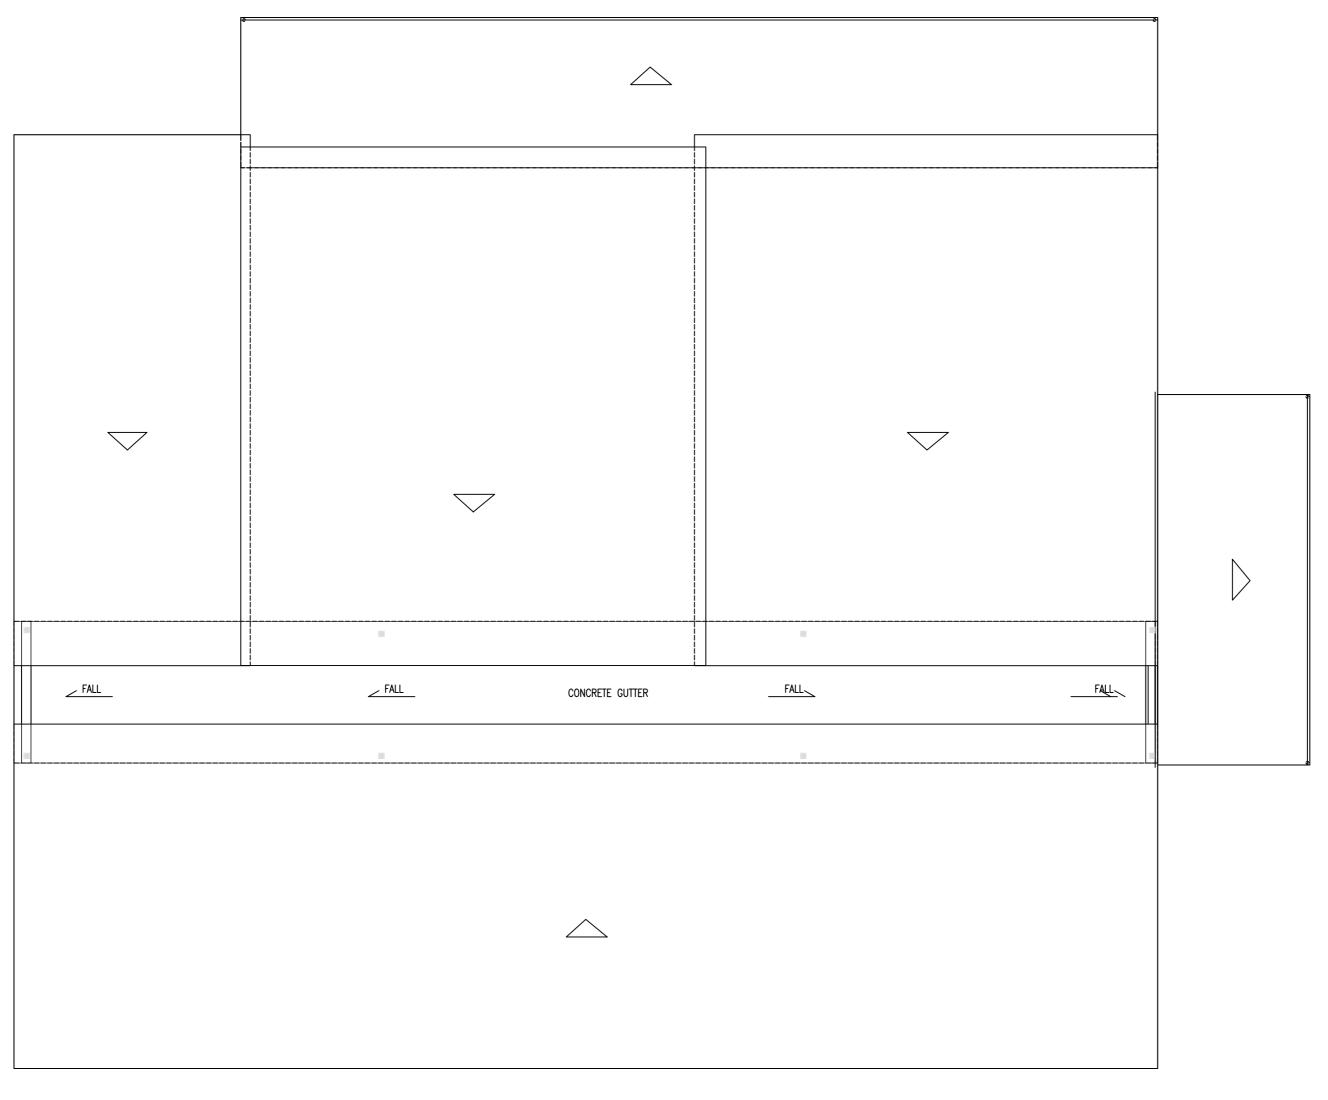

LEGEND

SEWAGE DISPOSAL (Ø100)

WASTE PIPE (Ø75)


IC INSPECTION CHAMBER


FLOOR DRAIN


DRAINAGE LAYOUT PLAN SCALE: 1:100




निटेड	REVISION:	PRINCIPAL ARCHITECT: MOHAMED HAMEEN
आमटड		ARCHITECT: AHMED AMEEL SHAKEEL
MITED		PRINCIPAL ENGINEER: MOHAMED AHSAN
व		ENGINEER: SHAUFA AHMED

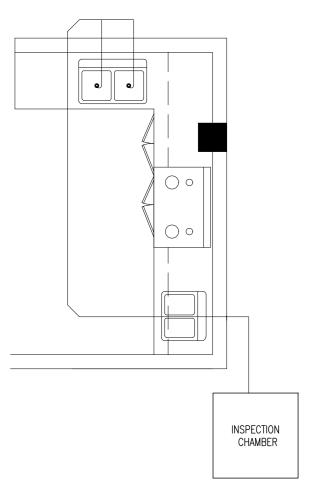

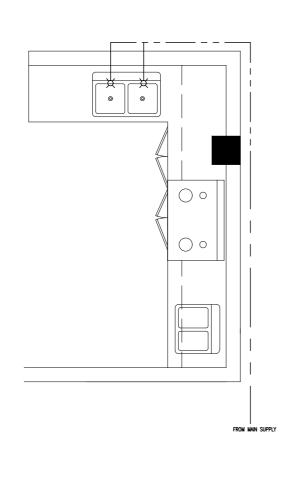

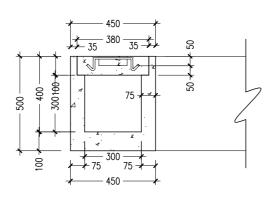

DETAIL A/ SECTION A-A SCALE 1 : 20

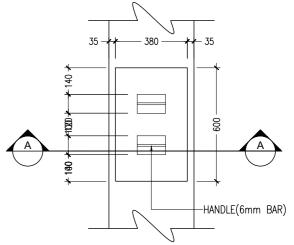

DETAIL A / PLAN VIEW OF INSPECTION
CHAMBER
SCALE 1: 20


### SEWAGE AND WASTE WATER DISPOSAL LAYOUT PLAN TYPE -4


SCALE 1 : 20

## SEWAGE AND WASTE WATER DISPOSAL LAYOUT PLAN TYPE -4 SCALE 1: 20

#### LEGEND

<b>→</b> ¤	FAUCET/TAP
•	HAND SHOWER
	GROUND WATER SUPPLY Ø12-Ø35)

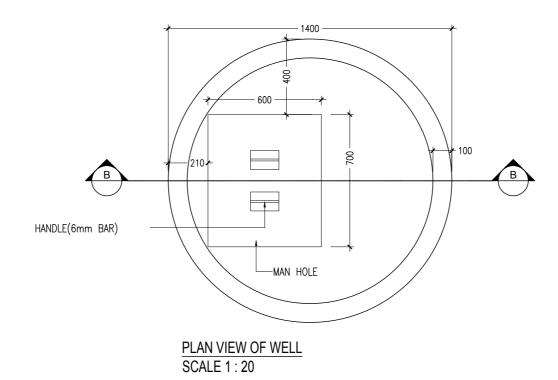

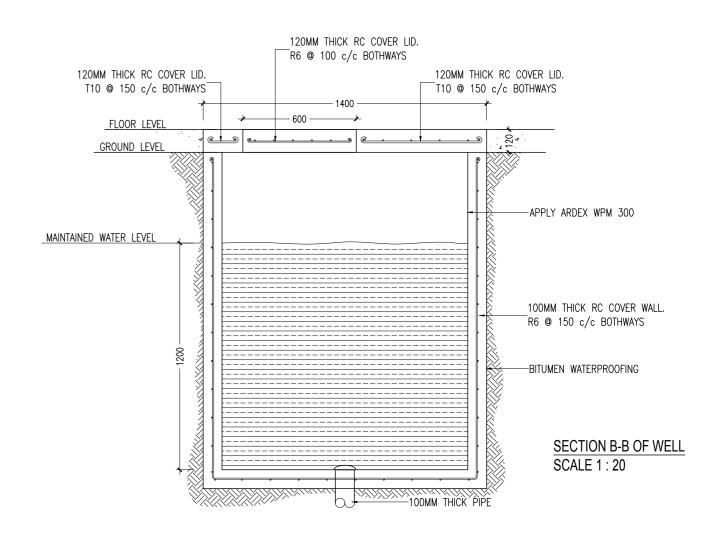


SECTION VIEW OF WELL SCALE 1:20



ION:	PRINCIPAL ARCHITECT: MOHAMED HAMEEN
	ARCHITECT: AHMED AMEEL SHAKEEL
	PRINCIPAL ENGINEER: MOHAMED AHSAN
	ENGINEER: SHAUFA AHMED

_	LOCATION:	OCATION: HDH. KULHUDUFUSHI		
	CLIENT: MINISTRY	OF HOUSING AND INFRAS	TRUCTURE	DWG NO
	SCALE: AS GIVEN	DIMENSION: MM	DATE: JAN 2018	PROJECT NO:

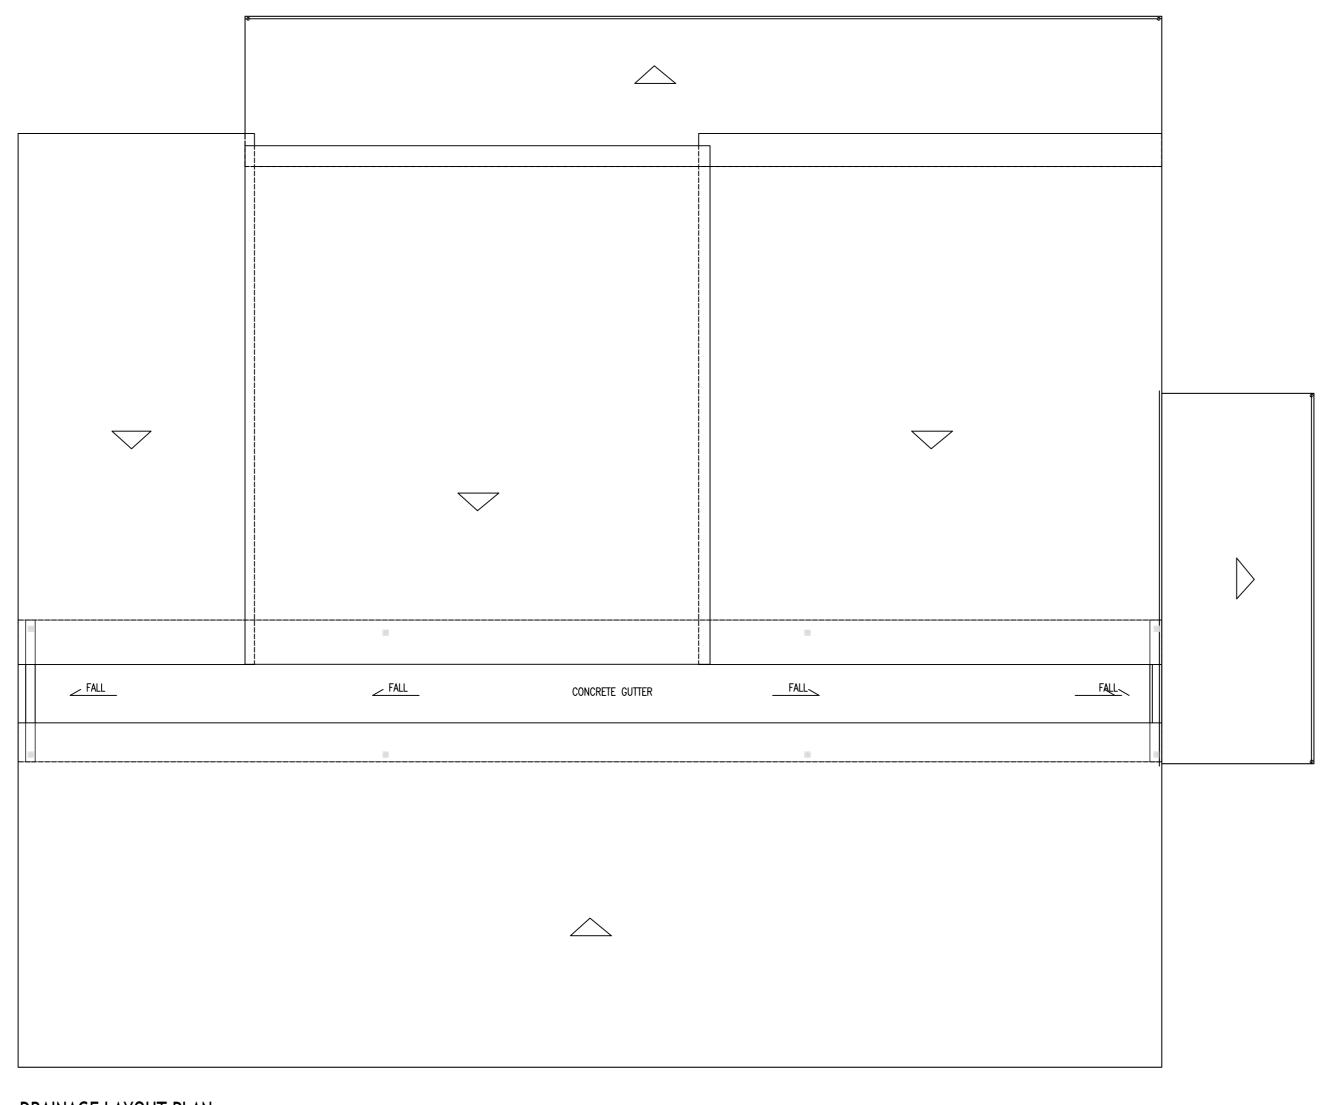

LEGEND

\_\_\_\_\_ SEWAGE DISPOSAL (Ø100) WASTE PIPE (Ø75) INSPECTION CHAMBER FLOOR DRAIN

DRAINAGE LAYOUT PLAN SCALE: 1:100



SION:	PRINCIPAL ARCHITECT: MOHAMED HAMEEN
	ARCHITECT: AHMED AMEEL SHAKEEL
	PRINCIPAL ENGINEER: MOHAMED AHSAN
	ENGINEER: SHAUFA AHMED
	DRAWN BY: MAI FEHA IBRAHIM

PROJECT: S	SINGLE STOREY FERRY T		
LOCATION: HDH. KULHUDUFUSHI		P-06	
DRAWING TITLE: AS GIVEN		P-00	
CLIENT: MINISTRY OF HOUSING AND INFRASTRUCTURE			DWG NO
SCALE: AS GIVEN DIMENSION: MM DATE: JAN 2018		PROJECT NO:	